
SYMBOL LEGEND SECTION TAG **ELEVATION TAG** NORTH ARROW **ROOM TAG** DOOR TAG 0000 P1 WALL TAG W1 WINDOW / LOUVER TAG REFER TO DRAWING NOTE ____1

LACTALIS AMERICAN GROUP INC.

OFFICE RENOVATIONS AT 2376 SOUTH PARK AVENUE

11/06/2025

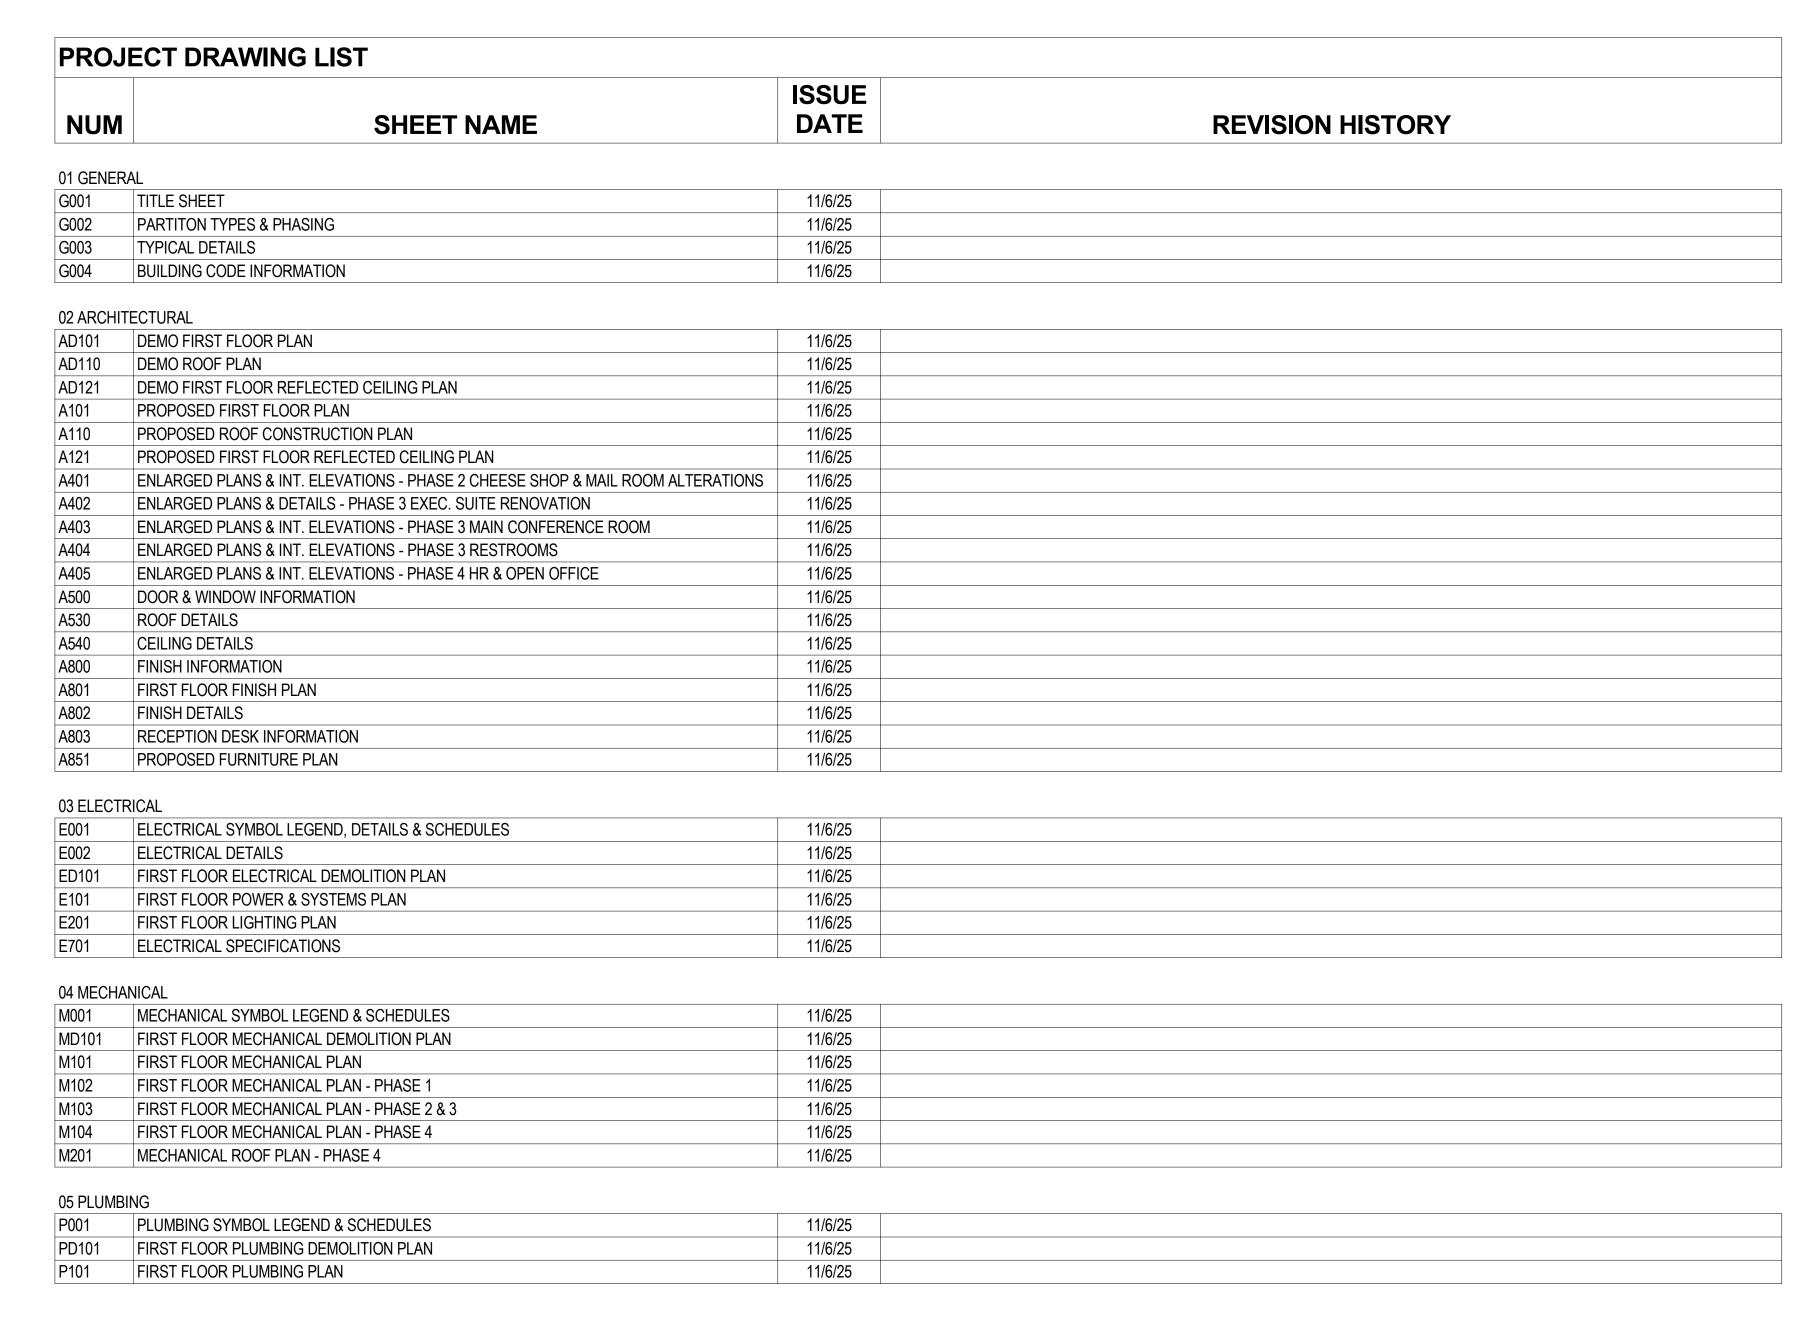



37 Franklin Street, Suite 100 Buffalo, New York 14202

P 716 883 4400 F 716 883 4268

TrautmanAssociates.com

Consultants

Signature & Seal:



SECTION 7209.2 OR 69.5(B) STATE

Client: LACTALIS AMERICAN GROUP

RENOVATIONS AT AVENUE

Project Address:


2376 SOUTH PARK AVENUE BUFFALO, NY 14220

Date Description

11/6/25 Project Number:

Sheet Title: TITLE SHEET



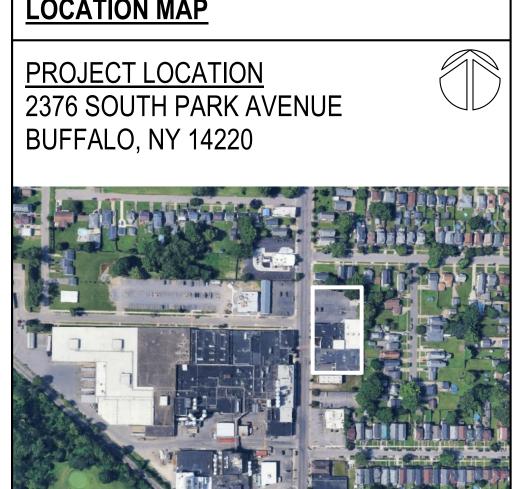

GENERAL NOTES:

EXISTING UTILITIES.

1. CONTRACT DOCUMENTS — ALL CONTRACTORS SHALL EXAMINE THE CONTRACT DOCUMENTS, AND REFERENCED, NON-CONTRACTUAL DOCUMENTS, AND SHALL BE INFORMED OF THE ENTIRE CONTENTS THEREOF PRIOR TO SUBMISSION OF PROPOSAL IMMEDIATELY BROUGHT TO THE ATTENTION OF THE ARCHITECT, PRIOR TO THE OF THE CITED ERROR OR AMBIGUITY.

NO SUBSEQUENT CLAIM FOR EXTRA WORK WILL BE ALLOWED ON ACCOUNT OF CLAIMED MISUNDERSTANDING OF THE MEANING OR INTENT OF THE CONTRACT DOCUMENTS OF ANY PORTION THEREOF IF THE ITEM OCCASIONING THE CLAIM APPEARED IN, OR WAS INFERABLE FROM SAID CONTRACT DOCUMENTS AS FURNISHED FOR BIDDING CONTRACTORS PROPOSE TO PROVIDE ALL REQUIRED MATERIALS, LABOR, AND EQUIPMENT NECESSARY TO COMPLETE THE WORK.

2. CODES — ALL WORK IS TO BE PERFORMED IN STRICT COMPLIANCE WITH THE REQUIREMENTS OF ALL GOVERNING CODES AND ORDINANCES, INCLUDING BUT NOT LIMITED TO THE 2020 BUILDING CODES OF NEW YORK STATE, ICC/ANSI 117.1-2017, OSHA REGULATIONS, AND ALL AGENCIES HAVING JURISDICTION OF THIS PROJECT.

3.EXISTING CONDITIONS — ALL CONTRACTORS SHALL FIELD VERIFY ALL EXISTING CONDITIONS, DIMENSIONS AND ELEVATIONS AT THE SITE PRIOR TO BID, COMMENCING WORK, AND FABRICATION OF ANY MATERIALS. CONTRACTORS SHALL REPORT ANY DISCREPANCIES BETWEEN DRAWINGS AND ACTUAL FIELD CONDITIONS TO THE ARCHITECT PRIOR TO CONSTRUCTION. THIS INCLUDES, BUT IS NOT LIMITED TO,

4.SAFETY — IMPLEMENTING JOB SITE SAFETY CONSTRUCTION PROCEDURES AND COMPLIANCE WITH ALL (OSHA) RELATED SAFETY REGULATIONS ARE THE SOLE RESPONSIBILITY OF THE CONTRACTORS AND THEIR SUBCONTRACTORS.

THE FOLLOWING SHALL BE MAINTAINED AND/OR PROVIDED IN COMPLIANCE WITH CURRENT OSHA STANDARDS IN ADDITION TO ALL OTHER GOVERNING CODES AND ORDINANCES:

- ADEQUATE EXITS AND UNOBSTRUCTED ACCESS TO SUCH SHALL BE MAINTAINED VISIBLE EXIT SIGNAGE SHALL BE PROVIDED OR MAINTAINED FIRE PROTECTION PROGRAM AS WELL AS EQUIPMENT SHALL BE
- PROVIDED BY CONTRACTOR ACCESS TO A SUFFICIENT WATER SUPPLY SHALL BE AVAILABLE UPON ACCUMULATION OF COMBUSTIBLE MATERIAL

FIRE EXTINGUISHING DEVICES AND EQUIPMENT OF PROPER RATING,

STANDARD, AND LOCATION SERVICE OF FIRE RESPONSE SYSTEMS SHALL BE MAINTAINED AND CHECKED DAILY TO INSURE THAT PROTECTION IS IN SERVICE. INSIDES OF ALL ELECTRICAL AND TELEPHONE ROOMS.

5. MEANS AND METHODS — THE MEANS AND METHODS OF CONSTRUCTION ARE SOLELY THE RESPONSIBILITY OF THE CONTRACTORS AND THEIR SUBCONTRACTORS. ALL CONTRACTORS ARE RESPONSIBILE TO DETERMINE ALLOWABLE CONSTRUCTION LOADS AND TO PROVIDE PROPER DESIGN AND CONSTRUCTION OF FORMWORK, STAGING. BRACING, SHEETING AND SHORING, RESHORING, ETC.—THIS INCLUDES THAT REQUIRED FOR THE CONTRACTOR VEHICLES, FORKLIFTS, MOBILE CRANES, MATERIALS STORAGE,

6. COORDINATION — ALL CONTRACTORS AND THEIR SUBCONTRACTORS ARE RESPONSIBLE FOR THE THOROUGH COORDINATION OF THE WORK WITH EACH OTHER. OBTAIN ALL NECESSARY INFORMATION REQUIRED FOR A WELL-COORDINATED INSTALLATION OF THE WORK. NO CLAIMS FOR ADDITIONAL WORK WILL BE ACCEPTED FOR WORK RELATED TO SUCH COORDINATION.

7. JOB SITE — EACH CONTRACTOR SHALL KEEP THE JOB SITE FREE OF DEBRIS AND IS RESPONSIBLE FOR DAILY CLEAN UP. ROADWAYS AND SIDEWALKS SHALL BE KEPT FREE OF DEBRIS. TRASH CONTAINERS SHALL BE EMPTIED IN A TIMELY MANNER.

8. PROTECTION AND RESTORATION — ALL CONTRACTORS AND THEIR SUBCONTRACTORS SHALL PROTECT AND NOT DAMAGE EXISTING FINISHES, EQUIPMENT, PROPERTY, ETC. DURING THE WORK. ALL DAMAGED AREAS SHALL BE REPAIRED/RESTORED TO THEIR ORIGINAL CONDITIONS.

ALL CONTRACTORS SHALL RESTORE EXISTING WALL ASSEMBLIES TO MATCH EXISTING CONSTRUCTION AND FINISH AS REQUIRED AT ALL NEW PENETRATIONS AND OPENINGS. ALL ABANDONED OPENINGS AT WALLS, ROOF, OR FLOOR SHALL BE INFILLED WITH PERMANENT CONSTRUCTION.

WHERE REMOVAL OF EXISTING CONSTRUCTION RESULTS IN DEPRESSIONS AND/OR UNEVEN CONDITIONS. PATCH, LEVEL, AND FEATHER AREAS AS REQUIRED TO PROVIDE UNIFORMITY OF NEW CONSTRUCTION.

9. FACILITY OPERATIONS — CARE SHALL BE TAKEN TO AVOID DISTURBANCE OF ADJACENT FUNCTIONS/BUILDINGS. ALL WORK, DELIVERIES AND OTHER CONSTRUCTION RELATED ACTIVITIES SHALL ADHERE IN STRICT ACCORDANCE T LOCAL RESTRICTIONS AND CONDITIONS CONTRACTORS ARE TO HAVE A COPY OF SAID REQUIREMENTS AND CONDITIONS AVAILABLE AT THE JOB SITE AT ALL TIMES

11. QUALITY — ALL CONTRACTORS SHALL PROVIDE ALL MATERIALS INDICATED GRAPHICALLY OR AS NOTED. ALL MATERIALS USED IN CONSTRUCTION SHALL BE NEW AND FREE FROM DEFECTS. INSTALL ALL MATERIALS TO THE MANUFACTURERS'S RECOMMENDATIONS AND TO ACCEPTABLE PROFESSIONAL TRADE INDUSTRY STANDARDS FOR WORK OF SIMILAR SCOPE AND CHARACTER. WORK SHALL NOT VOID ANY WARRANTIES OR IMPEDE THE PERFORMANCE OF ANY

ALL WORK OF THE PROJECT SHALL BE PERFORMED CAREFULLY AND SKILLFULLY BY WORKERS ADEPT IN THEIR TRADES. SHOULD ANY MATERIAL OR WORKMANSHIP BE FOUND TO BE DEFECTIVE, IT SHALL BE REPLACED BY THE CONTRACTOR AT

12. DRAWINGS — DO NOT SCALE DRAWINGS, ALL WALL, PARTITION, AND STRUCTURAL DIMENSIONS ARE ACTUAL AND ARE DIMENSIONED TO THE FACE OF THE PARTITION, UNLESS INDICATED OTHERWISE. ALL DIMENSIONS, NOTES, AND DETAILS SHOWING A PORTION OF A DRAWING SHALL APPLY TYPICALLY TO ALL OPPOSITE HAND AND/OR SIMILAR CONDITIONS. CONTRACTORS SHALL VERIFY ALL DIMENSIONS IN THE FIELD AS REQUIRED FOR THE SCOPE OF WORK AND NOTIFY THE ARCHITECT OF ANY DISCREPANCIES

13. INCIDENTAL BLOCKING — PROVIDE ALL INCIDENTAL WOOD BLOCKING AS REQUIRED FOR ATTACHMENT OF FINISHES. AND ACCESSORIES. INCLUDING BUT NOT LIMITED TO MILLWORK, CASEWORK, AND COUNTERTOPS.

14. INSPECTIONS — CONTRACTORS SHALL BE RESPONSIBLE FOR MAKING ARRANGEMENTS FOR ALL REQUIRED INSPECTIONS.

15. OWNER-PROVIDED EQUIPMENT — ALL CONTRACTORS SHALL OBTAIN ALL REQUIREMENTS FOR INSTALLATION OF OWNER PROVIDED EQUIPMENT FROM OWNER PRIOR TO INSTALLATION.

16. HAZARDOUS MATERIALS — TESTING WAS PERFORMED PRIOR TO THE PROJECT TO IDENTIFY HAZARDOUS MATERIALS THAT MAY BE DISTURBED BY THE PLANNED


REFER TO THE SURVEY REPORT BY REQUEST TO THE OWNER FOR A LIST OF BUILDING COMPONENTS ASSOCIATED WITH THE PROPOSED RENOVATIONS IDENTIFIED TO BE ASBESTOS OR LEAD-CONTAINING, IF ANY.

FURNISHING OF THIS INFORMATION IS NOT INTENDED TO RELIEVE THE CONTRACTOR OF ITS RESPONSIBILITIES UNDER OSHA TO DETERMINE THE PRESENCE, LOCATION, AND QUANTITY OF EXISTING LEAD-CONTAINING MATERIALS THAT THEIR EMPLOYEES MAY BE EXPOSED TO. AND TO WARN THEIR EMPLOYEES OF THE POTENTIAL DANGERS OF THE DISTURBANCE OF ASBESTOS OR LEAD-

ALL CONTRACTORS ARE RESPONSIBLE FOR MAKING THEMSELVES AND THEIR EMPLOYEES AWARE OF THE PRESENCE, LOCATION, AND QUANTITY OF EXISTING ASBESTOS CONTAINING BUILDING MATERIALS, AND TO WARN THEIR EMPLOYEES OF THE POTENTIAL DANGERS OF EXPOSURE TO ASBESTOS. ANY DISTURBANCE OF ASBESTOS CONTAINING MATERIALS SHALL BE PERFORMED BY A LICENSED ASBESTOS ABATEMENT CONTRACTOR, EMPLOYING CERTIFIED WORKERS.

CONTRACTOR SHALL BE RESPONSIBLE FOR COMPLYING WITH OSHA 29 CFR 1926.62: LEAD EXPOSURE IN CONSTRUCTION; INTERIM FINAL RULE FOR ALL ACTIVITIES DURING WHICH AN EMPLOYEE MAY BE OCCUPATIONALLY EXPOSED TO LEAD.


ANY QUESTIONABLE MATERIAL OR MATERIAL SUSPECTED TO CONTAIN ASBESTOS SHALL NOT BE DISTURBED AND SHALL BE BROUGHT TO THE ATTENTION OF THE OWNER OR THE OWNER'S REPRESENTATIVE FOR AN ACCURATE INTERPRETATION AND/OR SAMPLING AND ANALYSIS. ASBESTOS TESTING REPORTS ARE AVAILABLE BY REQUEST TO THE OWNER.

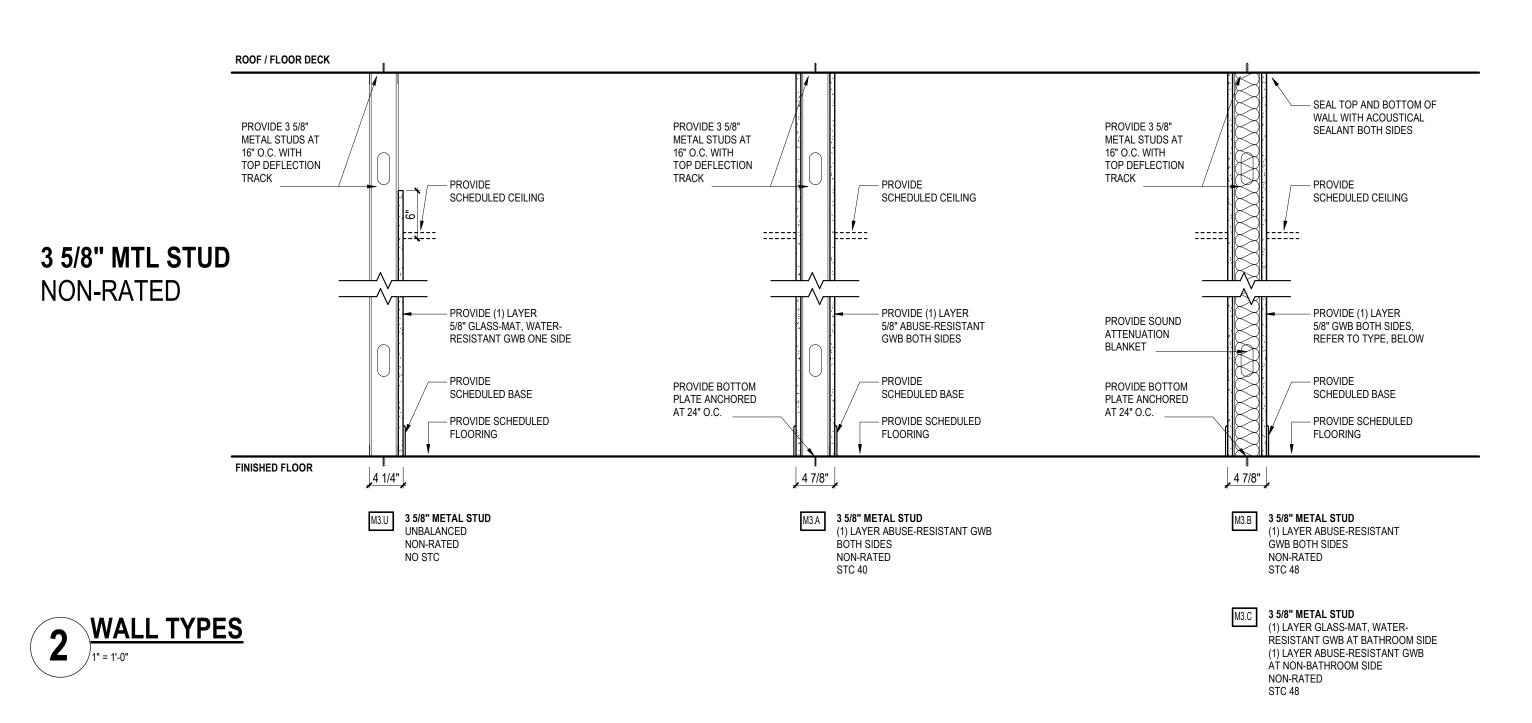

PHASE 1

(CEILING ONLY)

PHASE 4

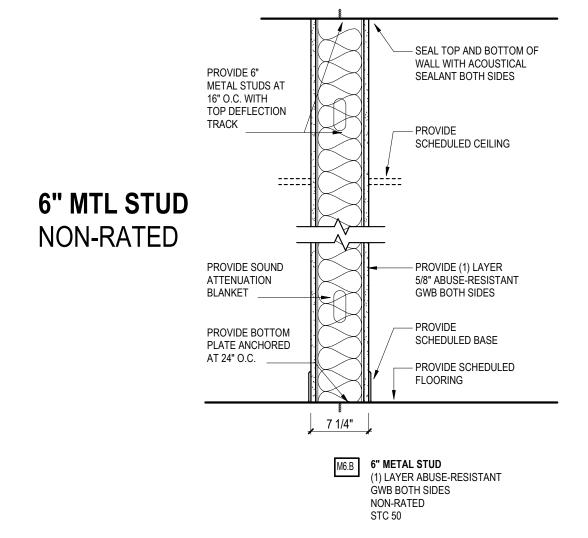

WALL TYPE NOTES

- 1. DIMENSIONS ARE FROM WALL SURFACE TO WALL SURFACE UNLESS NOTED OTHERWISE.
- 2. ALL WALL TYPES TO BE CONTINUOUS FROM FINISHED FLOOR
- TO UNDERSIDE OF DECK UNLESS NOTED OTHERWISE. 3. REFER TO FLOOR PLANS FOR WALL TYPE LOCATIONS.
- 4. REFER TO FINISH SCHEDULES. PLANS, INTERIOR ELEVATIONS
- AND REFLECTED CEILING PLANS FOR FINISH INFORMATION.
- 5. PROVIDE METAL STUD GAUGE PER SCHEDULE UNLESS NOTED
- 6. PROVIDE WATER-RESISTANT, GLASS-MAT GWB AT WET LOCATIONS.

7. PROVIDE ABUSE RESISTANT GWB THROUGHOUT.

WALL TAGS

HOW TO READ THE WALL TAGS

C = CONCRETE MASONRY UNIT

S = SPECIALIZED CONSTRUCTION F = FIRE-RATED

WALL CORE PRIMARY TYPE

SCHEDULE

WORK TO BE COMPLETED ACCORDING TO THE FOLLOWING TIMETABLE.

DURATION START DATE COMPLETION DATE

10 WEEKS 06/22/2026 - 08/28/2026

12 WEEKS 03/30/2026 - 06/19/2026

NOTE: ALLOW 1 WEEK AT END OF PHASE FOR OWNER TO RELOCATE/INSTALL FF+E

NOTE: ALLOW 2 WEEKS AT END OF PHASE FOR OWNER TO RELOCATE/INSTALL FF+E

NOTE: ALLOW 2 WEEKS AT END OF PHASE FOR OWNER TO RELOCATE/INSTALL FF+E

6 WEEKS 02/16/2026 - 03/27/2026

6 WEEKS 12/29/2025 - 02/13/2026

M = METAL STUD

METAL STUD SCHEDU	<u>JLE</u>
WALL HEIGHT	GA
UP TO 10'	22
101 TO 151	10

15' TO 20'

OTHER INFO

NOMINAL SIZE OF WALL CORE

D = DOUBLE WALL

LETTER = VARIANT

NUMBER = FIRE RATING

16

SCHEDULES

Consultants:

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Client: LACTALIS AMERICAN GROUP

Project:

RENOVATIONS AT 2376 SOUTH PARK **AVENUE**

Project Address:

2376 SOUTH PARK AVENUE BUFFALO, NY 14220

Date Description

Project Number: 25042

Date: 11/6/25

Sheet Title: PARTITON TYPES & **PHASING**

THE FOLLOWING PHASING SEQUENCE RELATES TO THE ENTIRE SET OF DRAWINGS. THIS SHEET IS FOR DIAGRAMMATIC PURPOSES. ACTUAL DETAILED DESCRIPTION OF THE WORK TO BE PERFORMED MUST BE TAKEN FROM THE ENTIRE SET OF CONSTRUCTION DOCUMENTS.

EGRESS MUST BE MAINTAINED AT ALL TIMES. CONTRACTORS SHALL MAKE EVERY EFFORT TO MINIMIZE DISRUPTION AND ENSURE THAT ELECTRICAL WORK DOES NOT IMPACT AREAS OUTSIDE OF THE WORK PHASE CONTRACTORS ARE RESPONSIBLE FOR COORDINATING WITH THE OWNER ANY UNAVOIDABLE SHUT DOWNS THAT IMPACT AREAS OUTSIDE OF THE WORK PHASE AREA WITH MIN. 24 HOURS ADVANCE NOTICE. THE OWNER WILL PROVIDE ACCESS TO THE BUILDING DURING OFF-HOURS AT THE CONTRACTORS REQUEST. ALL SECURITY REQUIREMENTS MUST BE MAINTAINED AND REVIEWED WITH THE OWNER. ANY REQUIRED ACCESS

ELECTRICAL E2.1. ELECTRICAL WORK SHALL NOT IMPACT AREAS OUTSIDE OF THE WORK PHASE.

A3.1. EXIT #1 MAY BE CLOSED DURING PHASE 3 CONSTRUCTION. EXIT #2 AND ALL OTHER EXIT PATHS MUST REMAIN OPEN AND ACCESSIBLE DURING BUSINESS HOURS.

E3.1. ELECTRICAL WORK SHALL NOT IMPACT AREAS OUTSIDE OF THE WORK PHASE.

PATHS BETWEEN MUST REMAIN OPEN AND ACCESSIBLE DURING BUSINESS HOURS. A4.2. PROVIDE DUST-PROOF TEMPORARY PARTITION(S) TO CORDON OFF AREAS OF WORK DURING PHASE 4 CONSTRUCTION.

M4.1. COORDINATE WITH OWNER TO TURN RTU OFF AND ON AS NECESSARY DURING CONSTRUCTION.

ELECTRICAL

THE BUILDING WILL BE OCCUPIED THROUGHOUT ALL PHASES OF CONSTRUCTION. REQUIRED EMERGENCY

ARCHITECTURAL A1.1. MAINTAIN ALL EXISTING CIRCULATION AND EXITS DURING PHASE 1 CONSTRUCTION.
A1.2. EXISTING OFFICE FURNITURE AND FURNITURE WALL SYSTEMS TO REMAIN IN PLACE; PROTECT

MECHANICAL M1.1. COORDINATE WITH OWNER TO TURN RTU OFF AND ON AS NECESSARY DURING

ARCHITECTURAL A2.1. MAINTAIN ALL EXISTING CIRCULATION AND EXITS DURING PHASE 2 CONSTRUCTION. A2.2. PROVIDE DUST-PROOF TEMPORARY PARTITION AROUND PHASE 2 WORK AREA.

A3.2. PROVIDE DUST-PROOF TEMPORARY PARTITION(S) TO CORDON OFF AREAS OF WORK

PHASING

OPENINGS MUST BE REVIEWED WITH THE OWNER. PROTECT ALL EXISTING BUILDING ELEMENTS TO REMAIN.

AS REQUIRED DURING CONSTRUCTION.

CONSTRUCTION.

E1.1. ELECTRICAL WORK SHALL NOT IMPACT AREAS OUTSIDE OF THE WORK PHASE.

M2.1. COORDINATE WITH OWNER TO TURN RTU OFF AND ON AS NECESSARY DURING CONSTRUCTION.

MECHANICAL M3.1. COORDINATE WITH OWNER TO TURN RTU OFF AND ON AS NECESSARY DURING

ARCHITECTURAL A4.1. EXIT #6 MAY BE CLOSED DURING PHASE 4 CONSTRUCTION. EXIT #1, EXIT #5 AND ALL EXIT

E4.1. ELECTRICAL WORK SHALL NOT IMPACT AREAS OUTSIDE OF THE WORK PHASE.


PHASE 2


PHASE 3


EXIT

#2

#3

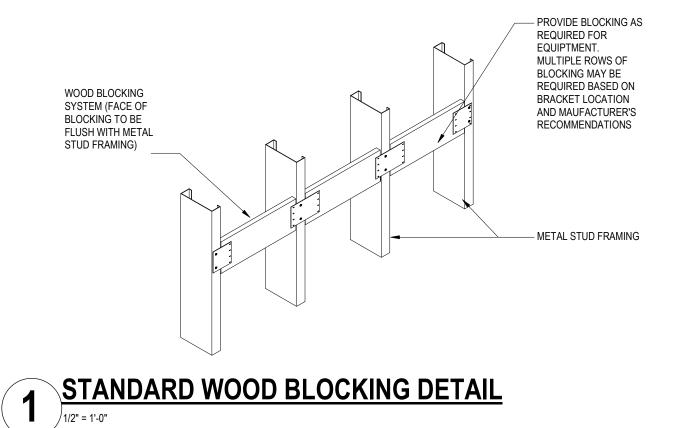

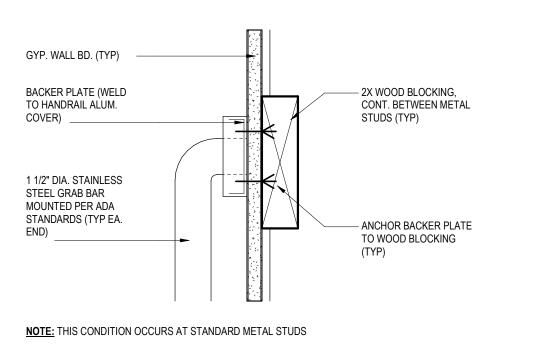

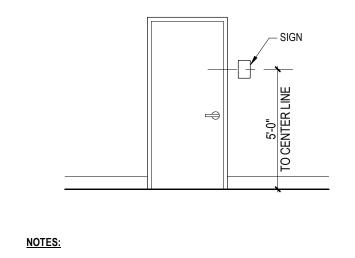

SIGNAGE SHALL BE MOUNTED ON THE LATCH SIDE OF THE DOOR.
MOUNT SIGN PANELS W/ SCREW EXPANSION SLEEVES AS REQUIRED.

TYPICAL H/C SIGN LOCATION

1/4" = 1'-0"

- WALL CONST. - COORDINATE WITH PARTITION TYPES

WALL FINISH - REFER TO

SEMI-RECESSED FIRE EXTINGUISHER CABINET


BASE - REFER TO ROOM FINISH SCHEDULE


TO ROOM FINISH

SCHEDULE

FINISH FLOOR - REFER


ROOM FINISH SCHEDULE

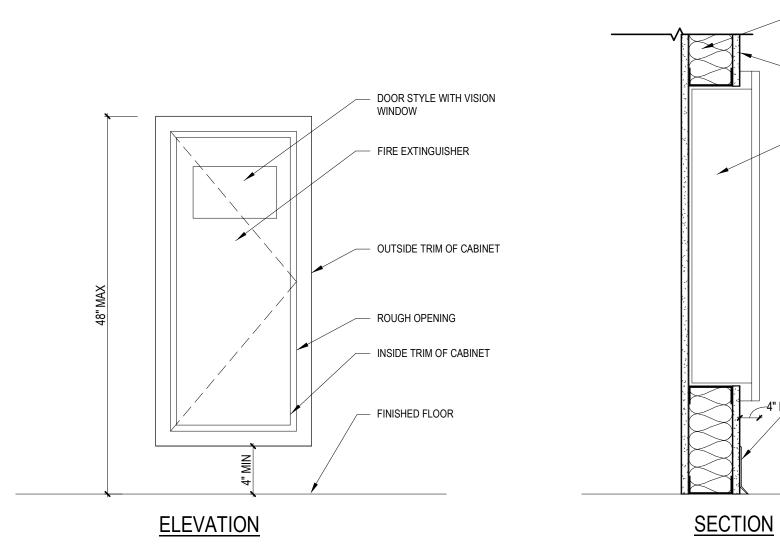

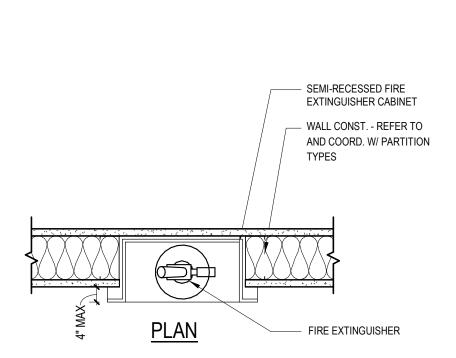


TYPICAL FIRE EXTINGUISHER DETAILS

1 1/2" = 1'-0"

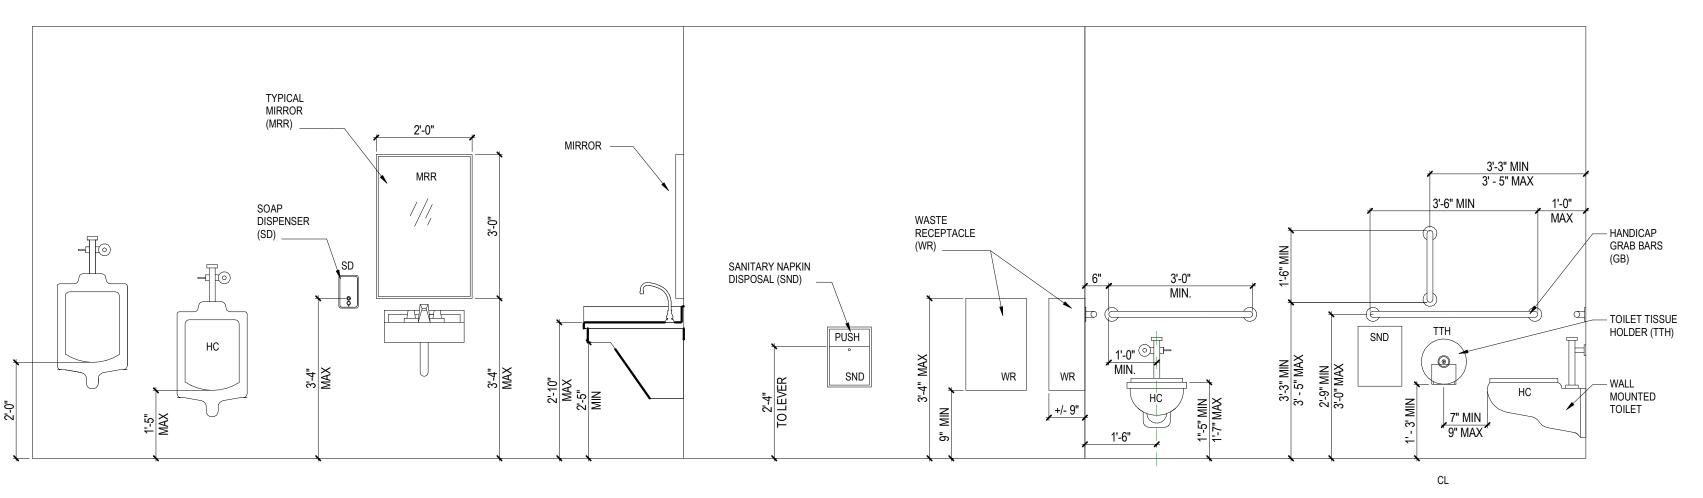

TOILET ACCESSORIES NOTES: PROVIDE SOLID WOOD BLOCKING FOR ALL TOILET ACCESSORIES MOUNTED IN GWB PARTITIONS. GROUT CMU CORES AT AREAS TO RECEIVE TOILET ACCESSORIES.

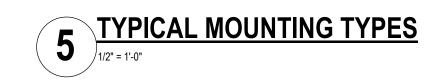



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Project: **RENOVATIONS AT** 2376 SOUTH PARK **AVENUE**

2376 SOUTH PARK AVENUE BUFFALO, NY 14220 Project Address:


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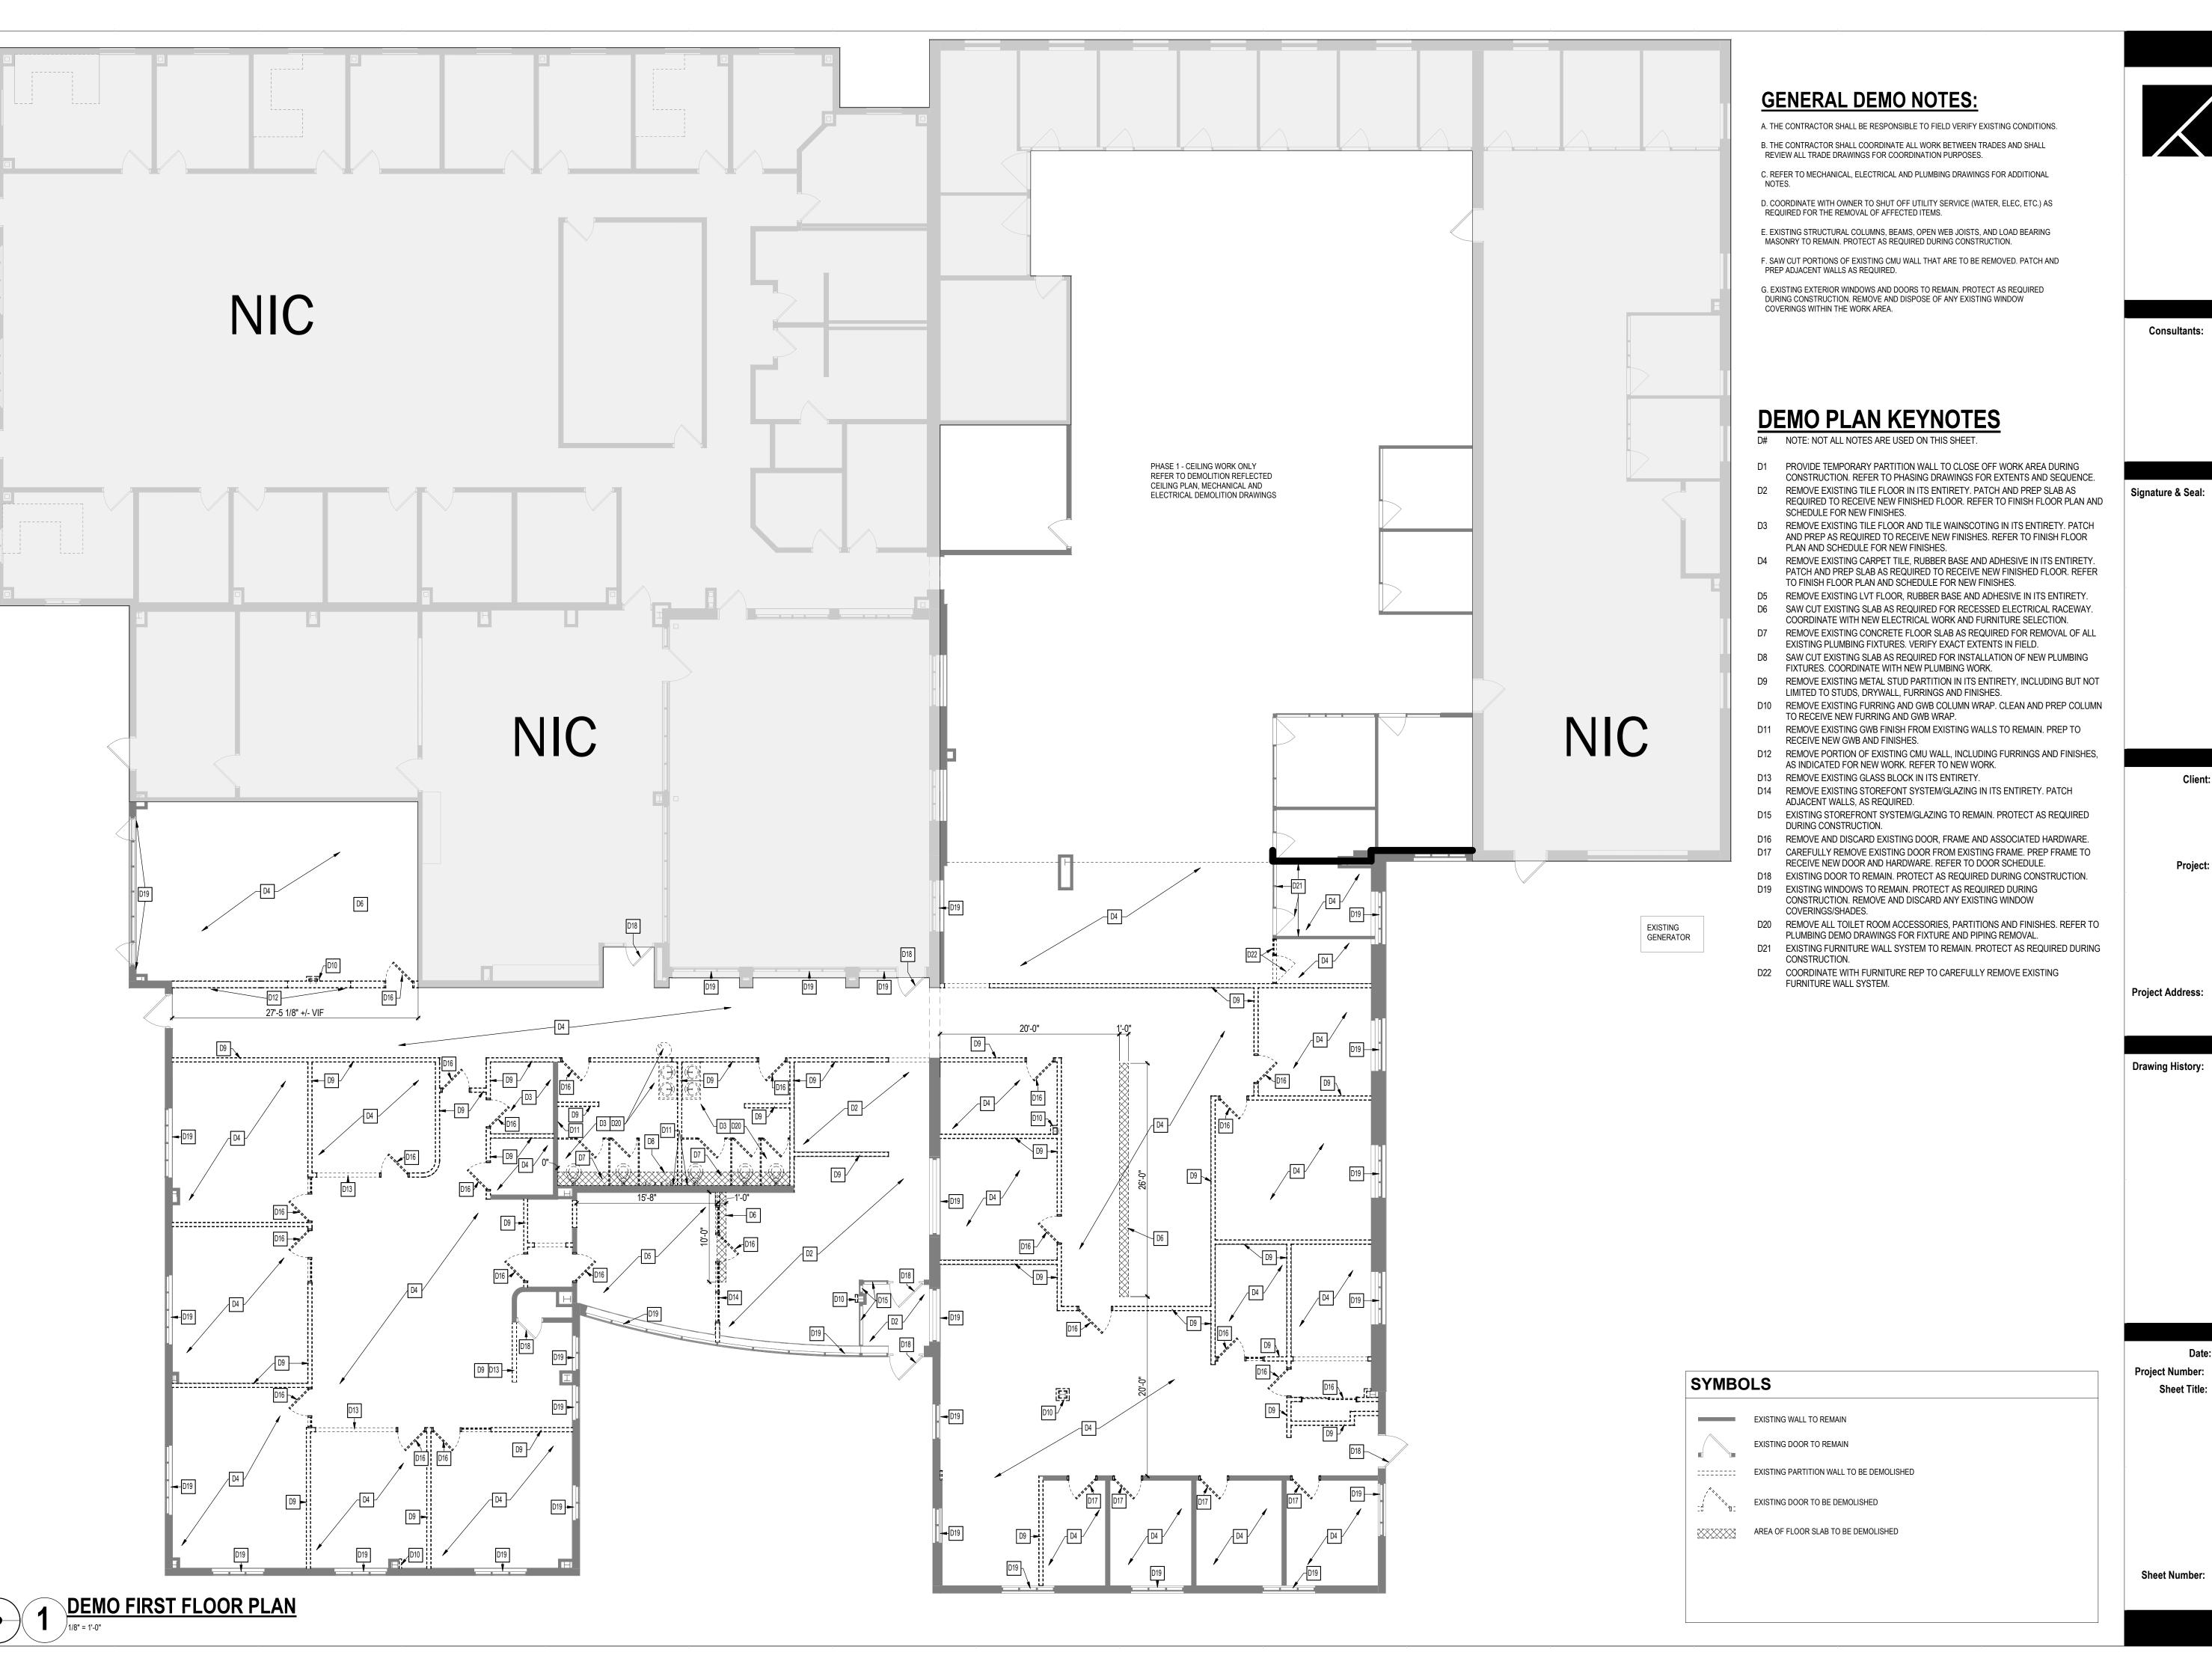
Date: 11/6/25

Project Number: 25042

Sheet Title: TYPICAL DETAILS

G003



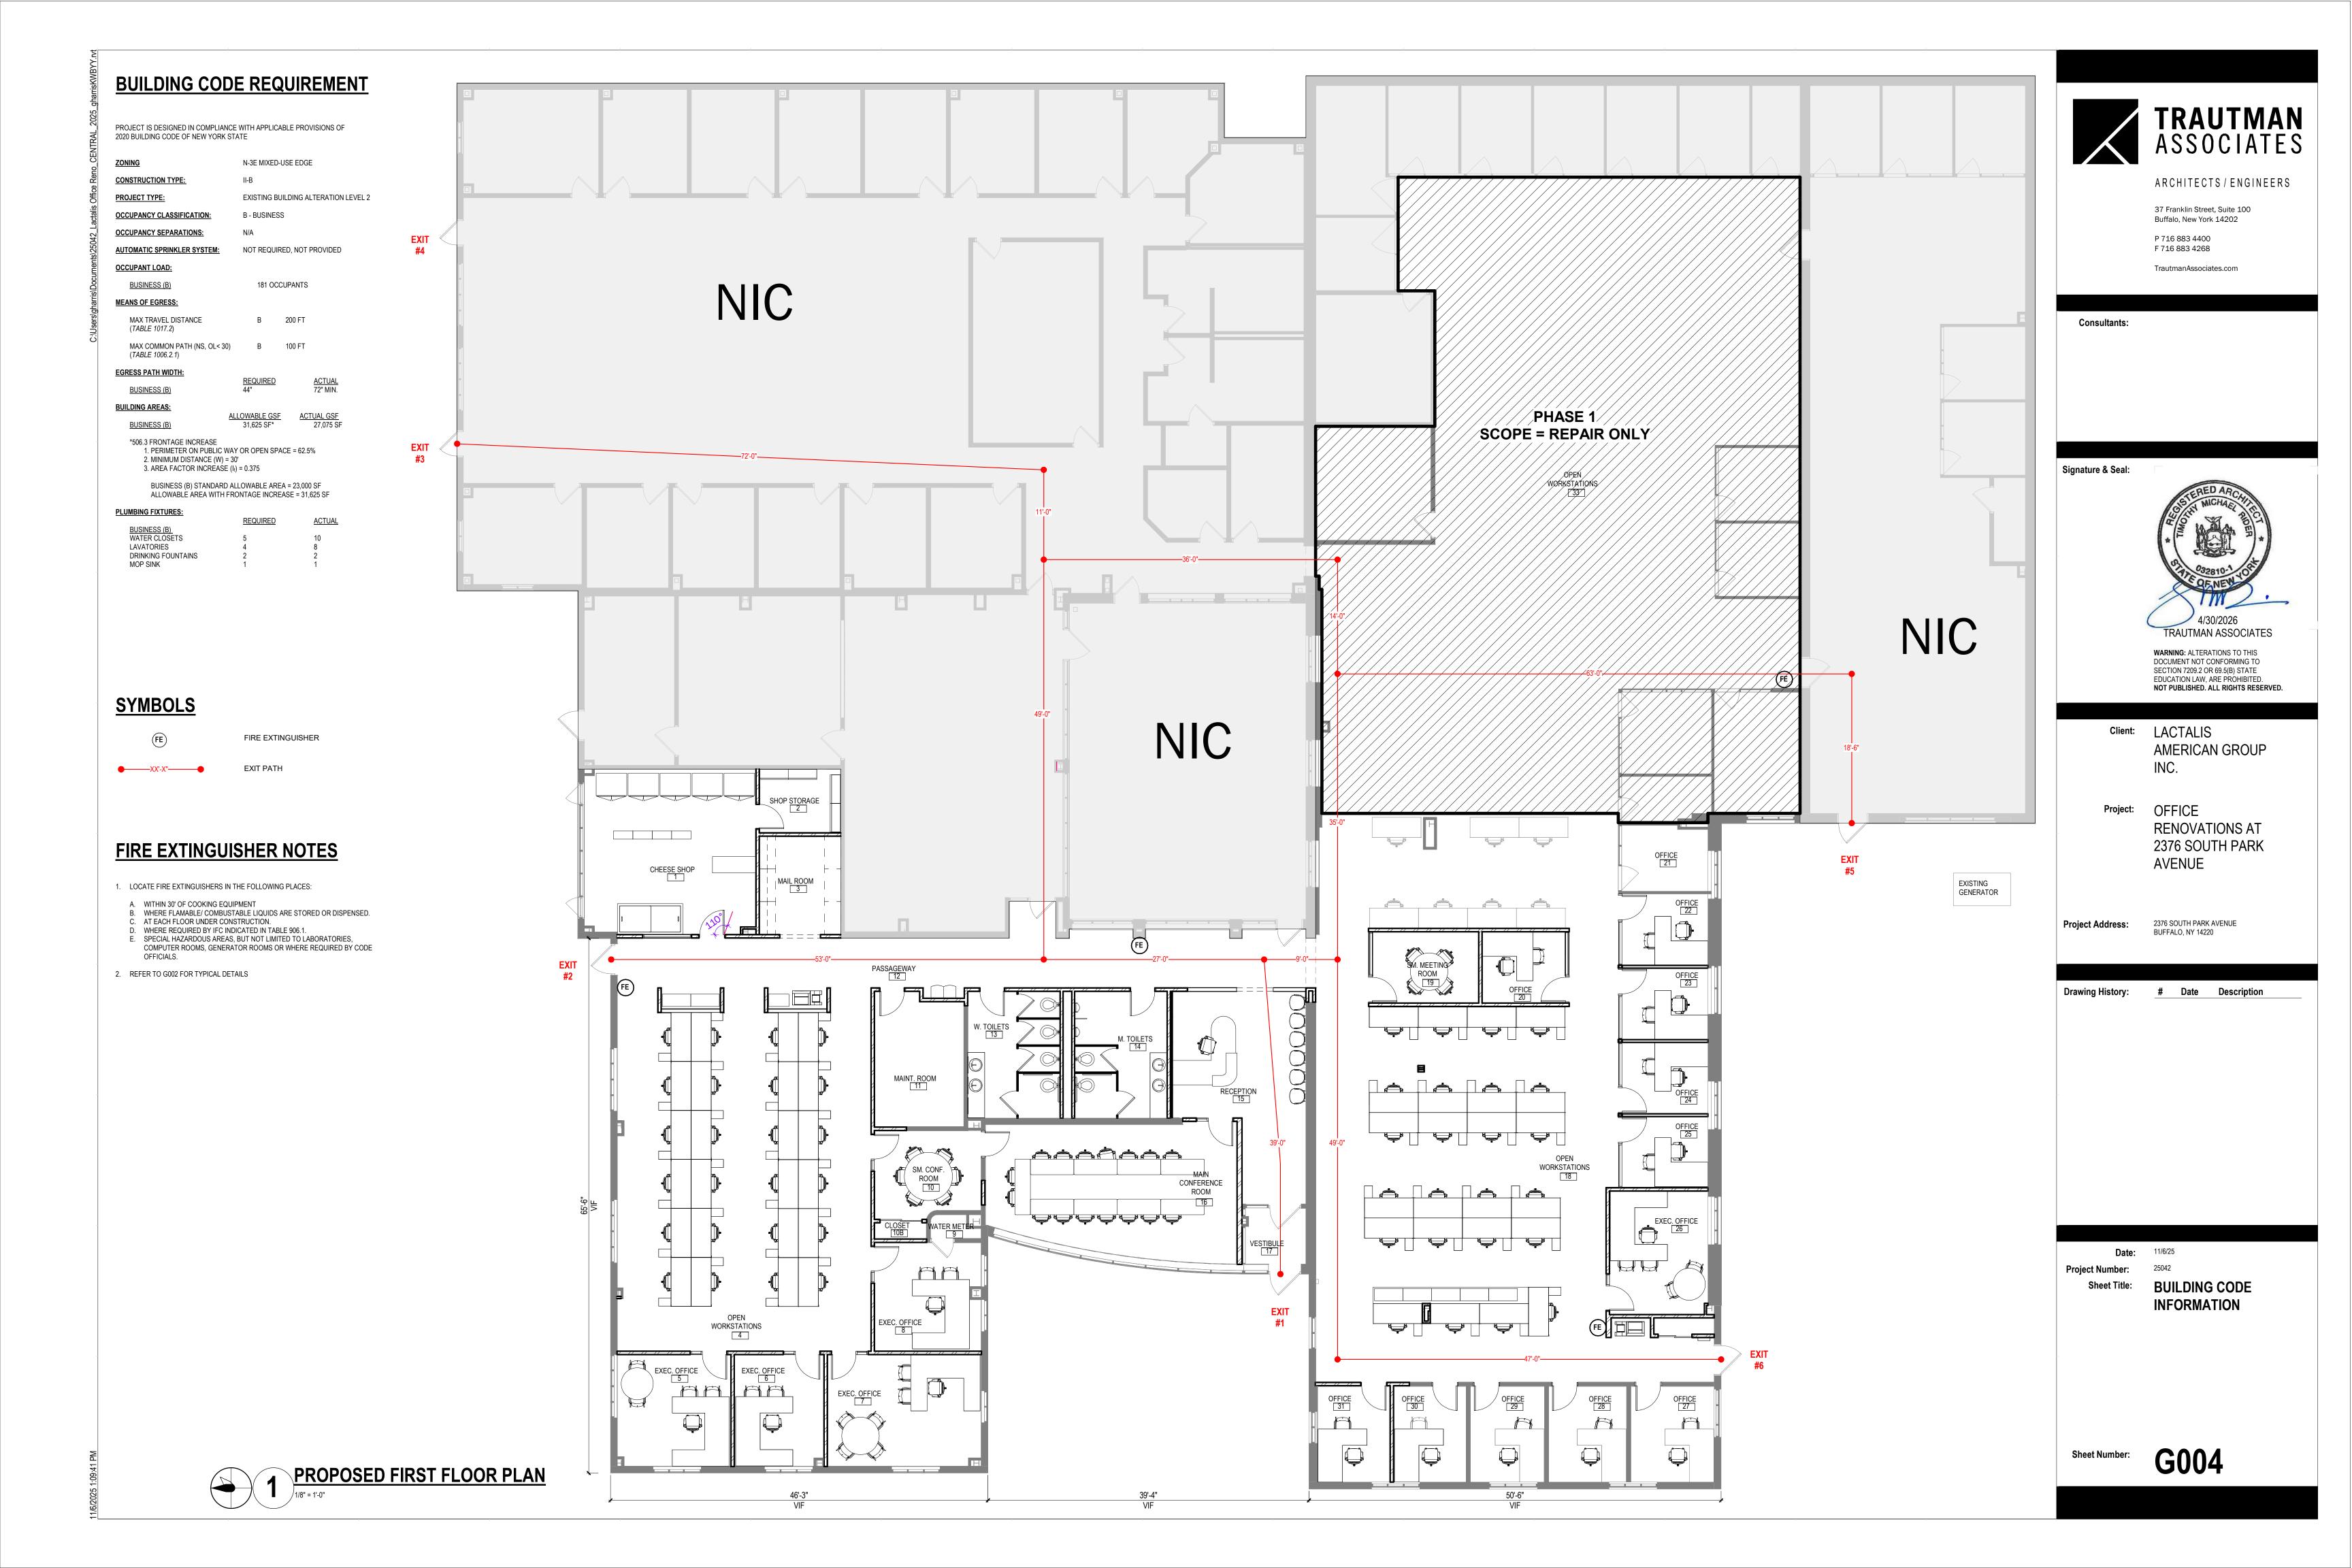

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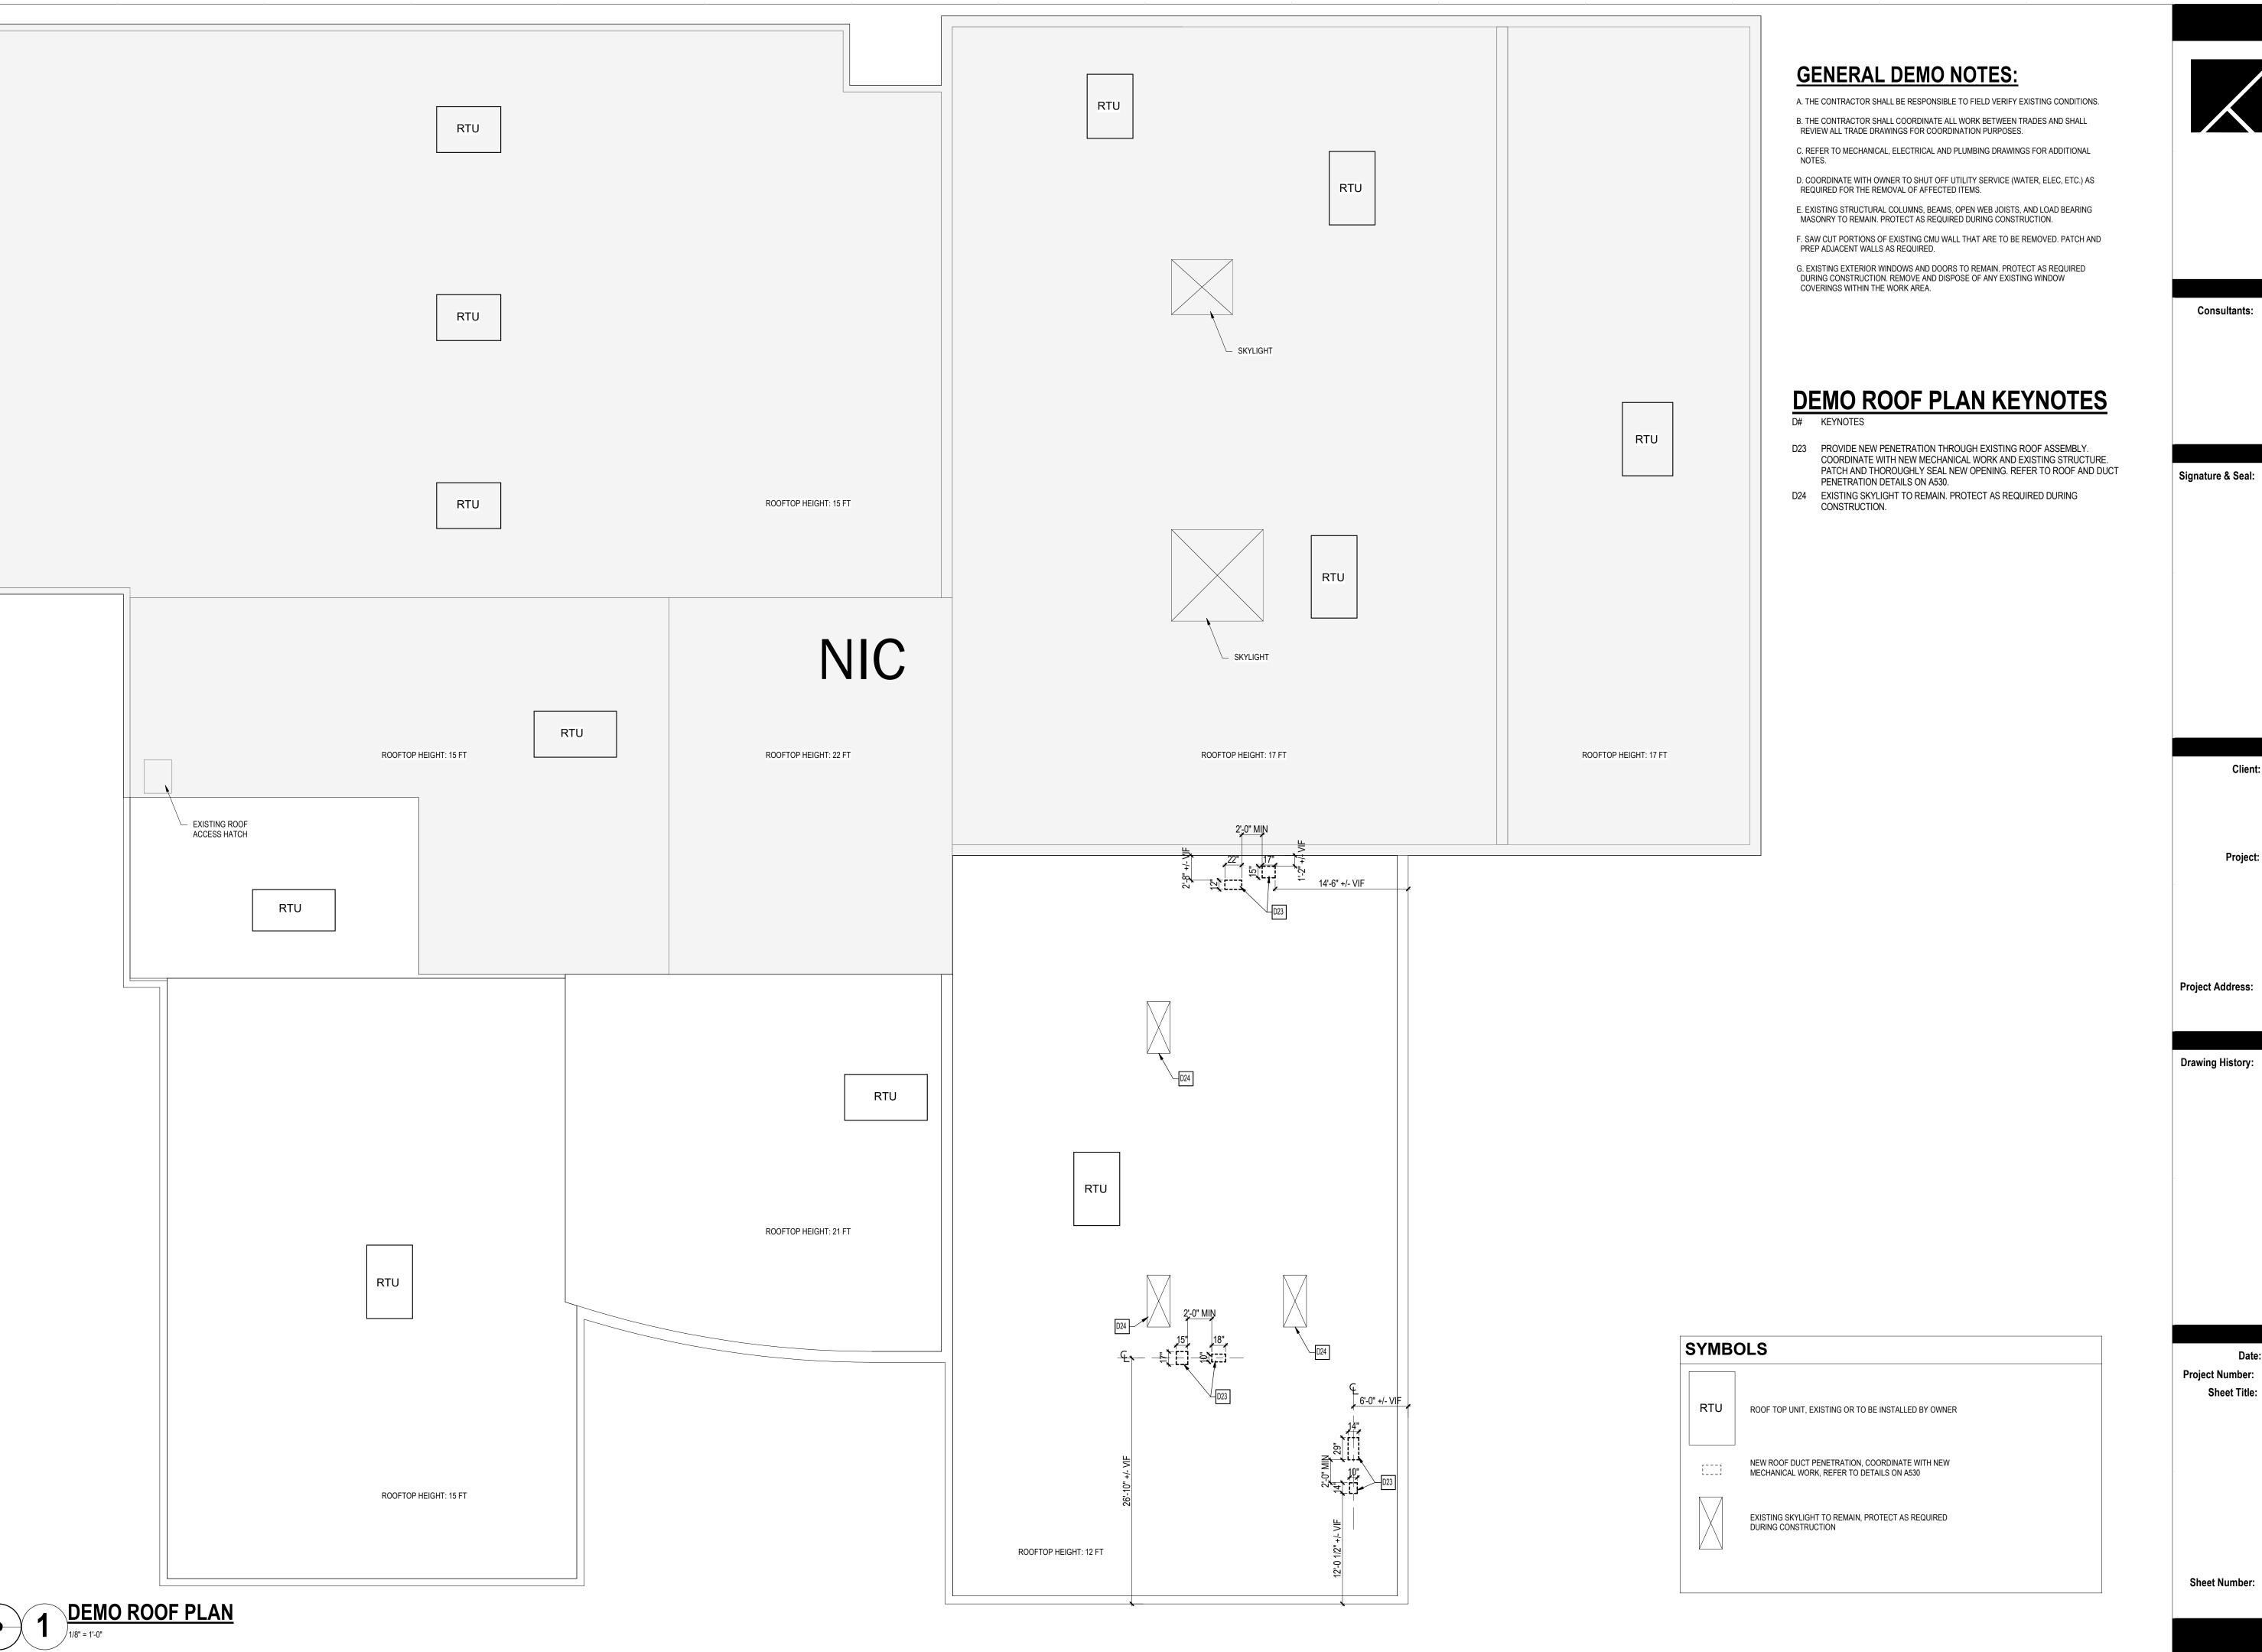
RENOVATIONS AT 2376 SOUTH PARK **AVENUE**

2376 SOUTH PARK AVENUE BUFFALO, NY 14220

Date Description

DEMO FIRST FLOOR PLAN

AD101





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AMERICAN GROUP

Project: OFFICE

RENOVATIONS AT 2376 SOUTH PARK

AVENUE


2376 SOUTH PARK AVENUE BUFFALO, NY 14220


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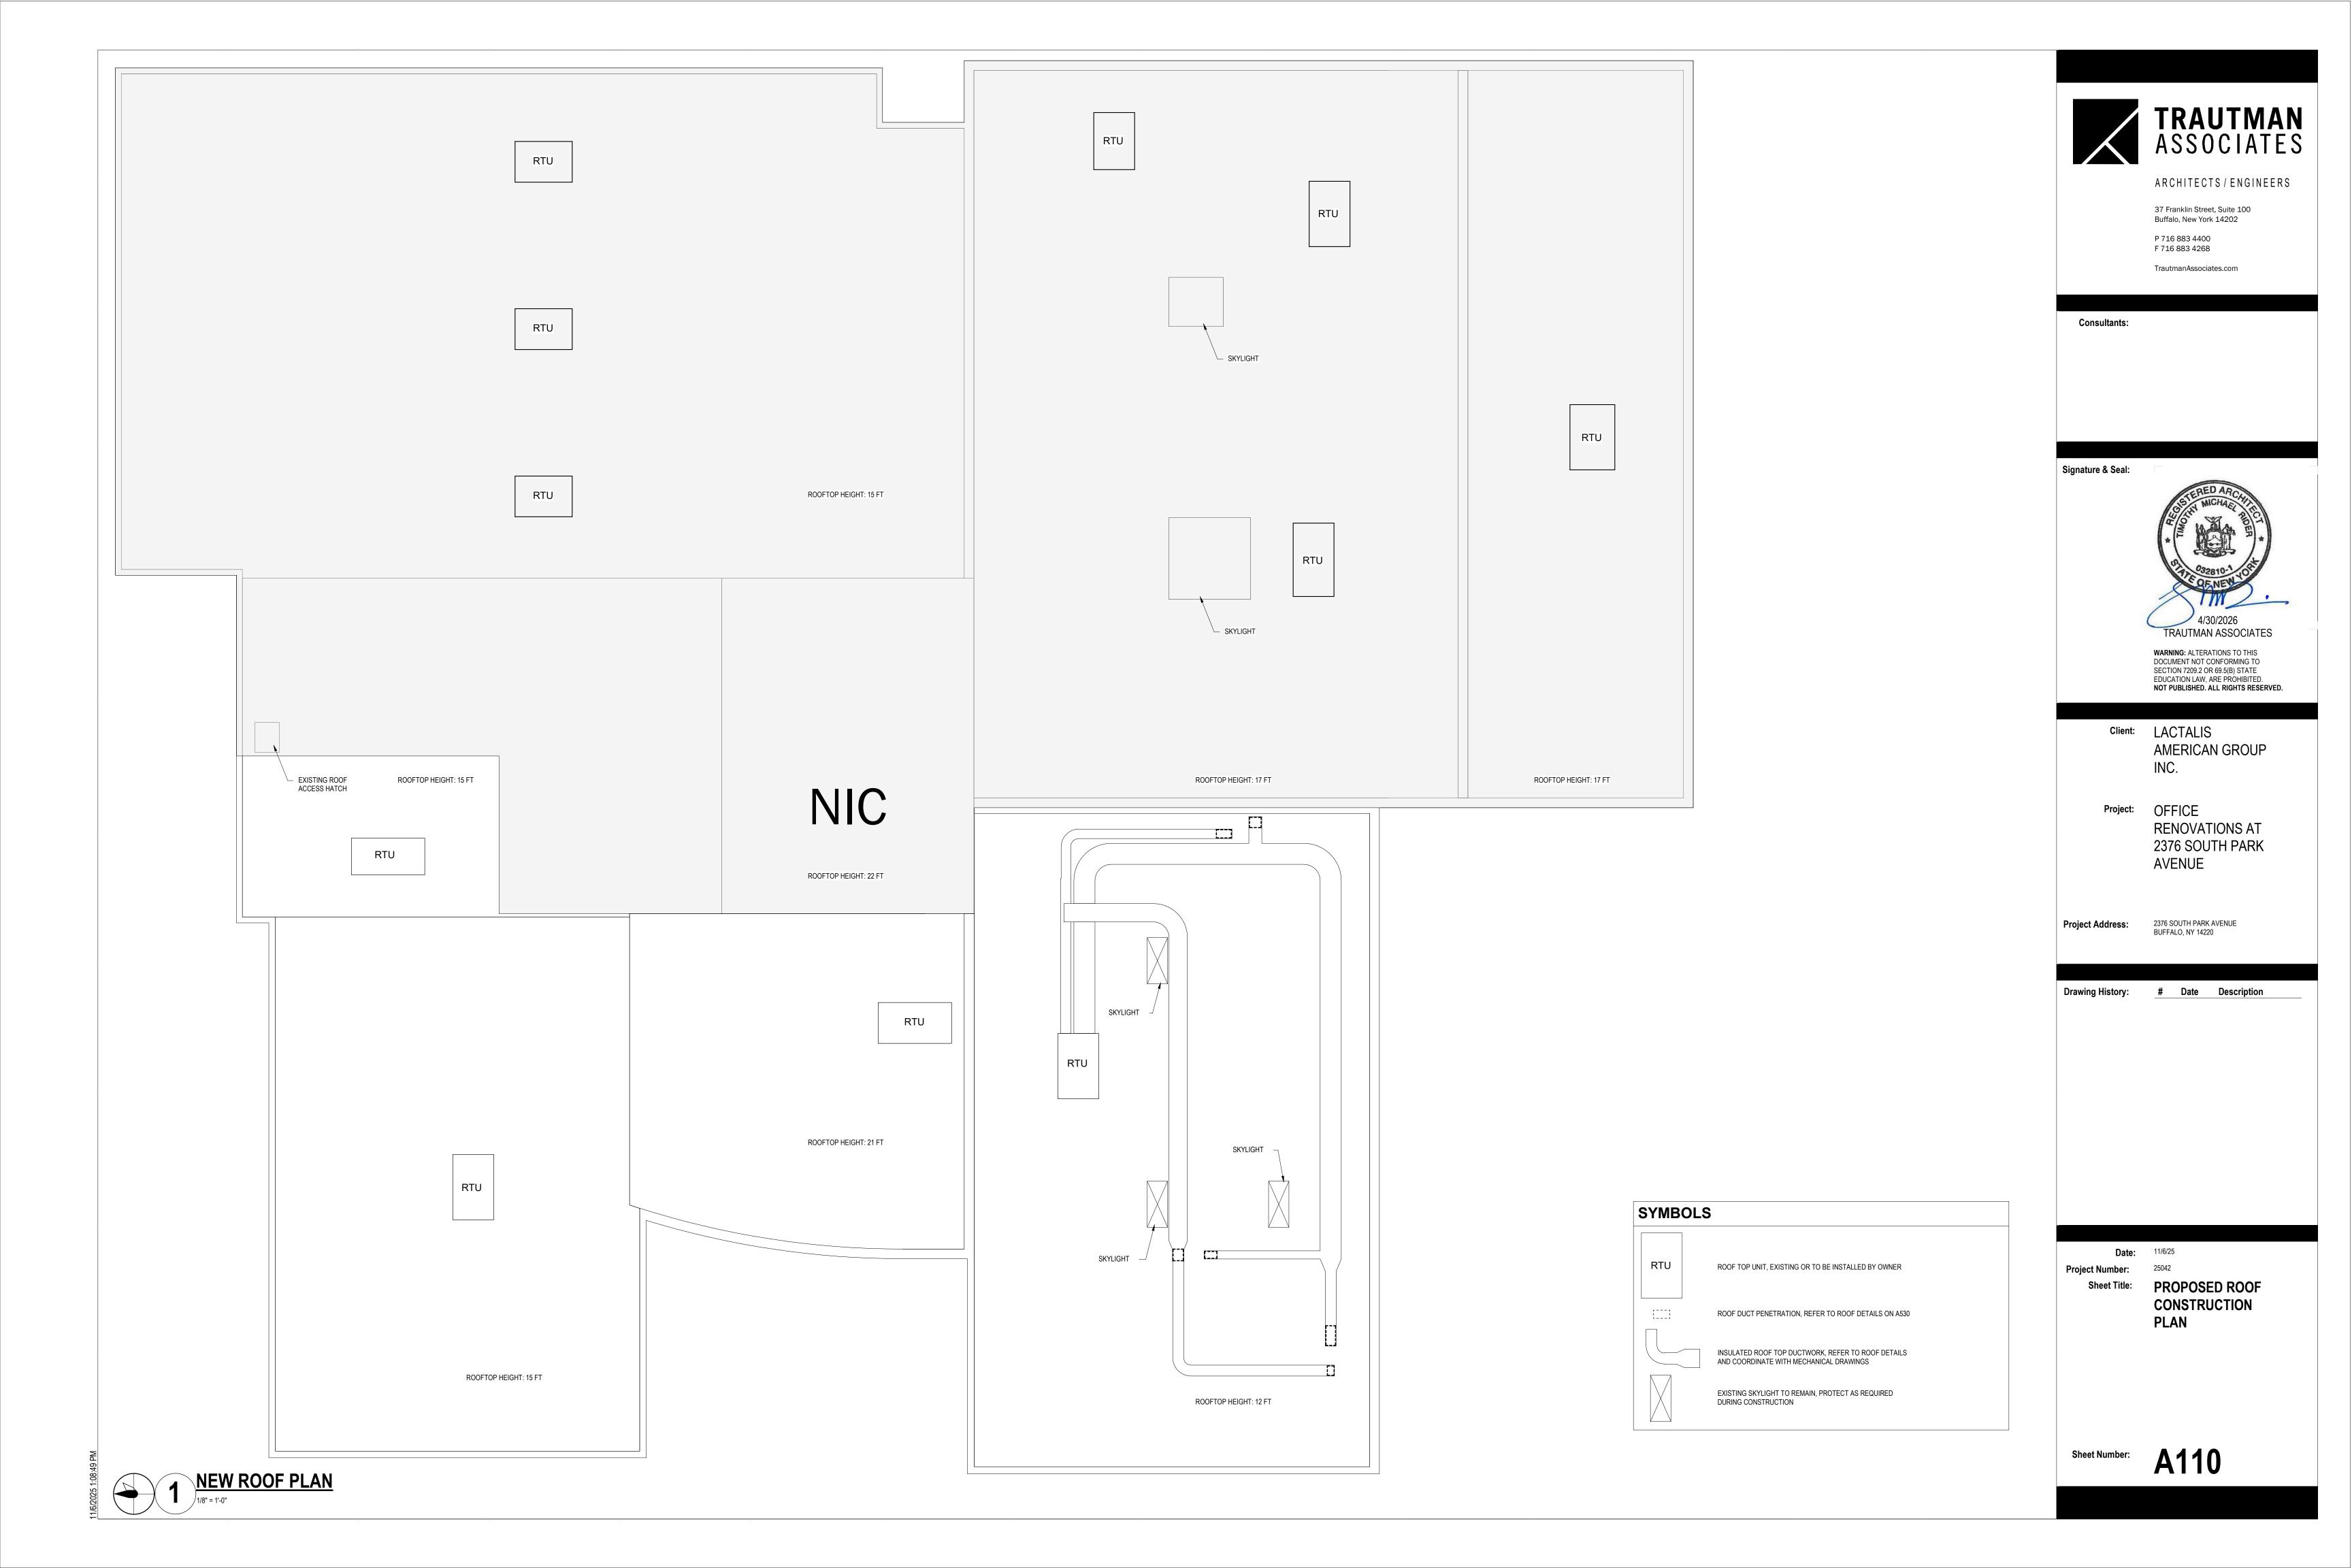
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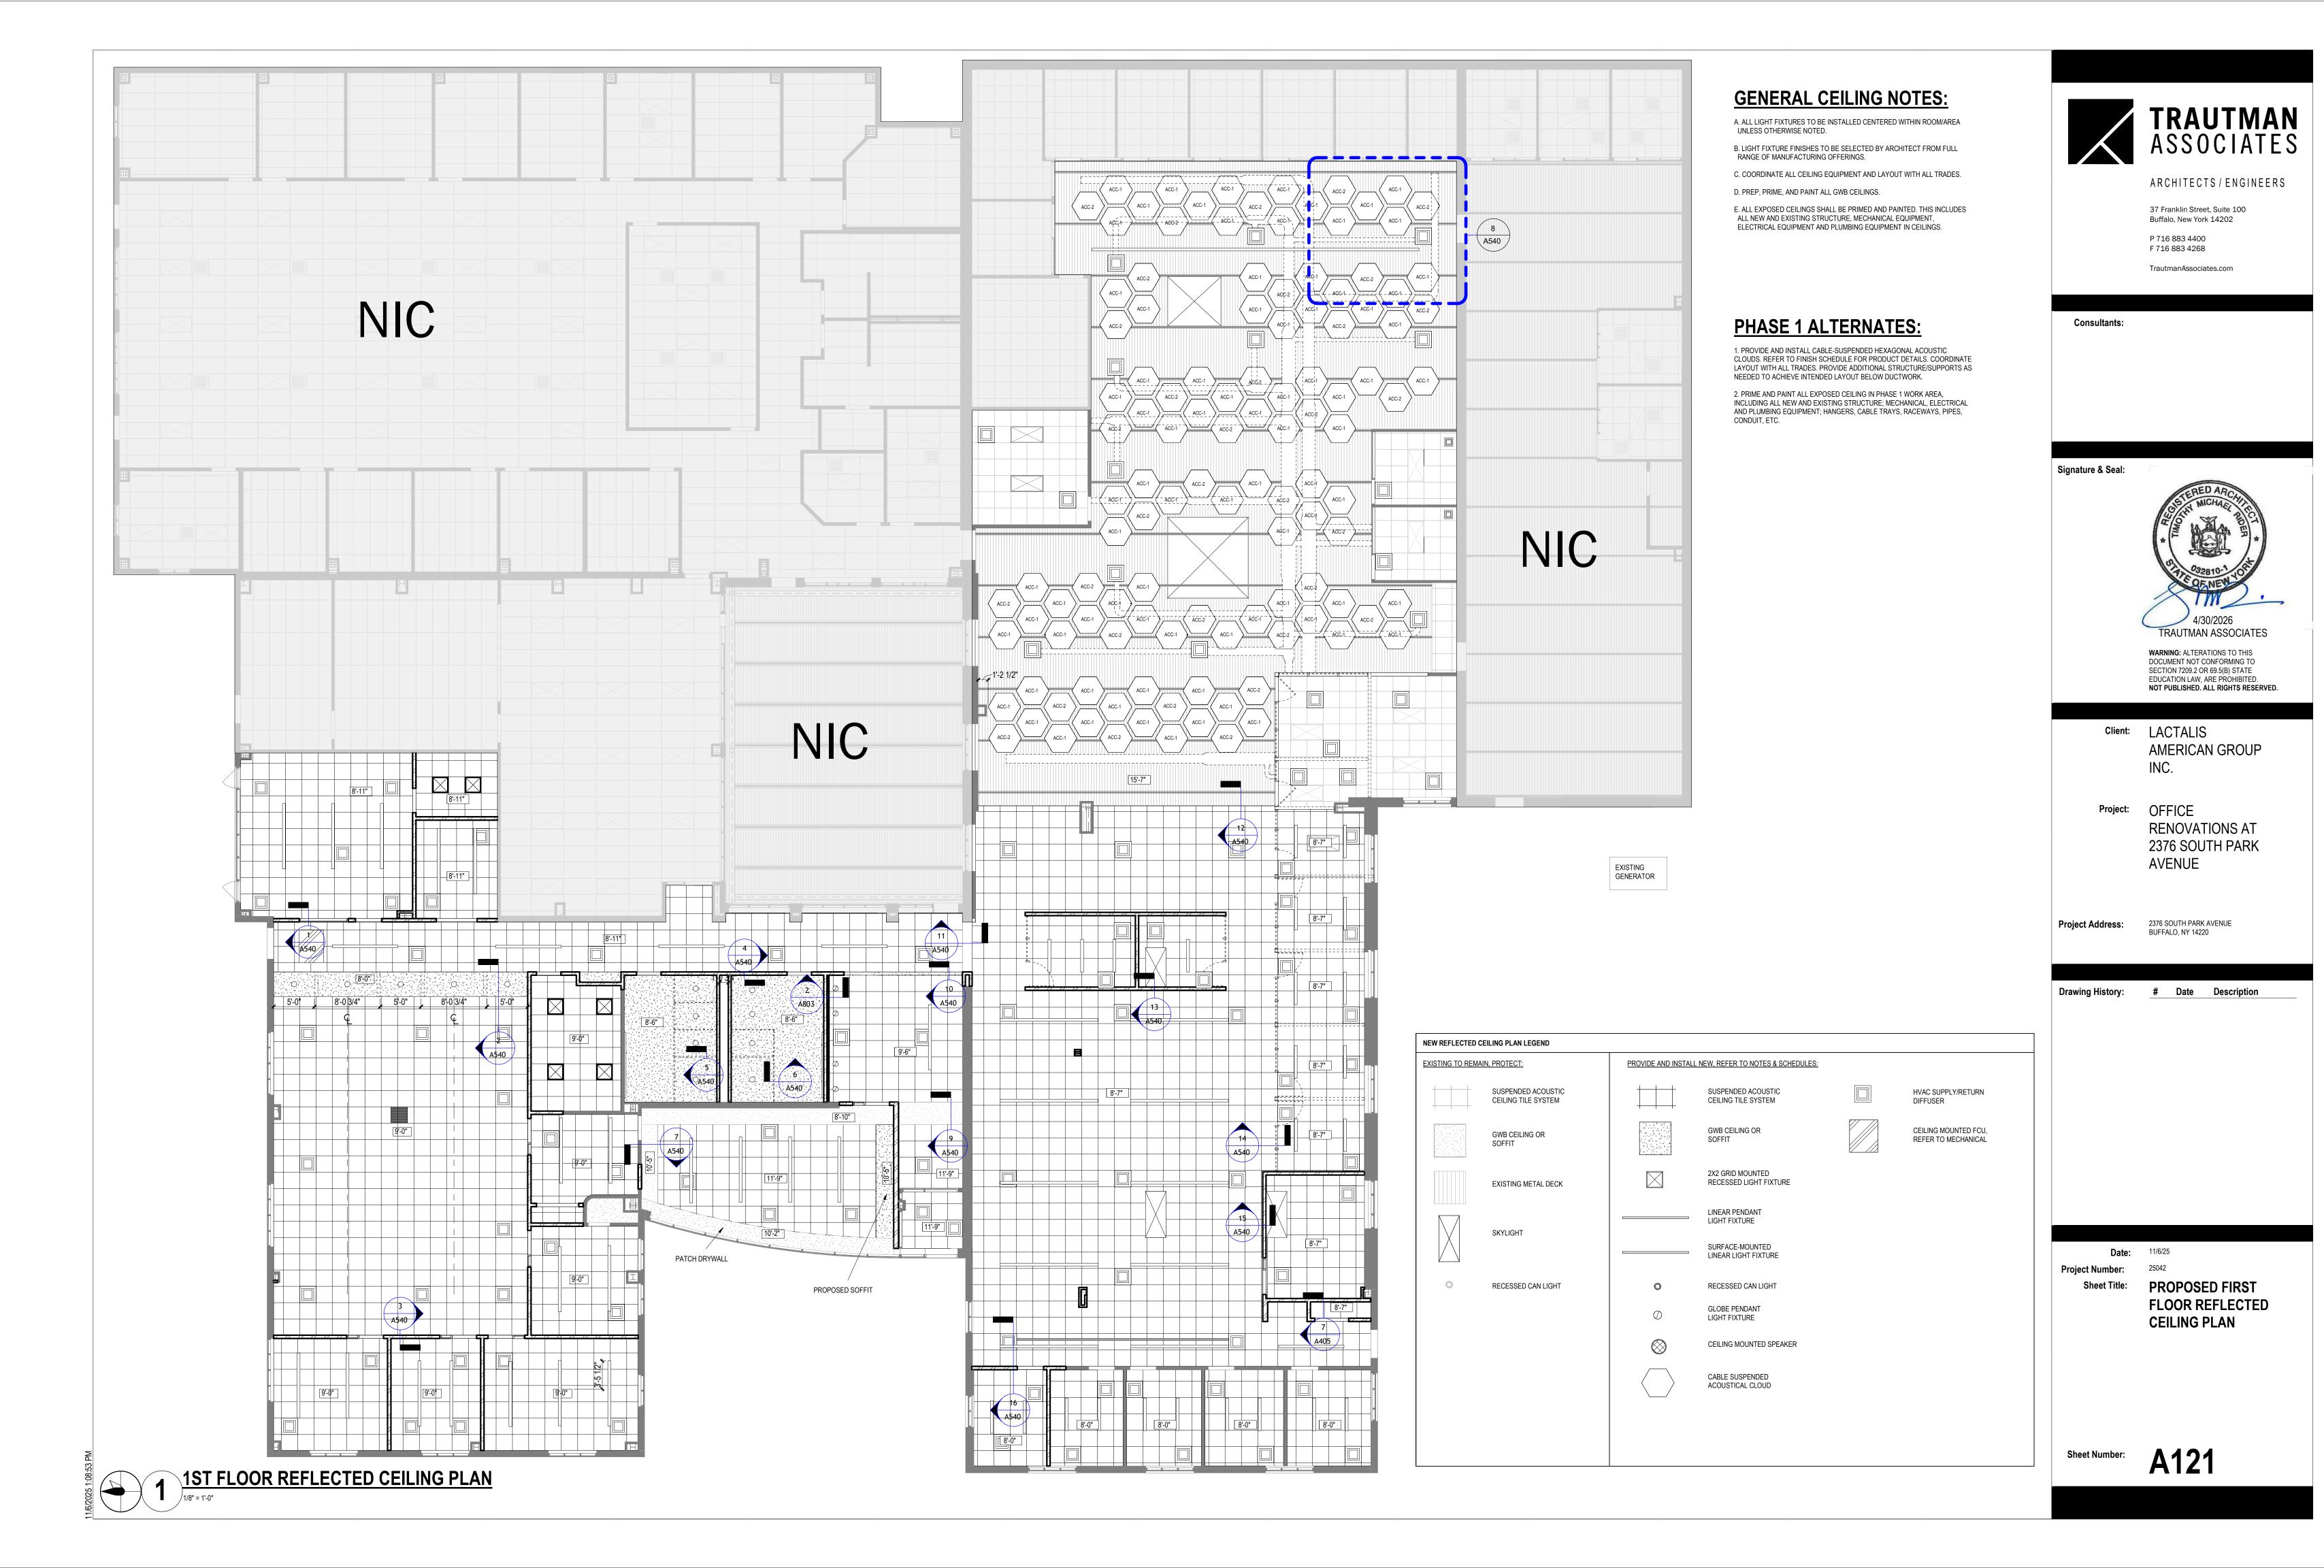
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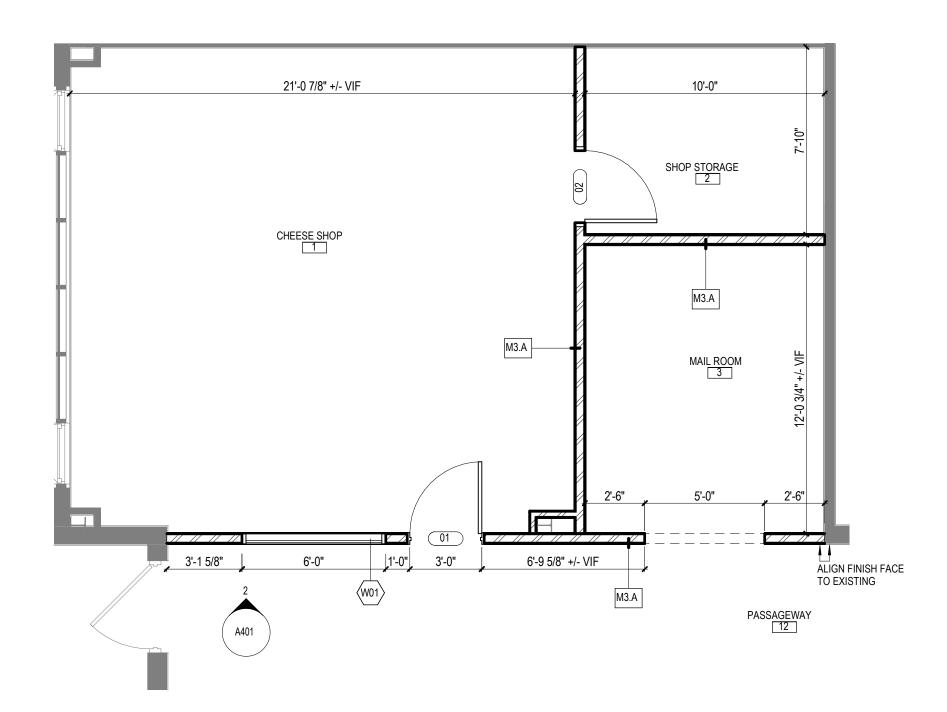
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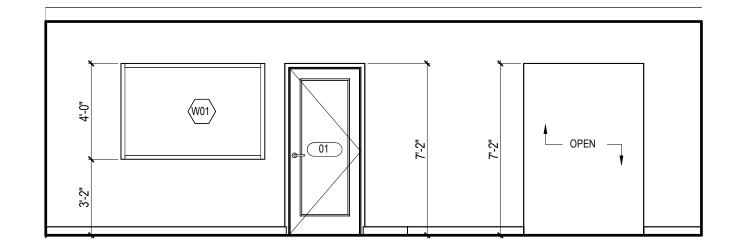






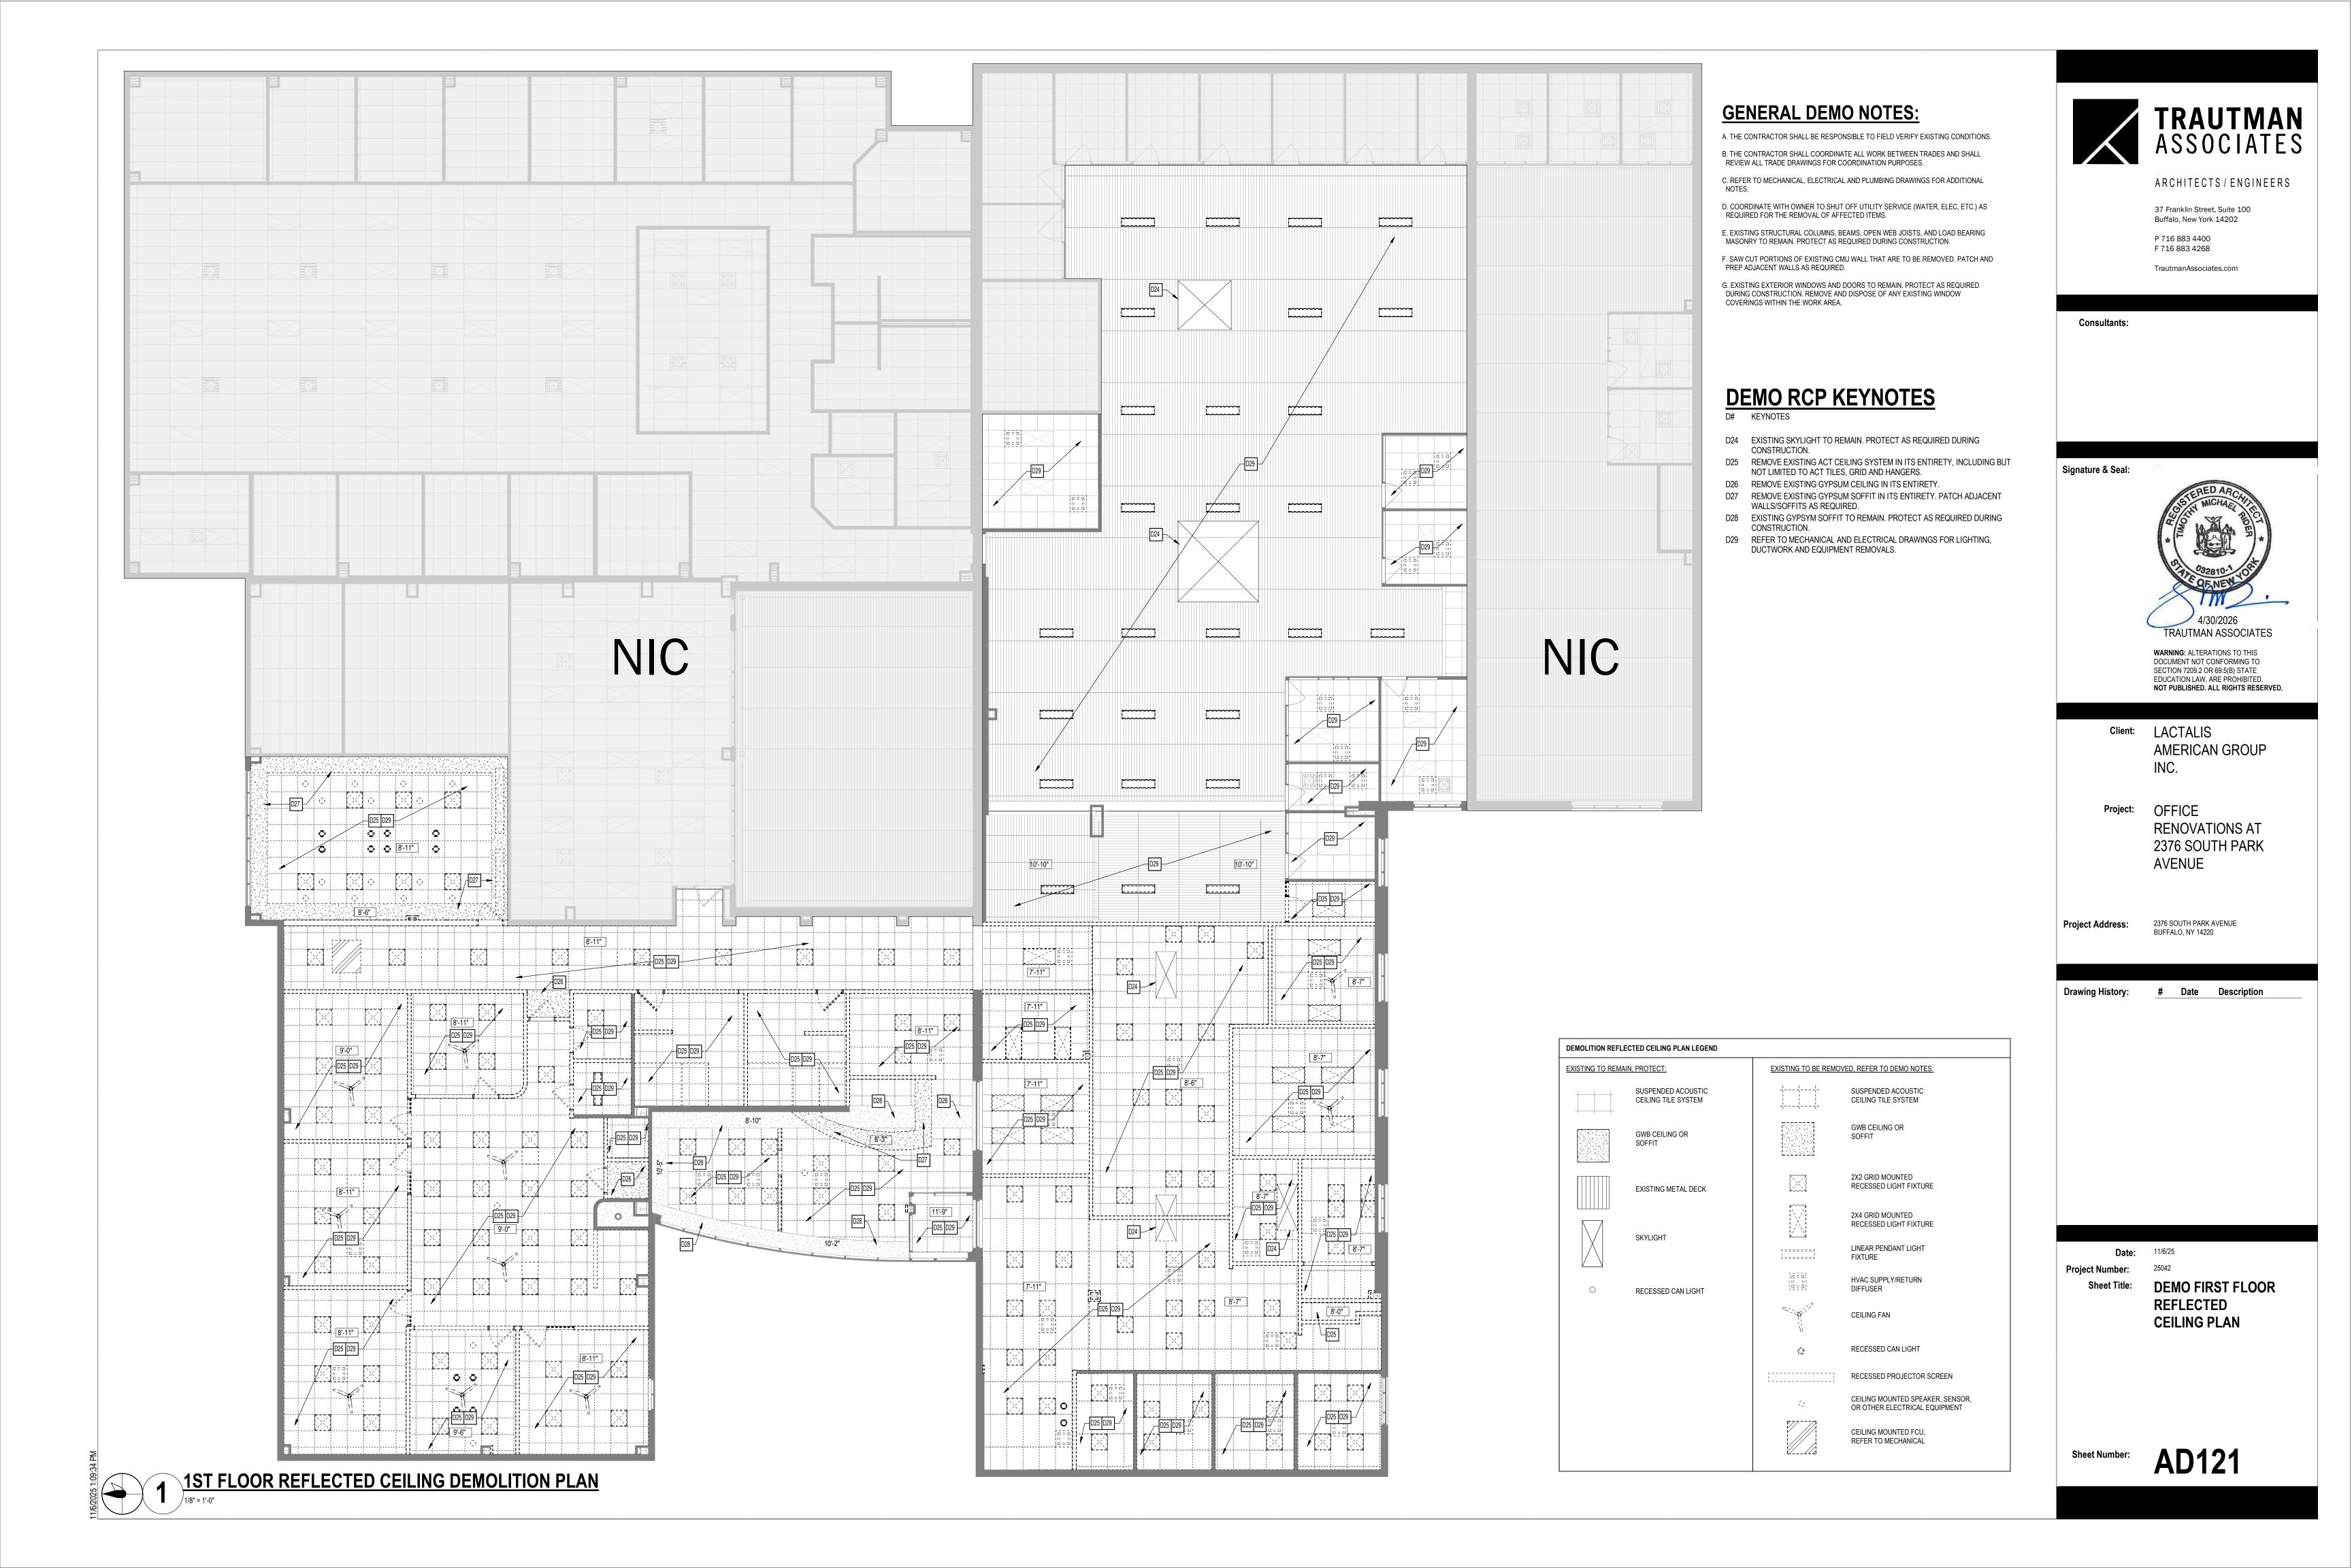

3.2 A404 PHASE 8 CALLOUT

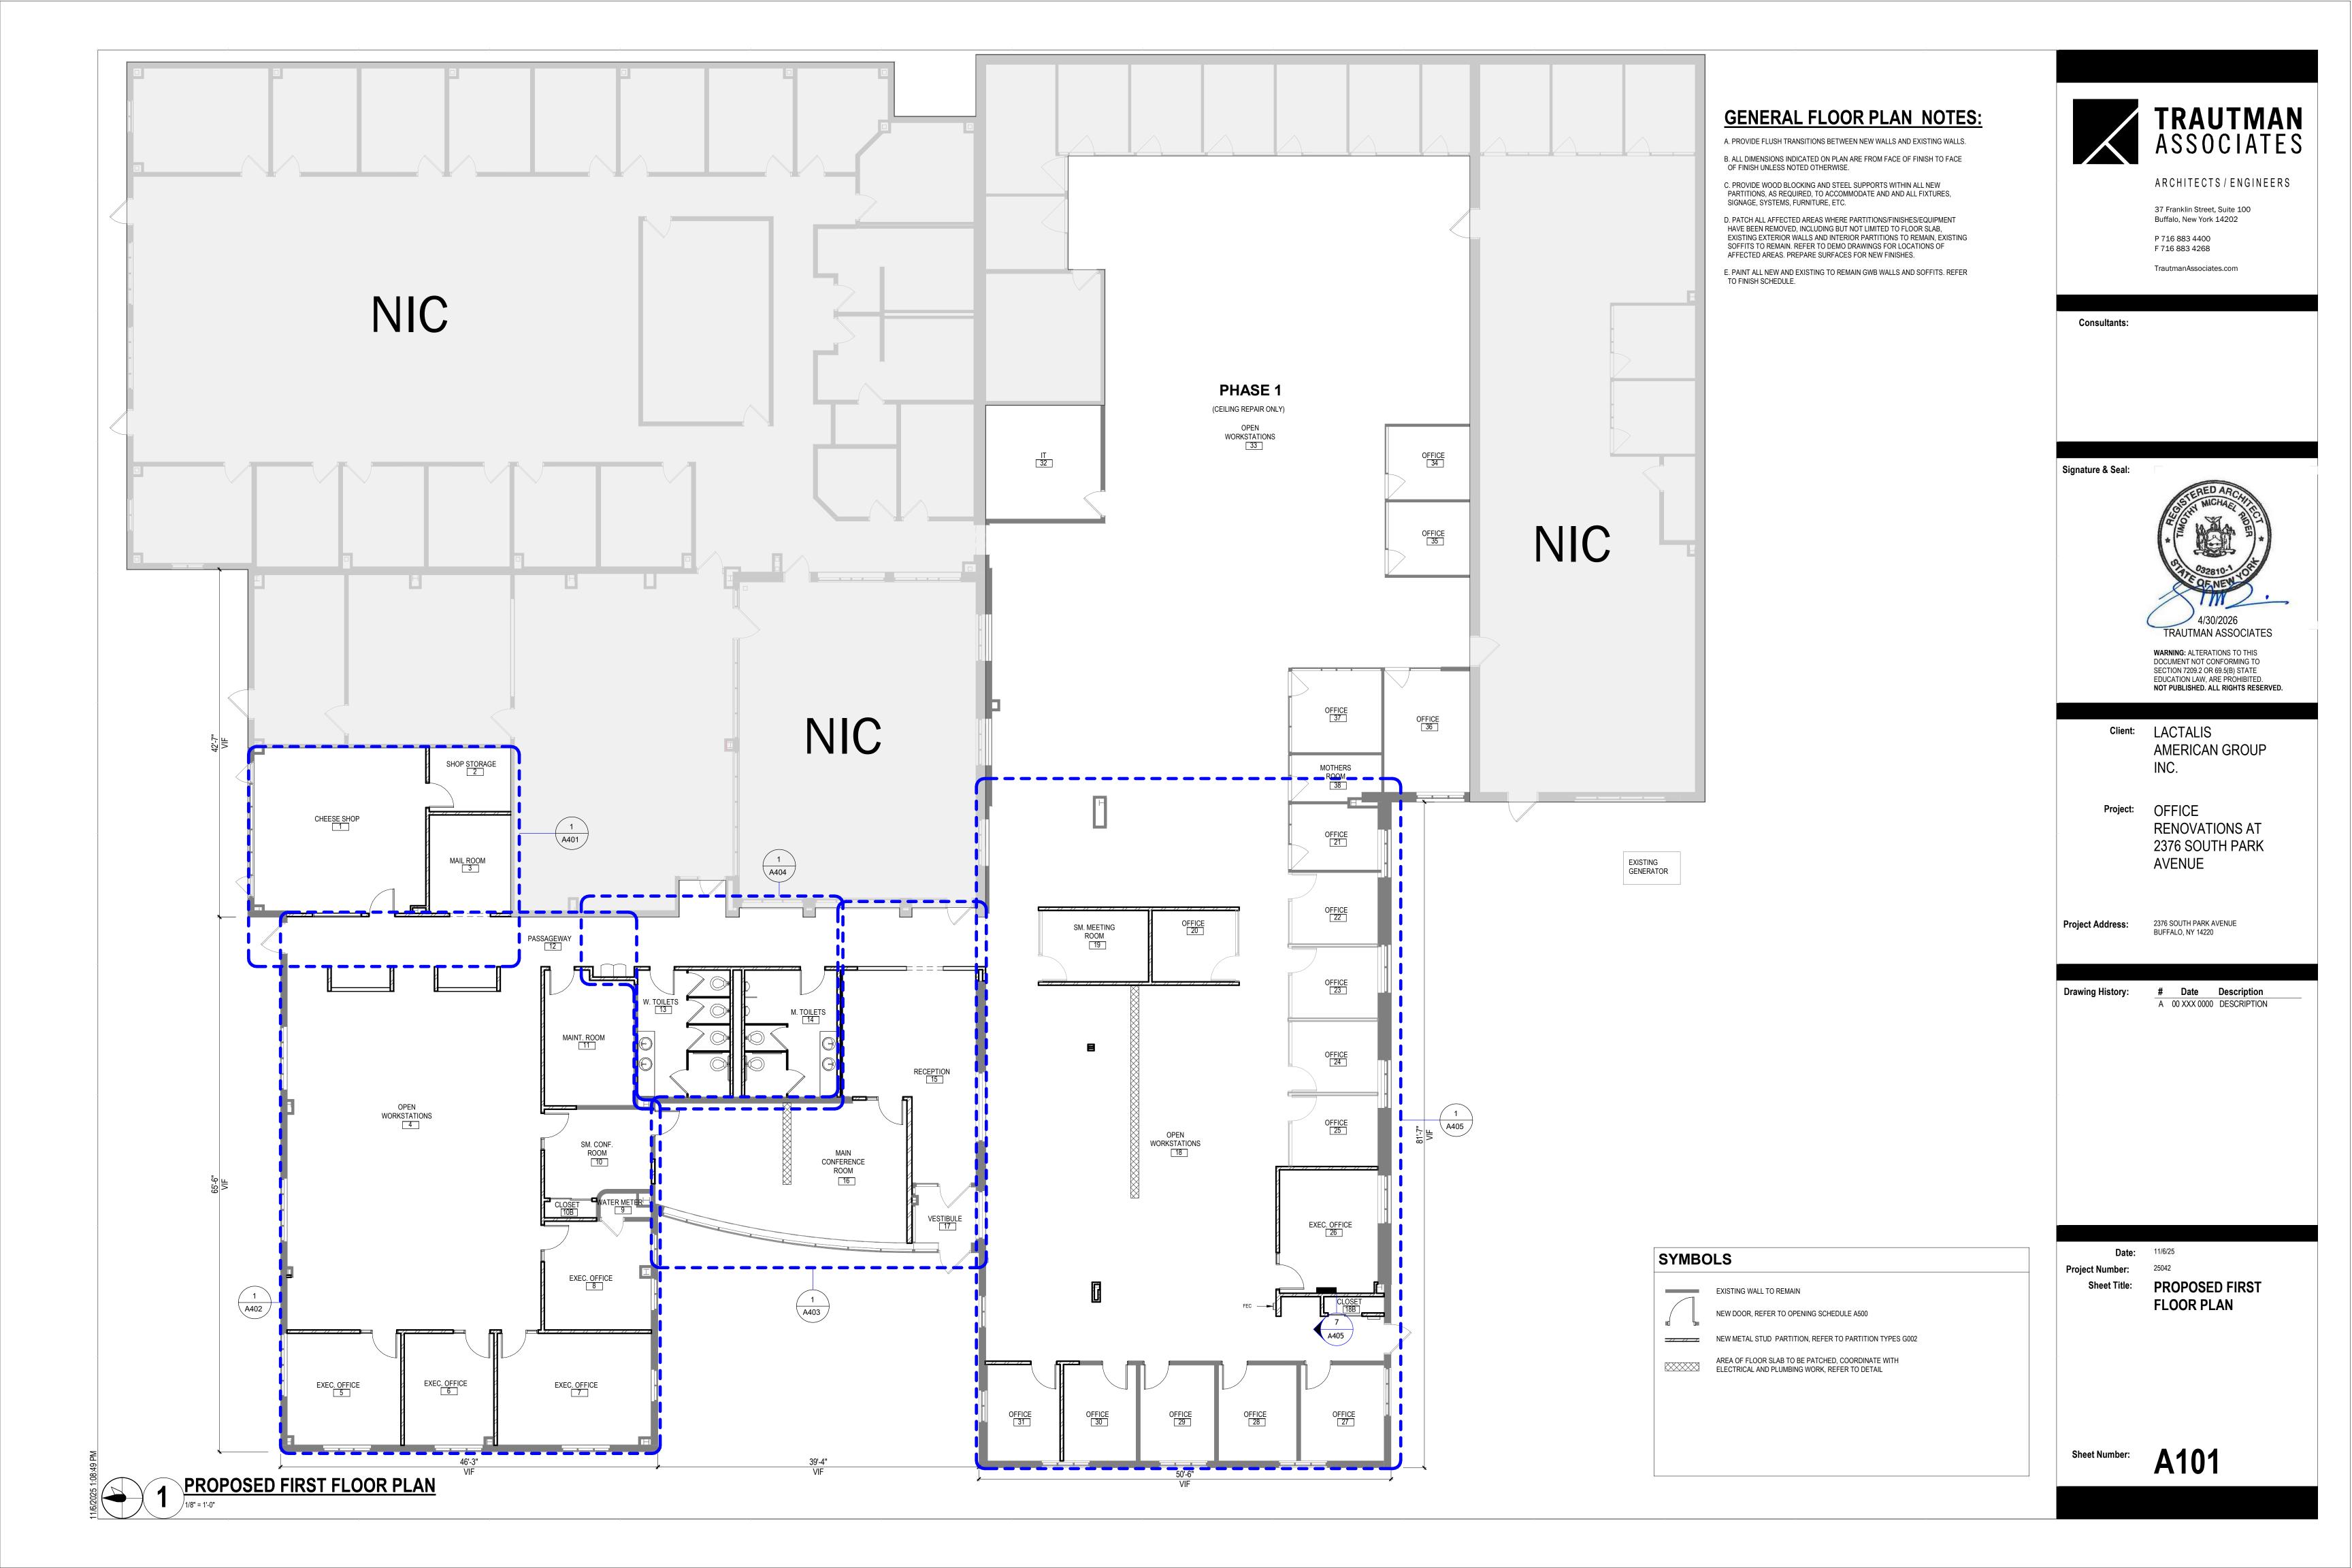

2 4.6 A404 CHEESE SHOP ENTRANCE



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Project: OFFICE

RENOVATIONS AT 2376 SOUTH PARK

AVENUE

Project Address:

2376 SOUTH PARK AVENUE BUFFALO, NY 14220

Drawing History: # Date Description


Project Number: 25042

Date: 11/6/25

Sheet Title: ENLARGED PLANS & INT. ELEVATIONS -


PHASE 2 CHEESE SHOP & MAIL ROOM ALTERATIONS

A401

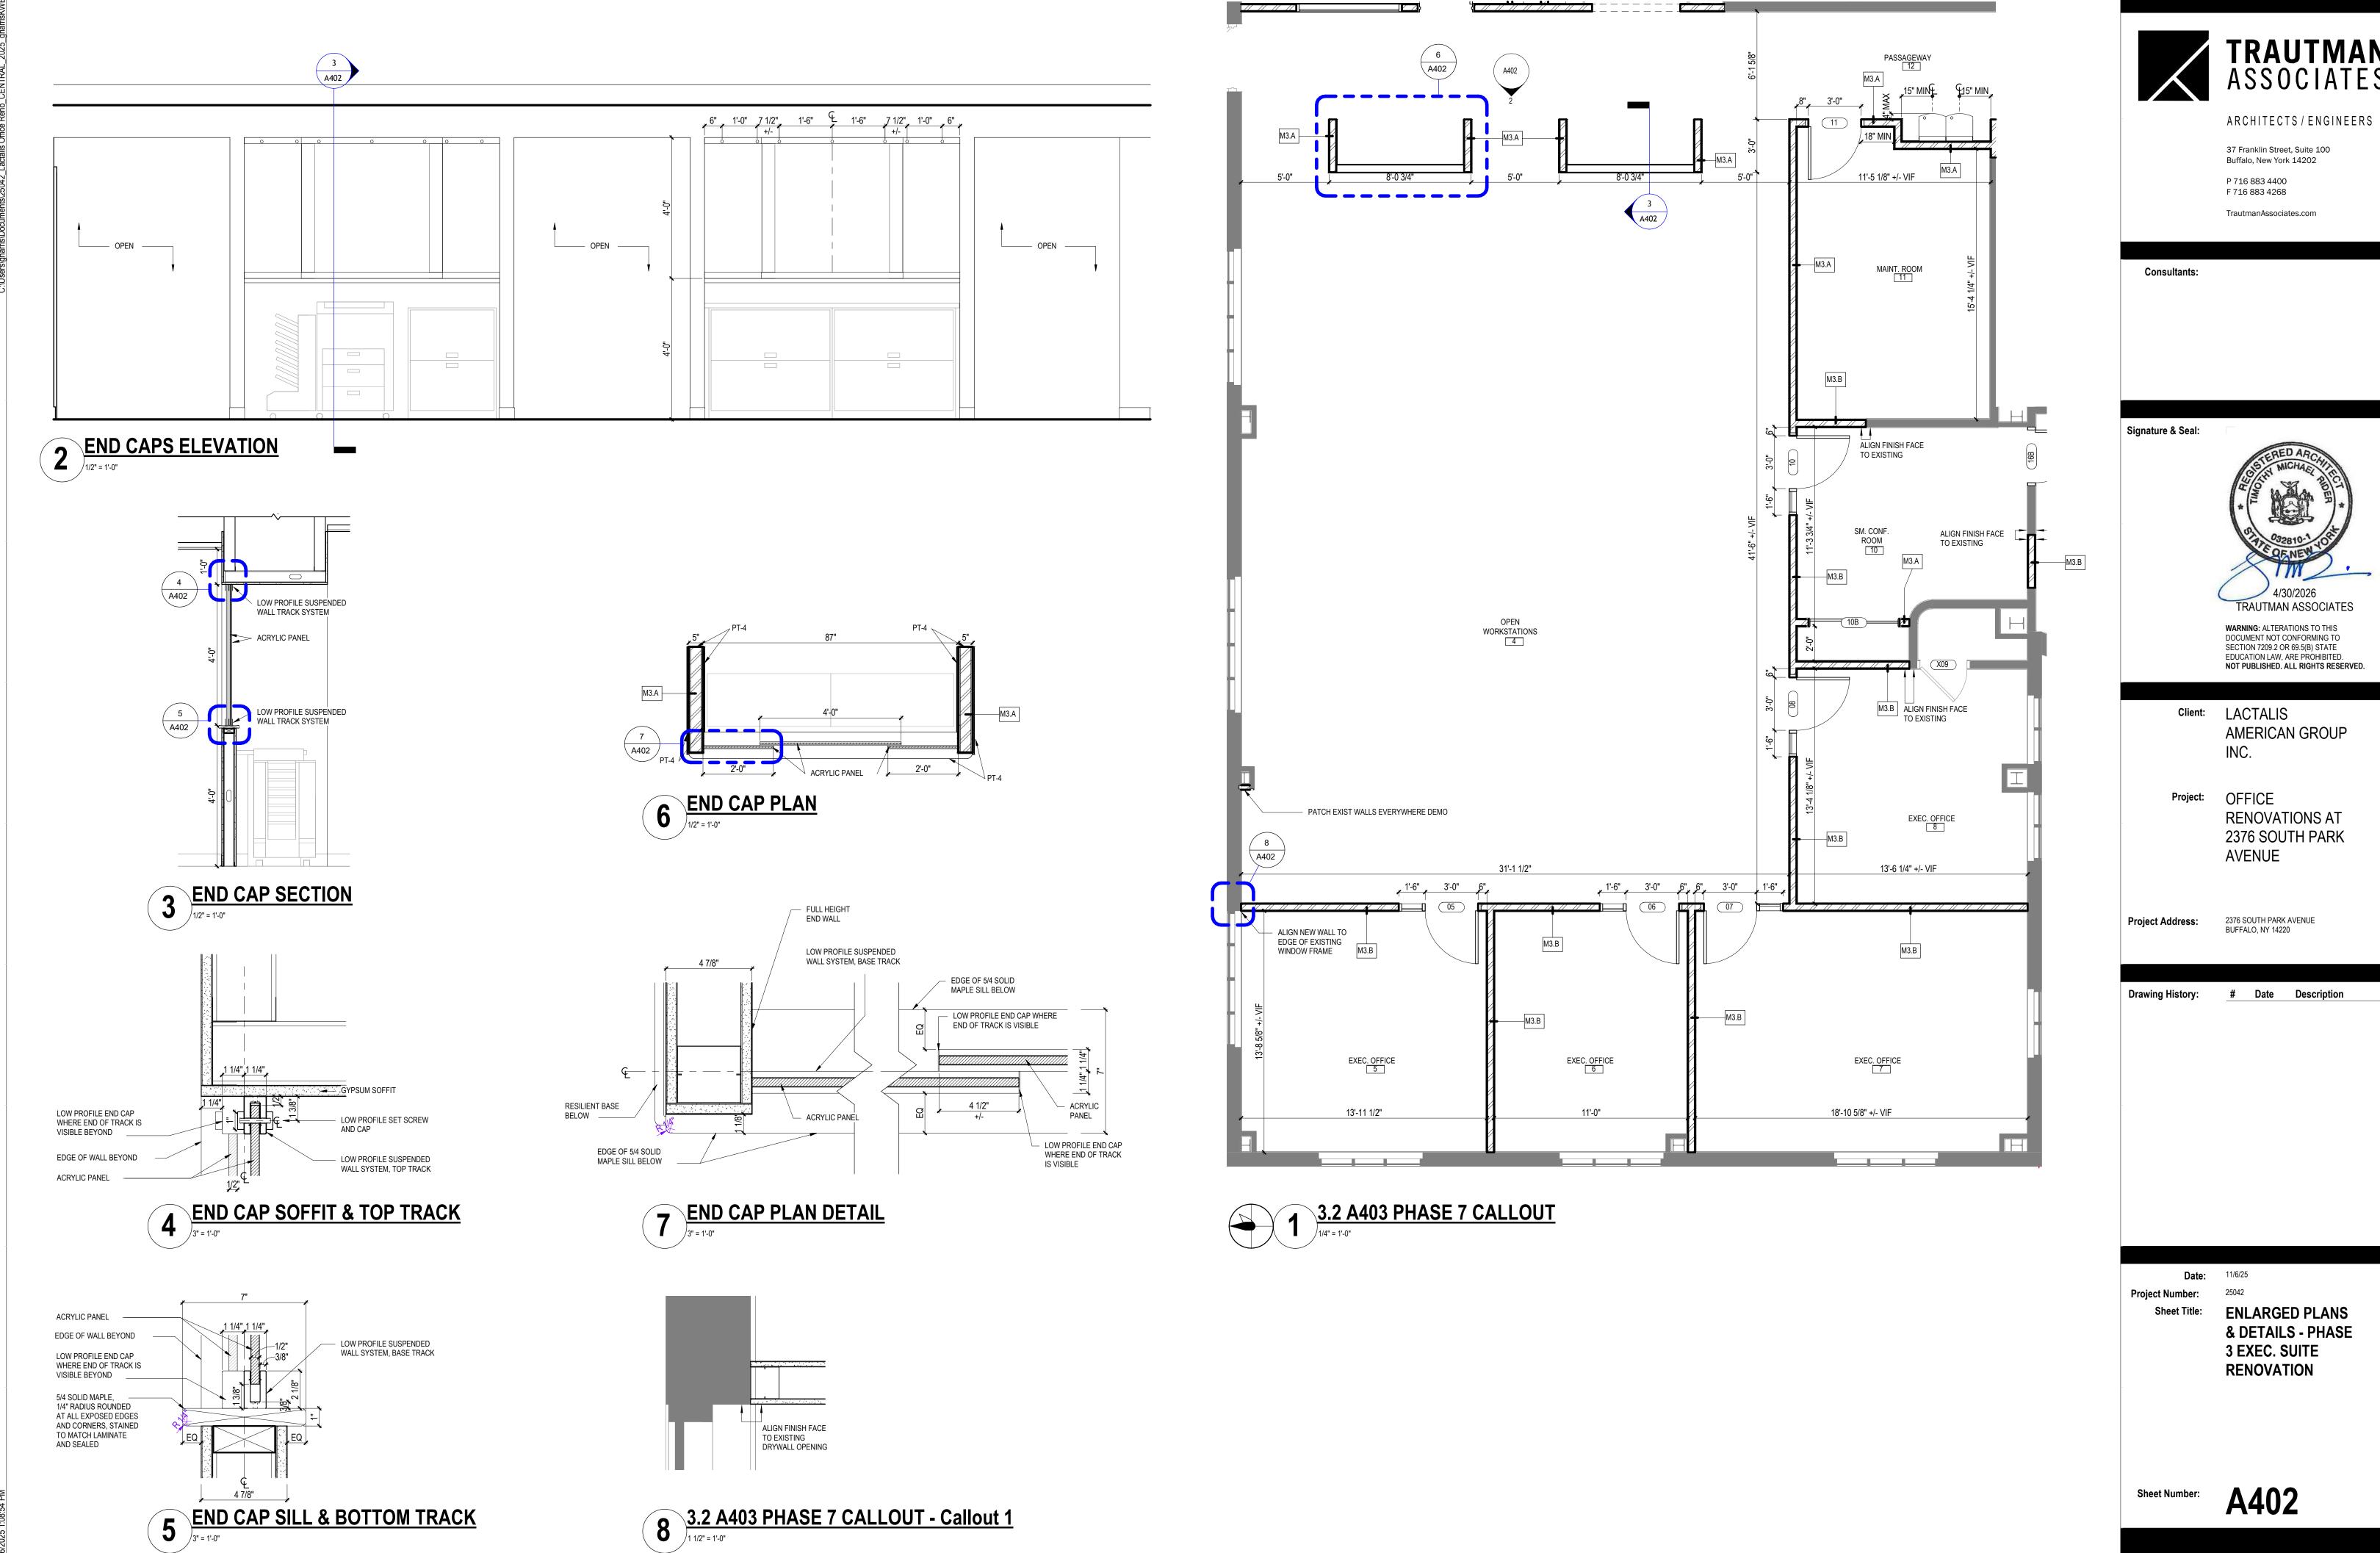



TRAUTMAN ASSOCIATES



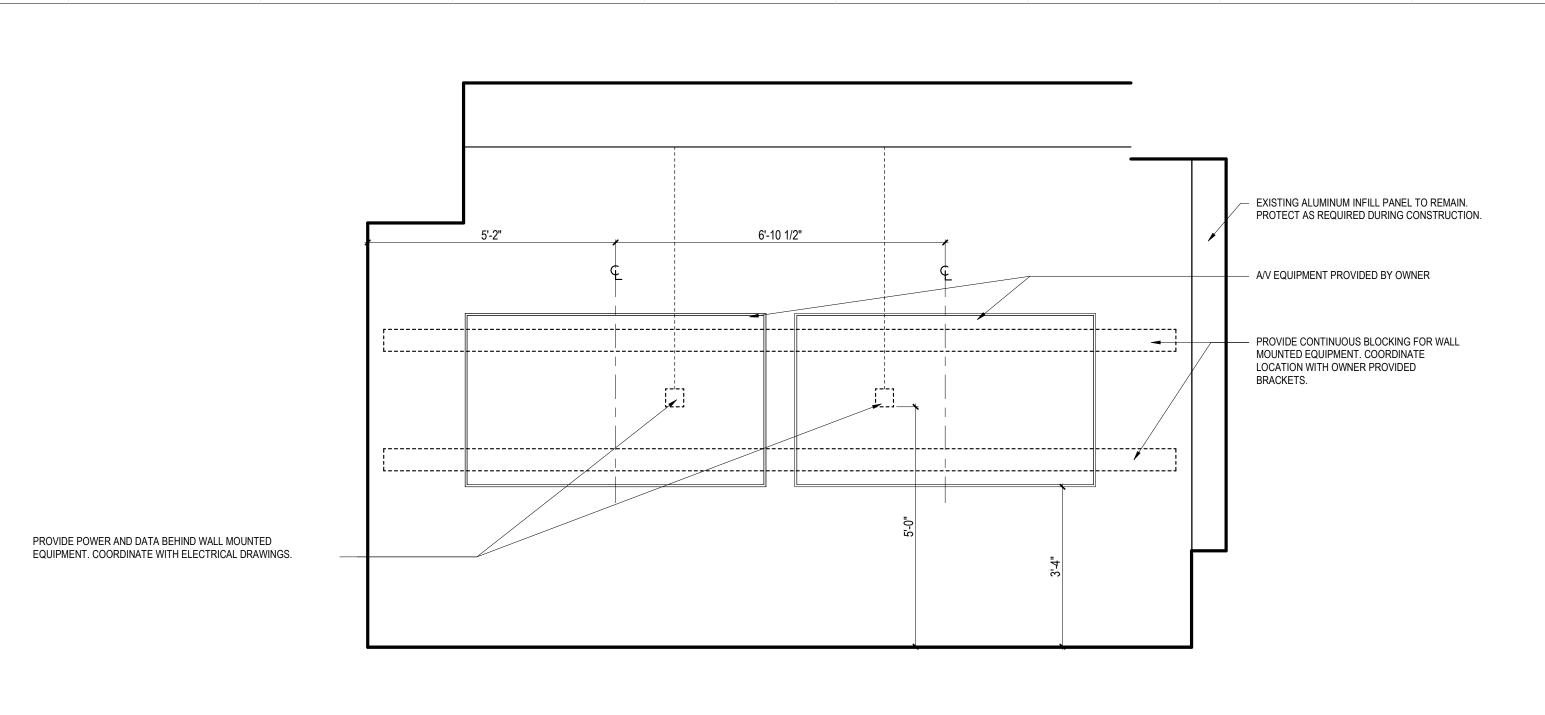

2 CONFERENCE - SOUTH
1/2" = 1'-0"

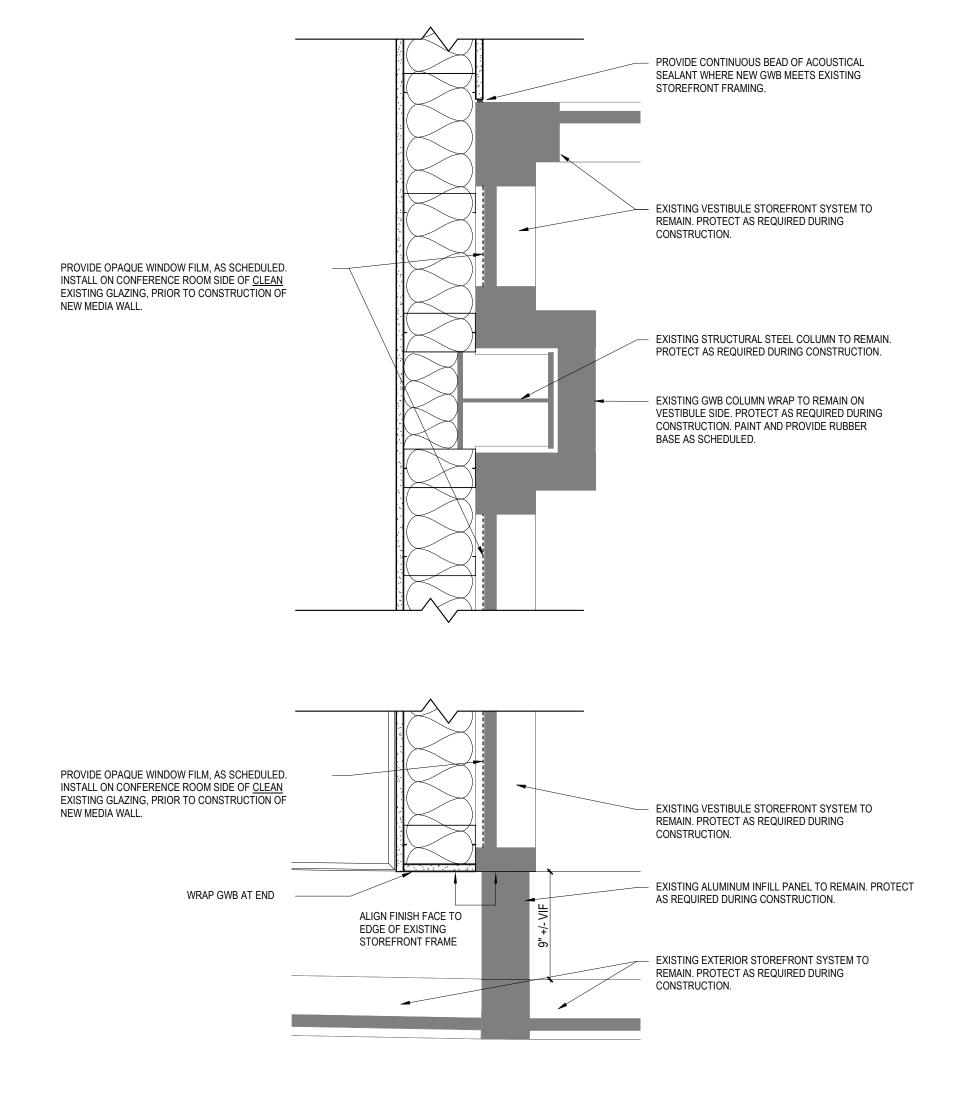

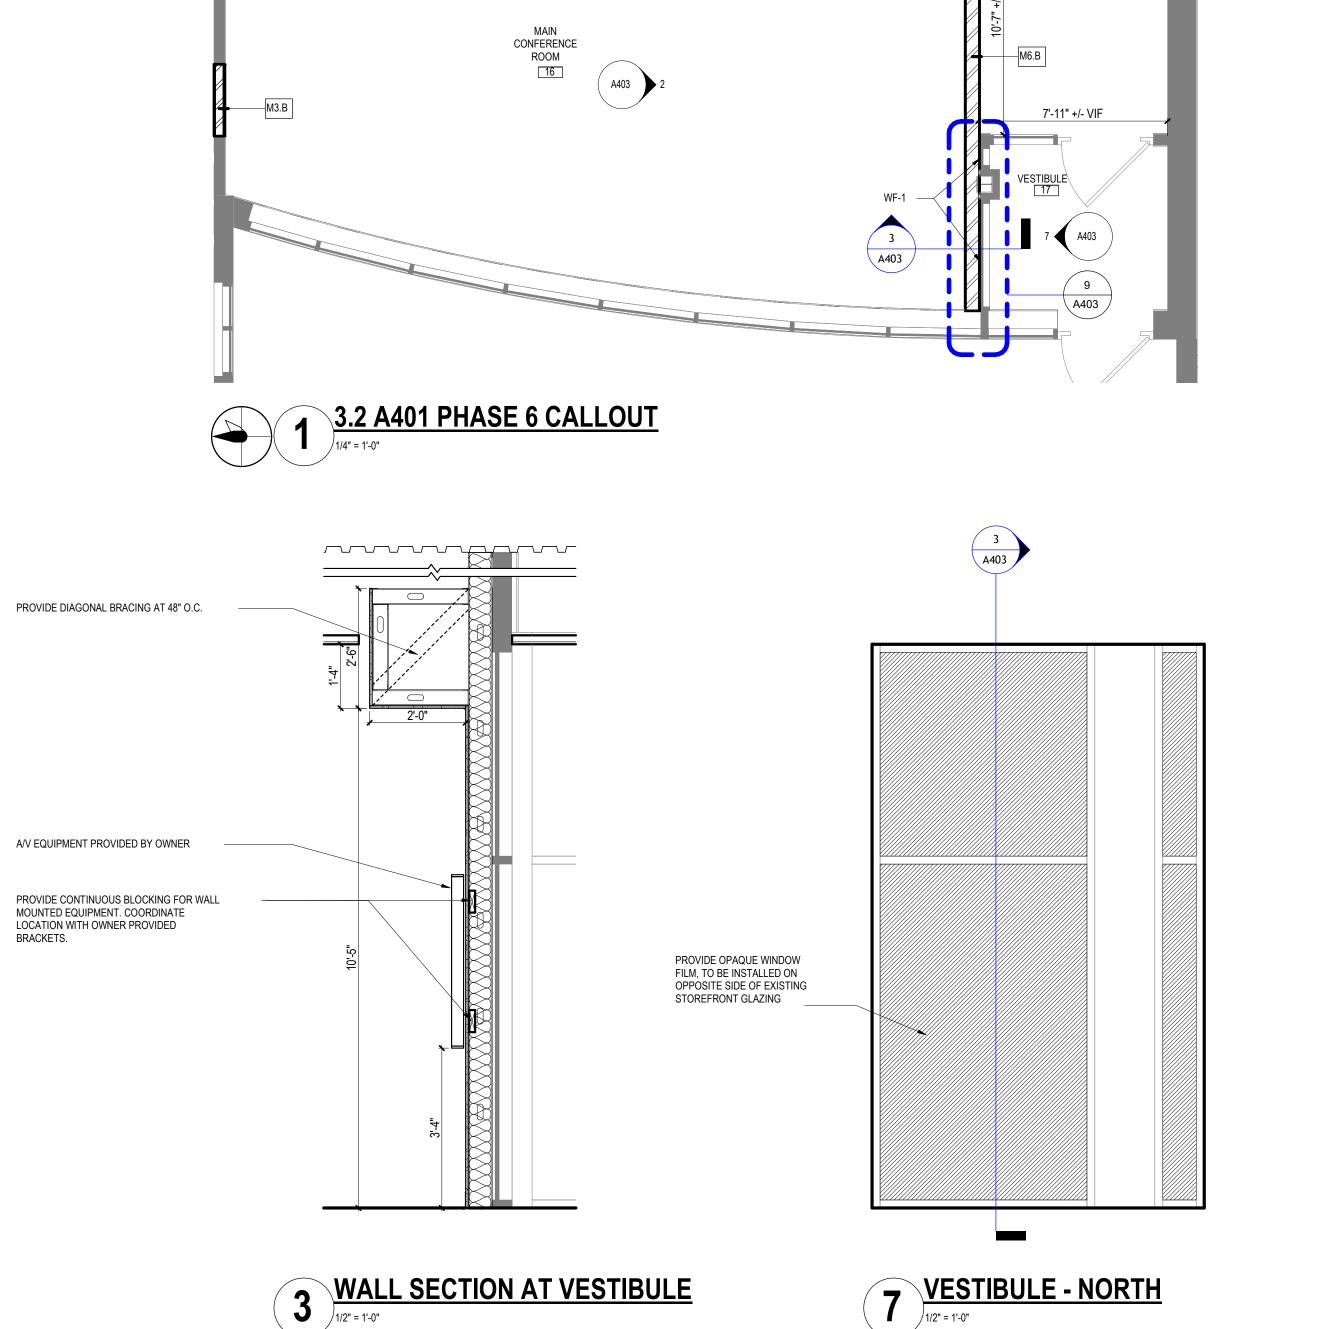

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1 A803

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2376 SOUTH PARK AVENUE


BUFFALO, NY 14220


Project Number: 25042

Date: 11/6/25

Sheet Title: ENLARGED PLANS & INT. ELEVATIONS -**PHASE 3 MAIN** CONFERENCE **ROOM**


9 NEW WALL DETAIL AT EXTERIOR STOREFRONT
1 1/2" = 1'-0"

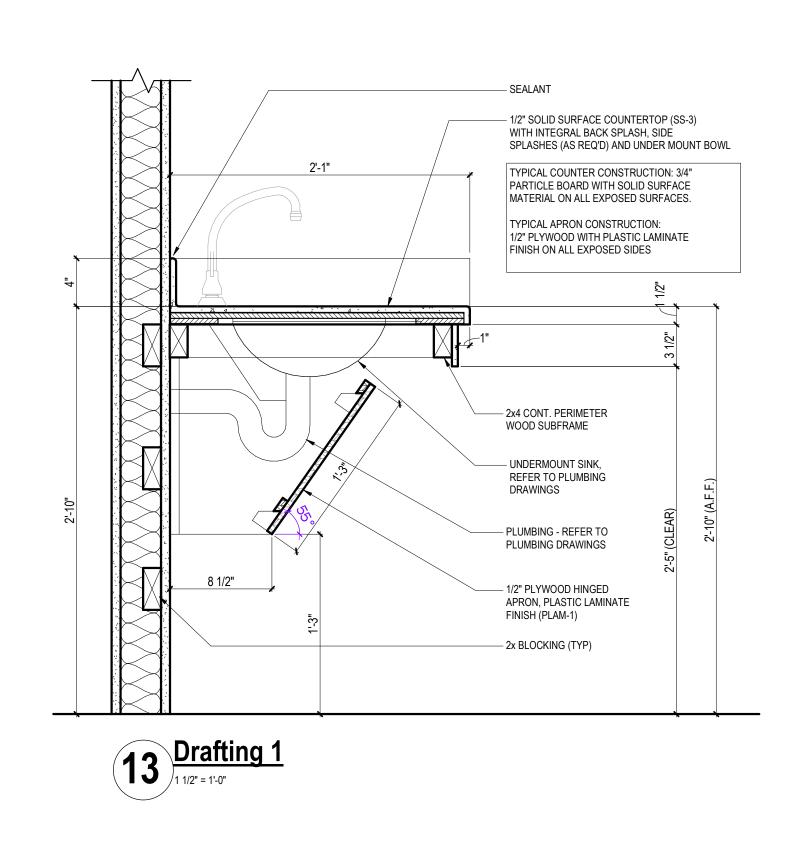

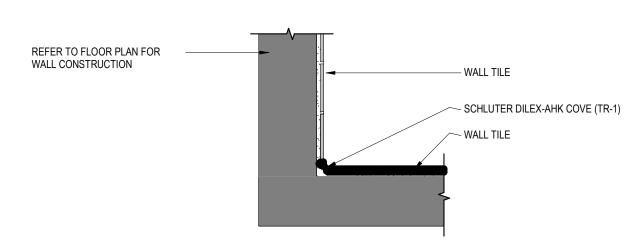


WALL COVE - DETAIL


1" = 1'-0"

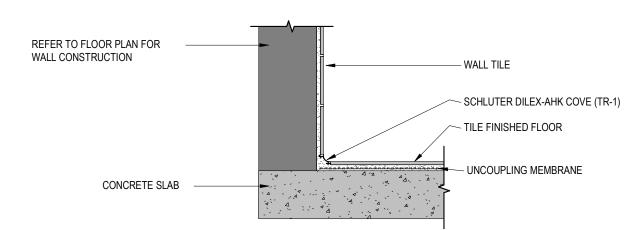



11 COVE - DETAIL


1" = 1'-0"

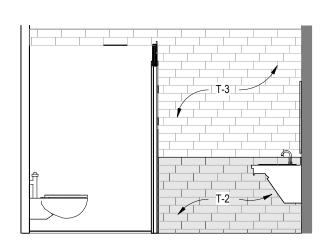

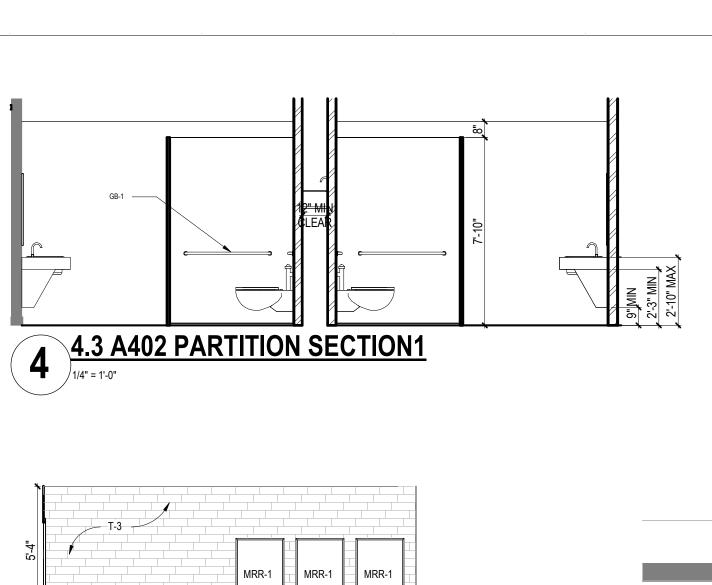


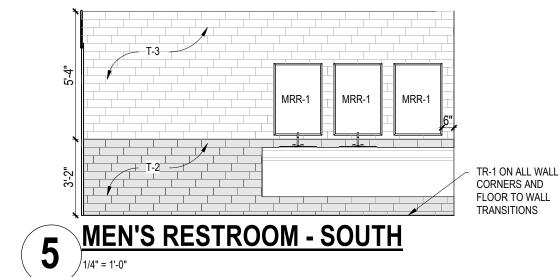

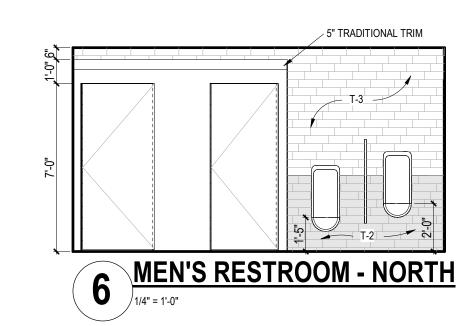


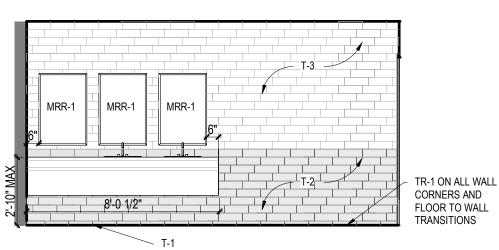



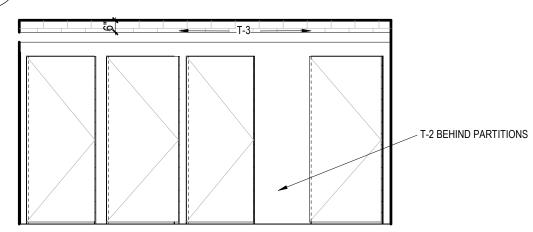

8 WOMEN'S RESTROOM - SOUTH

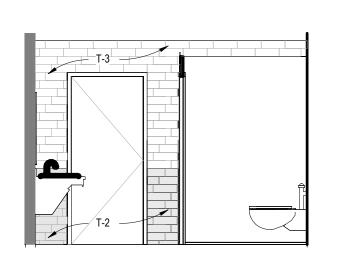

9 WOMEN'S RESTROOM - EAST



- FAUCET 1 MANUFACTURER: ELKAY MODEL: LKB736C FINISH: CHROME PLATED BRASS
 - SOAP DISPENSER 1: OWNER TO PROVIDE MIRROR 1
- MRR-1 MANUFACTURER: BRADLEY CORP SIZE: 24"X36" FRAME FINISH: STAINLESS STEEL
- GRAB BAR 1 MANUFACTURER: BOBRICK MANOTACTORER: BOSINICK

 MODEL: B-6808 SERIES
 FINISH: STAINLESS STEEL
 SIZE: REFER TO G003

11'-4"

FACE TO EXISTING

W. TOILETS

A404 /

A404

COORDINATE ALL FIXTURES

NEW BOARD OVER EXISTING STUDS SO TILE GETS A GOOD NEW SUBSTRATE

W/ PLUMBING _____

- TP-1 TOILET PARTION 1 MANUFACTURER: SCRANTON PRODUCTS
 MODEL: ARIA PARTITIONS TRADITIONAL SERIES 1000 FINISH: MIDNIGHT
- **URINAL PARTITION 1** UP-1 MANUFACTURER: SCRANTON PRODUCTS MODEL: ECLIPSE PARTITIONS WALL MOUNTED
 - FINISH: MIDNIGHT TOILET TISSUE HOLDER 1: OWNER TO PROVIDE
- TTH-1 SANITARY NAPKIN DISPOSAL 1: OWNER TO PROVIDE
- SND-1 TRASH CAN 1: OWNER TO PROVIDE TC-1 PAPER TOWEL DISPENSER 1: OWNER TO PROVIDE

M3.A

A404

M. TOILETS

PTD-1

Consultants:

Signature & Seal:



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Client: LACTALIS AMERICAN GROUP

Project: RENOVATIONS AT 2376 SOUTH PARK AVENUE

2376 SOUTH PARK AVENUE BUFFALO, NY 14220 **Project Address:**

Date Description

Project Number:

Date: 11/6/25

ENLARGED PLANS & INT. ELEVATIONS -PHASE 3

RESTROOMS

A404

10 WOMEN'S RESTROOM - WEST

3 4.2 A402 WATER FOUNTAIN


1/2" = 1'-0"


1 PHASE 3 - RESTROOM CALLOUT

2 4.2 A402 DRINKING FOUNTAIN


1/2" = 1'-0"

5'-0 3/4"

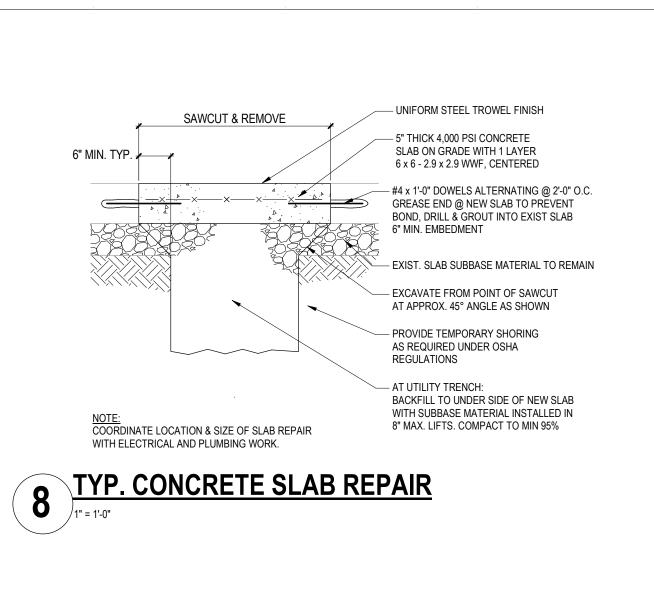

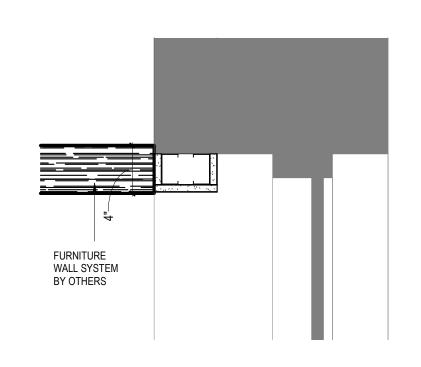


PURN. WALL AT WINDOW - S4
1 1/2" = 1'-0"

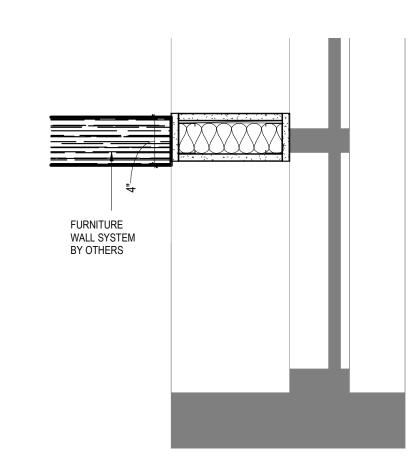


3 FURN. WALL AT WINDOW - S3

4 COLUMN WRAP DETAIL - TIGHT


1 1/2" = 1'-0"

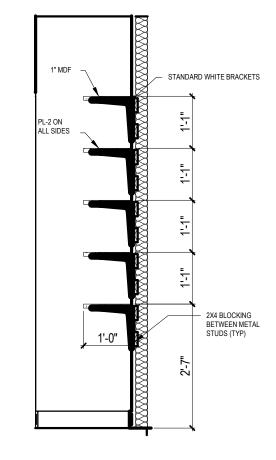


7 SHELVING DETAIL
1/2" = 1'-0"

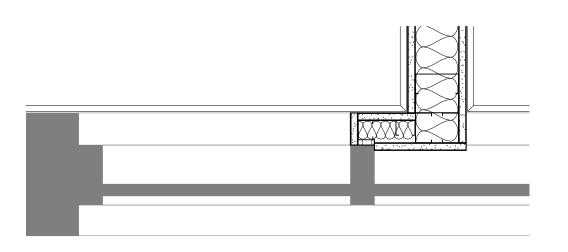

6 STUD WALL AT WINDOW - W1
1 1/2" = 1'-0"

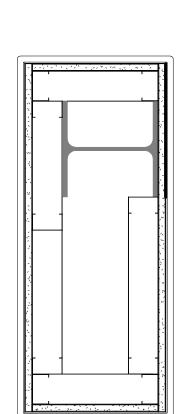

5 COLUMN WRAP DETAIL
1 1/2" = 1'-0"

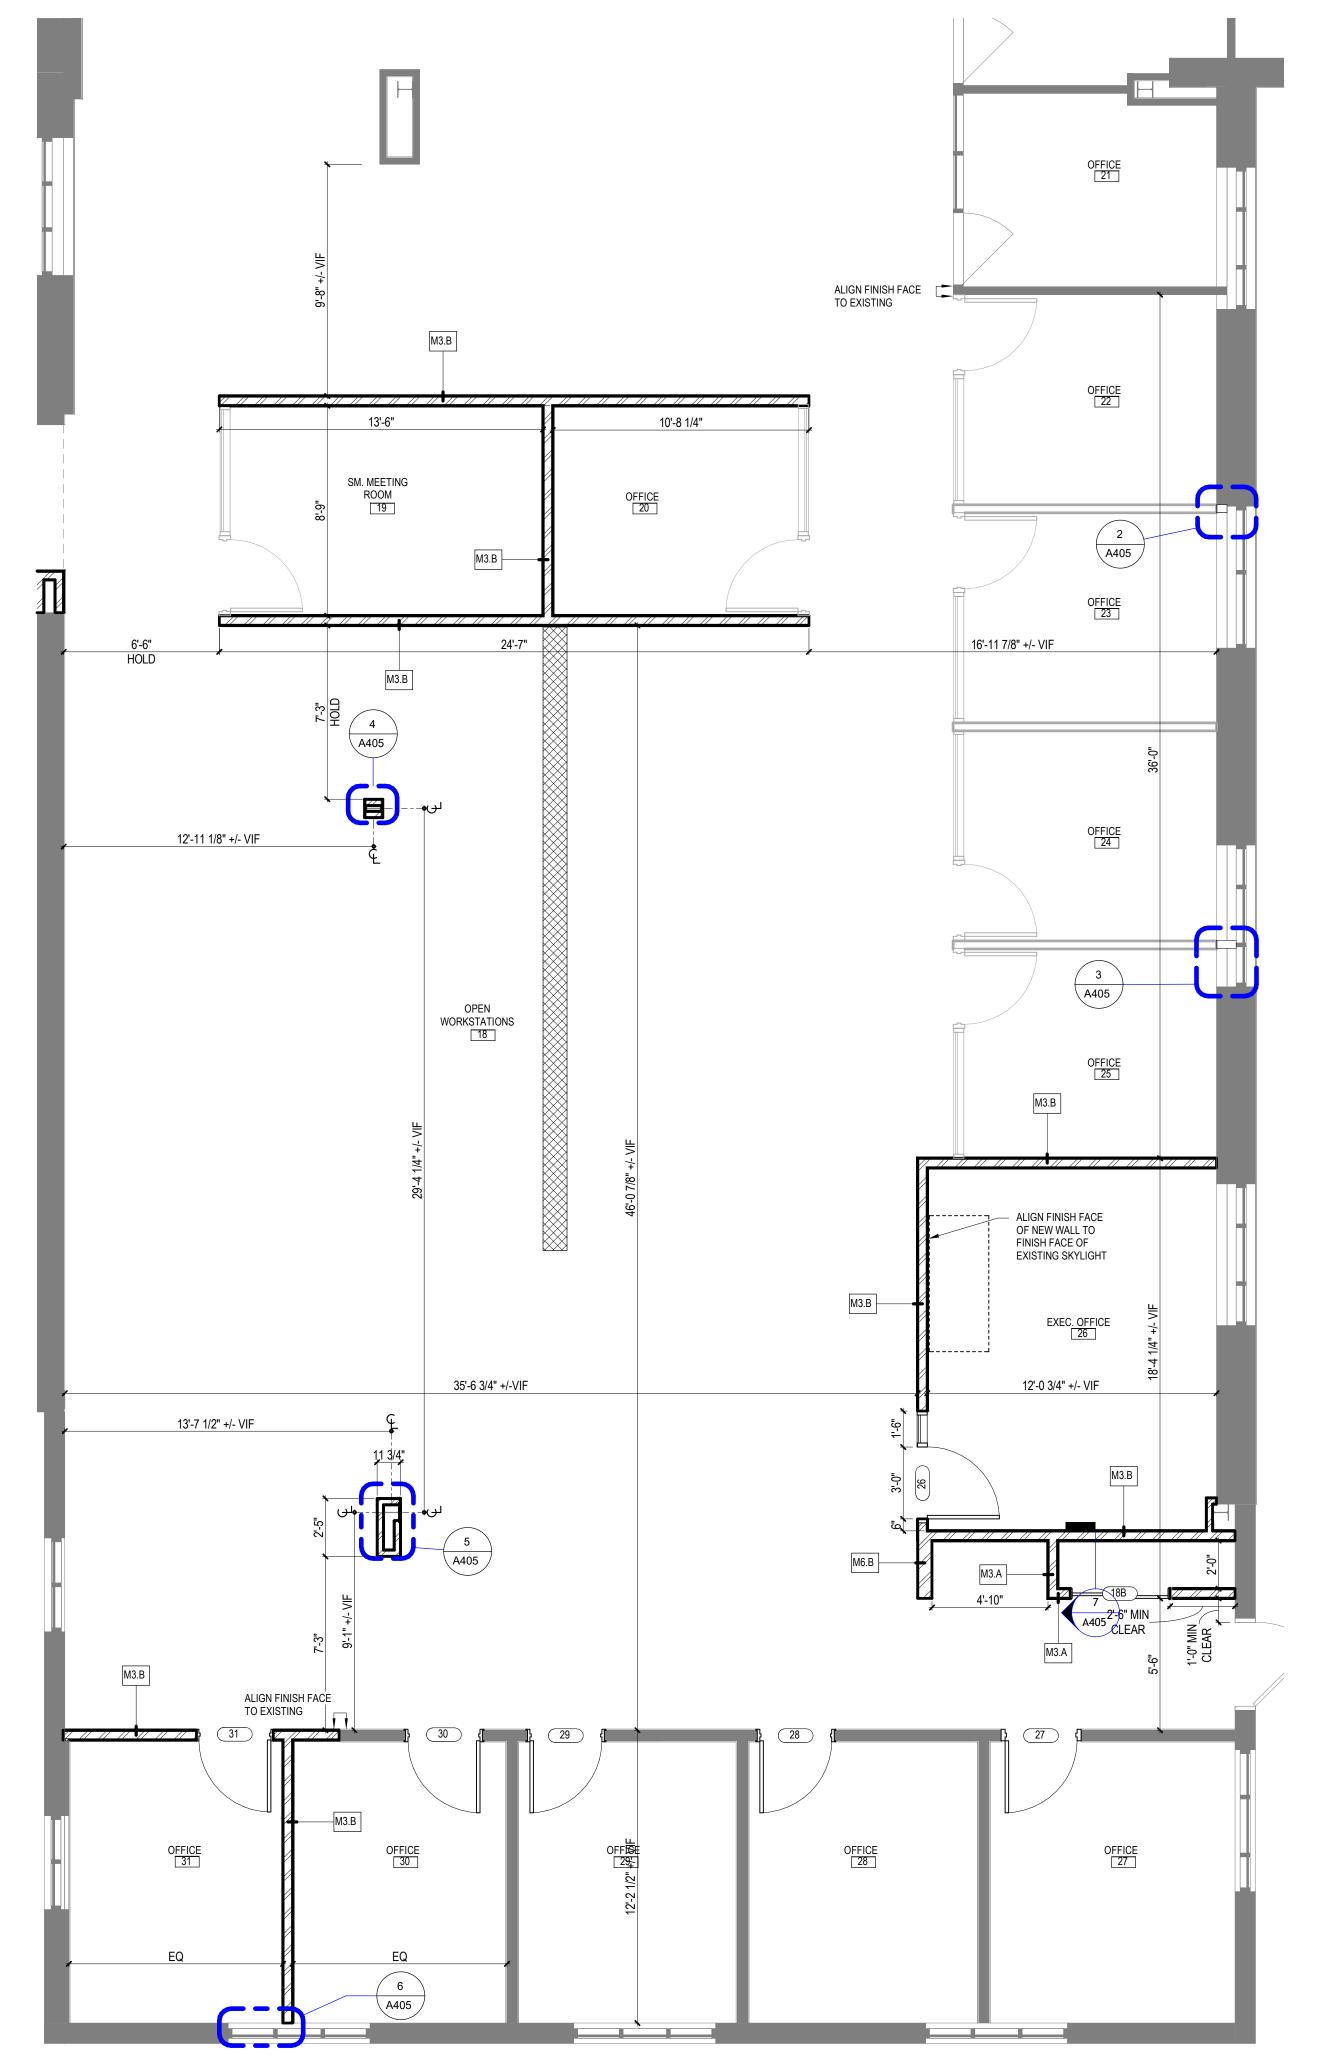

1 3.2 A400 PHASE 1/5 CALLOUT

TRAUTMAN ASSOCIATES ARCHITECTS / ENGINEERS 37 Franklin Street, Suite 100 Buffalo, New York 14202 P 716 883 4400 F 716 883 4268 TrautmanAssociates.com

Consultants:

Signature & Seal:



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Client: LACTALIS AMERICAN GROUP

Project: **RENOVATIONS AT** 2376 SOUTH PARK **AVENUE**

2376 SOUTH PARK AVENUE BUFFALO, NY 14220

Date Description

Date: 11/6/25 Project Number:

Sheet Title: ENLARGED PLANS & INT. ELEVATIONS -PHASE 4 HR & OPEN


OFFICE

A405


SET #01 - DOORS: 0	<u>CHEESE SHOP</u> 1			
3	HINGES	BB1279 4 1/2 x 4 1/2	US26D	HA
1 1	STOREROOM LOCKSET SFIC CORE	3480 WTN SFIC 3982	US26D US26D	H <i>A</i> H <i>A</i>
1	CLOSER	5100 HDHOCS	ALM	HA
1 3	WALL STOP SILENCERS	232W 307D	US26D GREY	H <i>A</i> H <i>A</i>
3	SILENCERS	3070	GRET	ПА
SET #02 - 3 DOORS: 03	STORAGE & MAINTENANCE 2, 11			
3	HINGES	BB1279 4 1/2 x 4 1/2	US26D	HA
1 1	STOREROOM LOCKSET SFIC CORE	3480 WTN SFIC 3982	US26D US26D	H <i>A</i> H <i>A</i>
1	CLOSER	5100	ALM	H/
1	KICK PLATE	190S 10" x 2" LDW	US26D	HA
1 3	WALL STOP/HOLDER SILENCERS	327W 307D	US26D GREY	H/ H/
SET #03 - (<u>OFFICES</u> 5, 06, 07, 08, 10, 26, 27, 28, 29, 30, 31			
3	HINGES	BB1279 4 1/2 x 4 1/2	US26D	H
1	OFFICE LOCKSET	3450 WTN SFIC	US26D	H
1 1	SFIC CORE WALL STOP	3982 232W	US26D US26D	H <i>A</i> H <i>A</i>
1	COAT & HAT HOOK	BL6610	US26D	H.
3	SILENCERS	307D	GREY	H
SET #04 -	CLOSETS			
DOORS: 1	DB, 18B			
1 1 1	BYPASS DOOR HARDWARE BYPASS DOOR LOCK	9611CS 9268	NONE US26D	
DOORS: 1 1 1	DB, 18B BYPASS DOOR HARDWARE BYPASS DOOR LOCK TOILET ROOMS			
DOORS: 10 1 1 1 SET #05 - 10 DOORS: 10	DB, 18B BYPASS DOOR HARDWARE BYPASS DOOR LOCK TOILET ROOMS 3, 14 HINGES	9268 BB1168 4 1/2 x 4 1/2	US26D US26D	H <i>i</i>
1 1 1 SET #05 - 1	DB, 18B BYPASS DOOR HARDWARE BYPASS DOOR LOCK TOILET ROOMS 3, 14	9268	US26D	H <i>i</i> H <i>i</i> H <i>i</i>
DOORS: 10 1 1 1 SET #05 - 10 DOORS: 11 3 1 1 1	DB, 18B BYPASS DOOR HARDWARE BYPASS DOOR LOCK TOILET ROOMS 3, 14 HINGES PUSH PLATE PULL PLATE CLOSER	9268 BB1168 4 1/2 x 4 1/2 30S 8 x 16 H 33J 4 x 16 5100	US26D US26D US26D US26D ALM	H/ H/ H/ H/
DOORS: 10 1 1 1 SET #05 - 10 DOORS: 11 3 1 1 1 1	BYPASS DOOR HARDWARE BYPASS DOOR LOCK TOILET ROOMS 3, 14 HINGES PUSH PLATE PULL PLATE CLOSER KICK PLATE	9268 BB1168 4 1/2 x 4 1/2 30S 8 x 16 H 33J 4 x 16 5100 190S 10" x 2" LDW	US26D US26D US26D US26D ALM US26D	H/ H/ H/ H/ H/
DOORS: 10 1 1 1 SET #05 - 10 DOORS: 10 3 1 1 1 1 1 1	BYPASS DOOR HARDWARE BYPASS DOOR LOCK TOILET ROOMS 3, 14 HINGES PUSH PLATE PULL PLATE CLOSER KICK PLATE MOP PLATE WALL STOP	9268 BB1168 4 1/2 x 4 1/2 30S 8 x 16 H 33J 4 x 16 5100 190S 10" x 2" LDW 190S 6" x 1" LDW 232W	US26D US26D US26D US26D ALM US26D US26D US26D	H/ H/ H/ H/ H/ H/ H/
DOORS: 10 1 1 1 SET #05 - 1 DOORS: 13 3 1 1 1 1 1	BYPASS DOOR HARDWARE BYPASS DOOR LOCK TOILET ROOMS 3, 14 HINGES PUSH PLATE PULL PLATE CLOSER KICK PLATE MOP PLATE	9268 BB1168 4 1/2 x 4 1/2 30S 8 x 16 H 33J 4 x 16 5100 190S 10" x 2" LDW 190S 6" x 1" LDW	US26D US26D US26D US26D ALM US26D US26D	H/ H/ H/ H/ H/ H/ H/
DOORS: 1: 1 1 SET #05 - 1: DOORS: 1: 3 1 1 1 1 1 1 3	BYPASS DOOR HARDWARE BYPASS DOOR LOCK TOILET ROOMS 3, 14 HINGES PUSH PLATE PULL PLATE CLOSER KICK PLATE MOP PLATE WALL STOP SILENCERS	9268 BB1168 4 1/2 x 4 1/2 30S 8 x 16 H 33J 4 x 16 5100 190S 10" x 2" LDW 190S 6" x 1" LDW 232W	US26D US26D US26D US26D ALM US26D US26D US26D	H/ H/ H/ H/ H/ H/ H/
DOORS: 11 1 1 SET #05 - DOORS: 1: 3 1 1 1 1 1 3 SET #06 - DOORS: 1:	BYPASS DOOR HARDWARE BYPASS DOOR LOCK TOILET ROOMS 3, 14 HINGES PUSH PLATE PULL PLATE CLOSER KICK PLATE MOP PLATE WALL STOP SILENCERS CONFERENCE ROOM 6 HINGES	9268 BB1168 4 1/2 x 4 1/2 30S 8 x 16 H 33J 4 x 16 5100 190S 10" x 2" LDW 190S 6" x 1" LDW 232W 307D	US26D US26D US26D US26D ALM US26D US26D US26D US26D US26D	H) H) H) H) H) H)
DOORS: 11 1 1 SET #05 - DOORS: 1: 3 1 1 1 1 1 3 SET #06 - DOORS: 1:	BYPASS DOOR HARDWARE BYPASS DOOR LOCK TOILET ROOMS 3, 14 HINGES PUSH PLATE PULL PLATE CLOSER KICK PLATE MOP PLATE WALL STOP SILENCERS CONFERENCE ROOM 6 HINGES OFFICE LOCKSET	BB1168 4 1/2 x 4 1/2 30S 8 x 16 H 33J 4 x 16 5100 190S 10" x 2" LDW 190S 6" x 1" LDW 232W 307D BB1279 4 1/2 x 4 1/2 3450 WTN SFIC	US26D US26D US26D US26D ALM US26D US26D US26D US26D US26D US26D	H/ H/ H/ H/ H/ H/ H/
DOORS: 1 1 1 1 1 SET #05 - DOORS: 1: 3 1 1 1 1 1 1 1 3 SET #06 - DOORS: 1:	BYPASS DOOR HARDWARE BYPASS DOOR LOCK TOILET ROOMS 3, 14 HINGES PUSH PLATE PULL PLATE CLOSER KICK PLATE MOP PLATE WALL STOP SILENCERS CONFERENCE ROOM 6 HINGES	9268 BB1168 4 1/2 x 4 1/2 30S 8 x 16 H 33J 4 x 16 5100 190S 10" x 2" LDW 190S 6" x 1" LDW 232W 307D	US26D US26D US26D US26D ALM US26D US26D US26D US26D US26D	H/ H/ H/ H/ H/ H/ H/
DOORS: 11 1 1 1 SET #05 - DOORS: 1: 3 1 1 1 1 1 3 SET #06 - DOORS: 1: 3 1 1 1 1 1 1 1 1 1 1 1 1 1 1 1 1 1 1	BYPASS DOOR HARDWARE BYPASS DOOR LOCK TOILET ROOMS 3, 14 HINGES PUSH PLATE PULL PLATE CLOSER KICK PLATE MOP PLATE WALL STOP SILENCERS CONFERENCE ROOM 6 HINGES OFFICE LOCKSET SFIC CORE	BB1168 4 1/2 x 4 1/2 30S 8 x 16 H 33J 4 x 16 5100 190S 10" x 2" LDW 190S 6" x 1" LDW 232W 307D BB1279 4 1/2 x 4 1/2 3450 WTN SFIC 3982	US26D	H/ H/ H/ H/ H/ H/ H/ H/ H/ H/ H/ H/ H/ H
DOORS: 11 1 1 SET #05 - DOORS: 1: 3 1 1 1 1 3 SET #06 - 0 DOORS: 1: 3 1 1 1 3 SET #07 - 0	BYPASS DOOR HARDWARE BYPASS DOOR LOCK TOILET ROOMS 3, 14 HINGES PUSH PLATE PULL PLATE CLOSER KICK PLATE MOP PLATE WALL STOP SILENCERS CONFERENCE ROOM 6 HINGES OFFICE LOCKSET SFIC CORE WALL STOP SILENCERS	BB1168 4 1/2 x 4 1/2 30S 8 x 16 H 33J 4 x 16 5100 190S 10" x 2" LDW 190S 6" x 1" LDW 232W 307D BB1279 4 1/2 x 4 1/2 3450 WTN SFIC 3982 232W 307D	US26D	H) H) H) H) H) H) H) H) H) H) H)
DOORS: 11 1 1 SET #05 - DOORS: 1: 3 1 1 1 1 3 SET #06 - DOORS: 1: 3 1 1 1 3 SET #07 -	BYPASS DOOR HARDWARE BYPASS DOOR LOCK TOILET ROOMS 3, 14 HINGES PUSH PLATE PULL PLATE CLOSER KICK PLATE MOP PLATE WALL STOP SILENCERS CONFERENCE ROOM 6 HINGES OFFICE LOCKSET SFIC CORE WALL STOP SILENCERS	BB1168 4 1/2 x 4 1/2 30S 8 x 16 H 33J 4 x 16 5100 190S 10" x 2" LDW 190S 6" x 1" LDW 232W 307D BB1279 4 1/2 x 4 1/2 3450 WTN SFIC 3982 232W 307D	US26D US26D US26D US26D ALM US26D	H) H) H) H) H) H) H) H) H) H) H)
DOORS: 10 1 1 1 SET #05 - 1 DOORS: 1: 3 1 1 1 1 3 SET #06 - 1 DOORS: 1: 3 1 1 1 3 SET #06 - 3 3 1 1 1 3 3 SET #07 - 3 SET #07 - 3 SET #07 - 3 SET #07 - 3	BYPASS DOOR HARDWARE BYPASS DOOR LOCK TOILET ROOMS 3, 14 HINGES PUSH PLATE PULL PLATE CLOSER KICK PLATE MOP PLATE WALL STOP SILENCERS CONFERENCE ROOM 6 HINGES OFFICE LOCKSET SFIC CORE WALL STOP SILENCERS CONFERENCE ROOM TO SMALL MEET 6B HINGES	BB1168 4 1/2 x 4 1/2 30S 8 x 16 H 33J 4 x 16 5100 190S 10" x 2" LDW 190S 6" x 1" LDW 232W 307D BB1279 4 1/2 x 4 1/2 3450 WTN SFIC 3982 232W 307D	US26D	H/ H/ H/ H/ H/ H/ H/ H/ H/ H/ H/ H/ H/ H
DOORS: 10 1 1 1 SET #05 - 1 DOORS: 10 3 1 1 1 1 1 3 SET #06 - 1 DOORS: 10 3 1 1 1 1 3 SET #07 - 0 DOORS: 10	BYPASS DOOR HARDWARE BYPASS DOOR LOCK TOILET ROOMS 3, 14 HINGES PUSH PLATE PULL PLATE CLOSER KICK PLATE MOP PLATE WALL STOP SILENCERS CONFERENCE ROOM 6 HINGES OFFICE LOCKSET SFIC CORE WALL STOP SILENCERS	BB1168 4 1/2 x 4 1/2 30S 8 x 16 H 33J 4 x 16 5100 190S 10" x 2" LDW 190S 6" x 1" LDW 232W 307D BB1279 4 1/2 x 4 1/2 3450 WTN SFIC 3982 232W 307D	US26D US26D US26D US26D ALM US26D	H. H

V-1 MANUFACTURER: VT INDUSTRIES
PRODUCT: FLUSH WOOD VENEER
SPIECES: SELECT WHITE BIRCH
COLOR: RIVERSTONE RI18


					C	PENING	SCHEI	DULE		
				DOOR		FRAME		HARDWARE		OPENING
OPENING NO.	WIDTH	HEIGHT	TYPE	MATERIAL	TYPE	MATERIAL	FINISH	GROUP	REMARKS	NO.
01	3'-0"	7'-0"	FG	WD	1	KDHM	PT-1	#01		01
02	3'-0"	7'-0"	F	WD	1	KDHM	PT-1, PT-3	#02	PT-1 ON NORTH SIDE OF FRAME, PT-4 ON SOUTH SIDE OF FRAME	02
05	3'-0"	7'-0"	F	WD	2	WHM	PT-1	#03		05
06	3'-0"	7'-0"	F	WD	2	WHM	PT-1	#03		06
07	3'-0"	7'-0"	F	WD	2	WHM	PT-1	#03		07
08	3'-0"	7'-0"	F	WD	2	WHM	PT-1	#03		08
10	3'-0"	7'-0"	F	WD	2	WHM	PT-1	#03		10
10B	5'-0"	7'-0"	В	WD			PT-1	#04		10B
11	3'-0"	7'-0"	F	WD	1	KDHM	PT-1	#02		11
13	3'-0"	7'-0"	F	WD	1	KDHM	PT-1	#05		13
14	3'-0"	7'-0"	F	WD	1	KDHM	PT-1	#05		14
16	3'-0"	7'-0"	FG	WD	2	WHM	PT-1, PT-2	#06	PT-1 ON WEST SIDE OF FRAME, PT-2 ON EAST SIDE OF FRAME	16
16B	3'-0"	7'-0"	F	WD	1	KDHM	PT-1	#07		16B
18B	4'-0"	7'-0"	В	WD			PT-1	#04		18B
26	3'-0"	7'-0"	F	WD	2	WHM	PT-1	#03		26
27	3'-0"	6'-8"	G	WD	EXISTING	EXISTING	PT-1	#03	CLEAN AND PAINT EXISTING FRAME	27
28	3'-0"	6'-8"	G	WD	EXISTING	EXISTING	PT-1	#03	CLEAN AND PAINT EXISTING FRAME	28
29	3'-0"	6'-8"	G	WD	EXISTING	EXISTING	PT-1	#03	CLEAN AND PAINT EXISTING FRAME	29
30	3'-0"	6'-8"	G	WD	EXISTING	EXISTING	PT-1	#03	CLEAN AND PAINT EXISTING FRAME	30
31	3'-0"	6'-8"	G	WD	1	KDHM	PT-1	#03		31
W01	8'-0"	4'-0"			W	WHM				W01

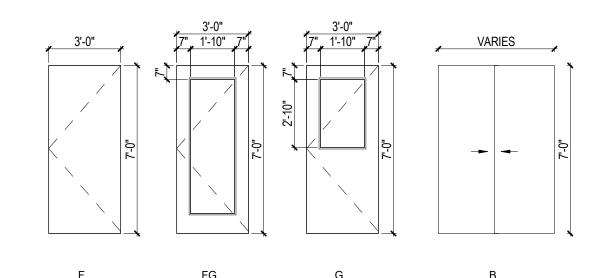




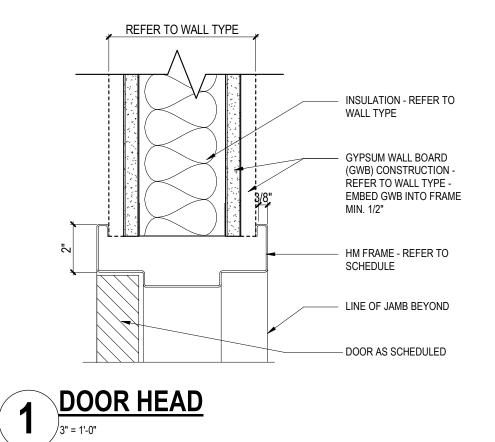



DOOR TYPES1/4" = 1'-0"

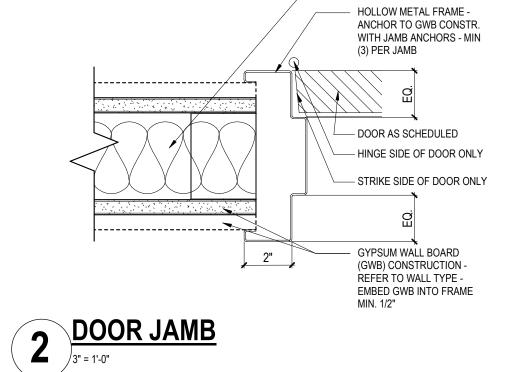

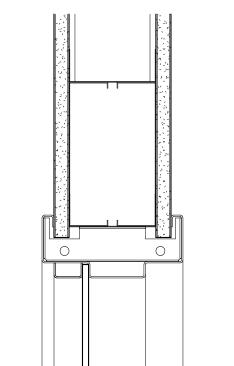

3 WINDOW HEAD 3" = 1'-0"

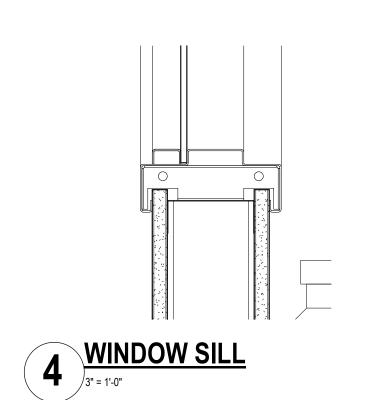

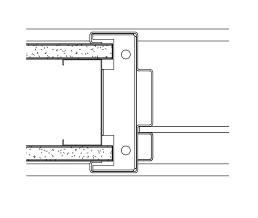

WINDOW JAMB
3" = 1'-0"

INSULATION - REFER TO WALL TYPE

TRAUTMAN ASSOCIATES

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Signature & Seal:



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Client: LACTALIS

AMERICAN GROUP

Project: OFFICE RENOVATIONS AT 2376 SOUTH PARK AVENUE

Project Address: 2376 SOUTH PARK AVENUE BUFFALO, NY 14220

Prawing History: # Date Description


Date: 11/6/25

Project Number: 25042


Sheet Title: DOOR & WINDOW INFORMATION

et Number: A500


/2025 1:08:58 PM

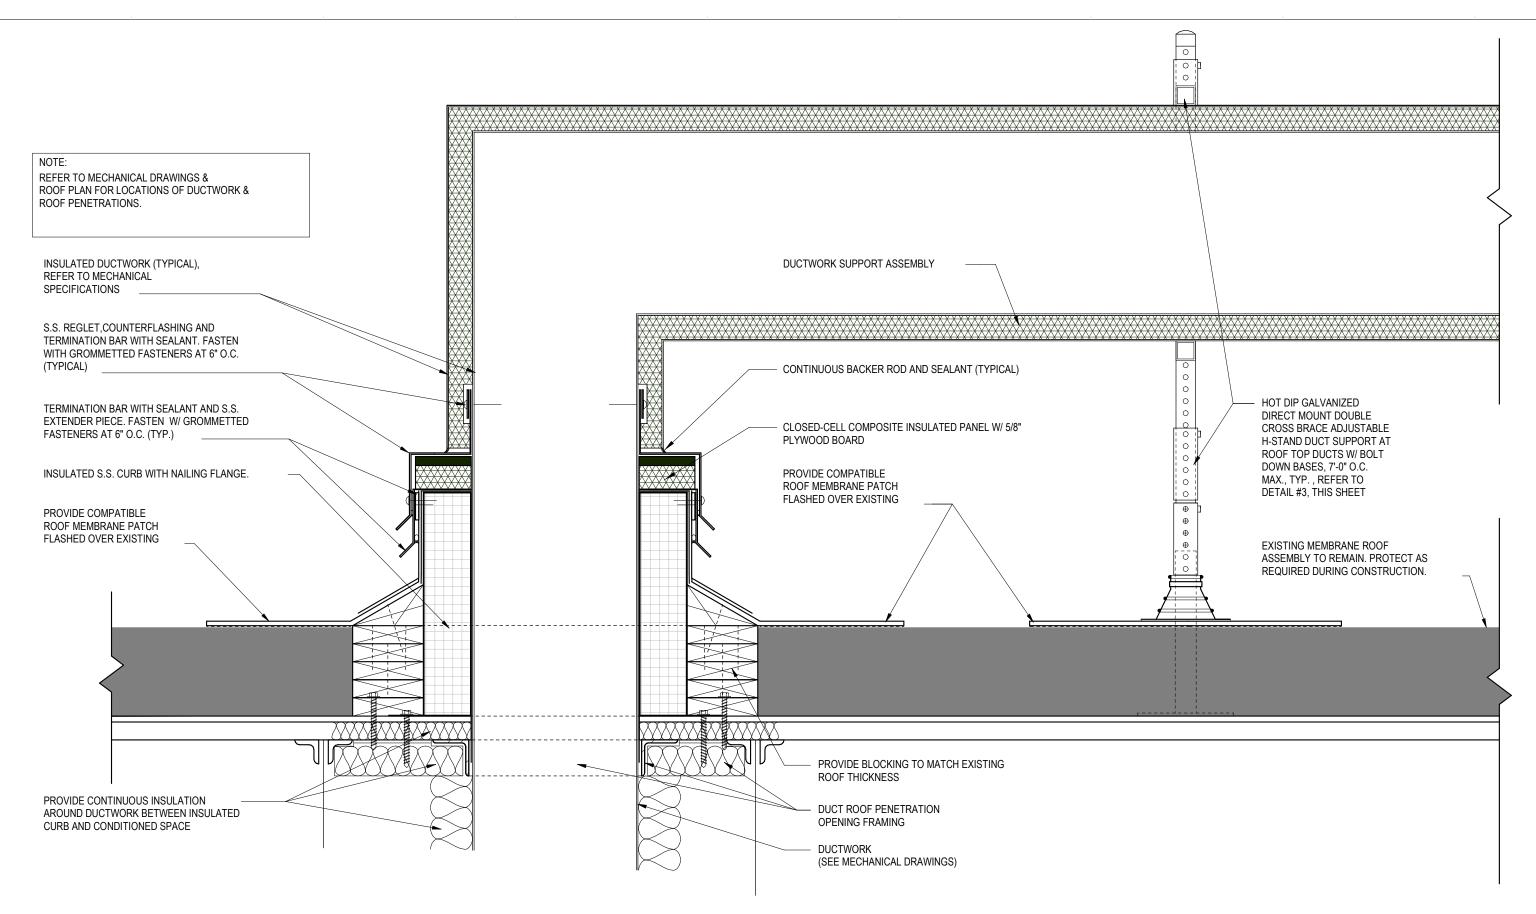

DUCT ROOF PENETRATION DETAIL

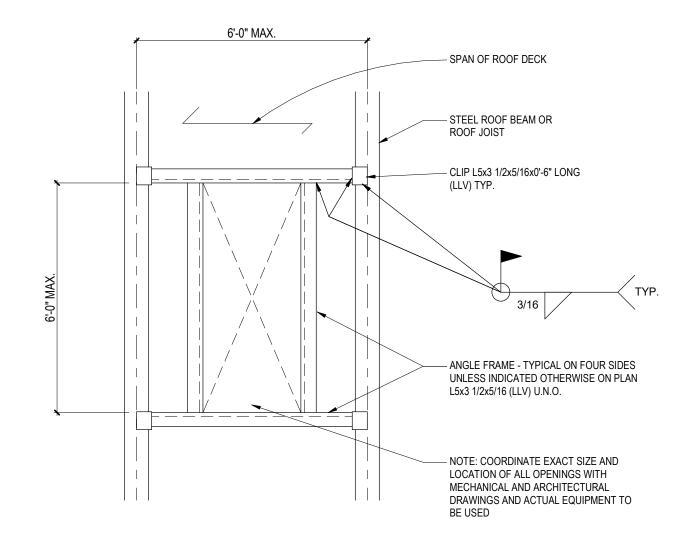

3 TYP. REINFORCEMENT AT ROOF DECK OPENING
NOT TO SCALE

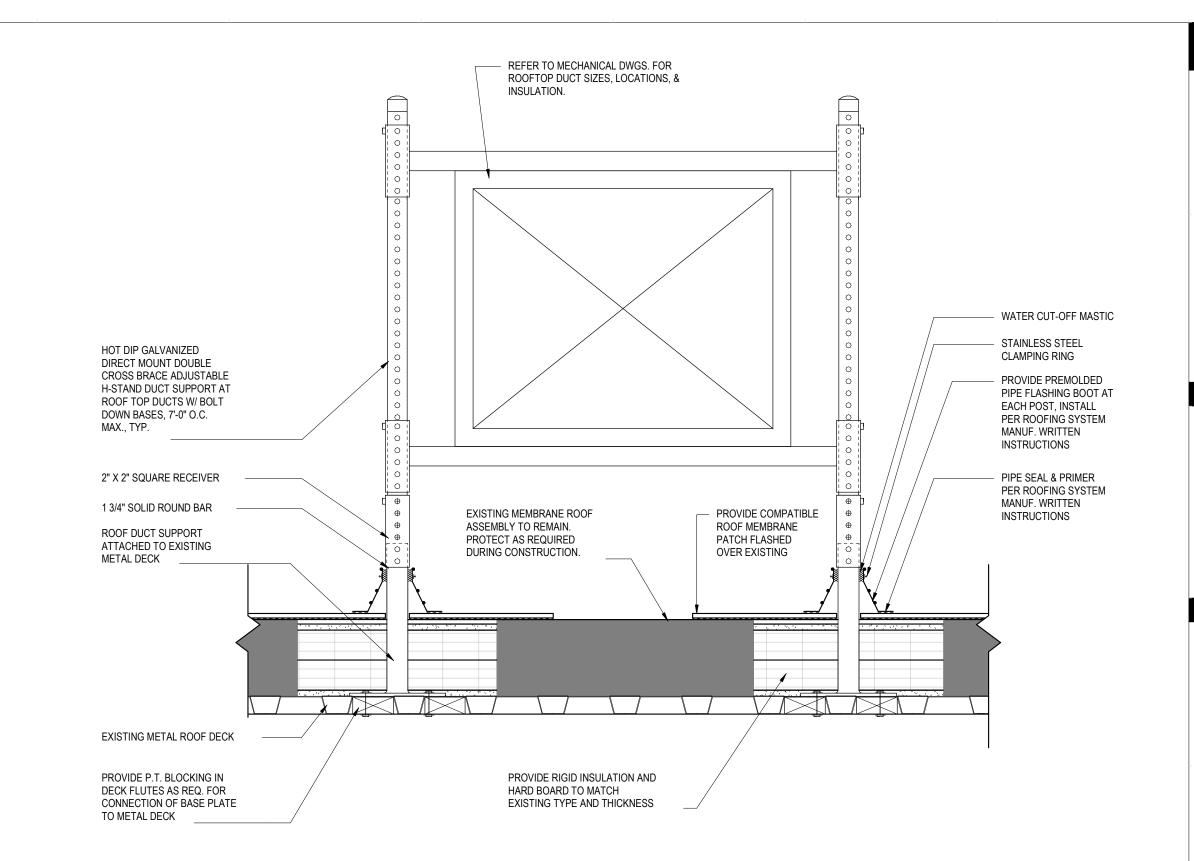

ROOFTOP DUCT DETAIL

1 1/2" = 1'-0"



ARCHITECTS / ENGINEERS

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Signature & Seal:



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Client: LACTALIS AMERICAN GROUP

Project:

RENOVATIONS AT 2376 SOUTH PARK **AVENUE**

Project Address:


2376 SOUTH PARK AVENUE BUFFALO, NY 14220

Date Description

Date: 11/6/25

Project Number: 25042

Sheet Title: ROOF DETAILS

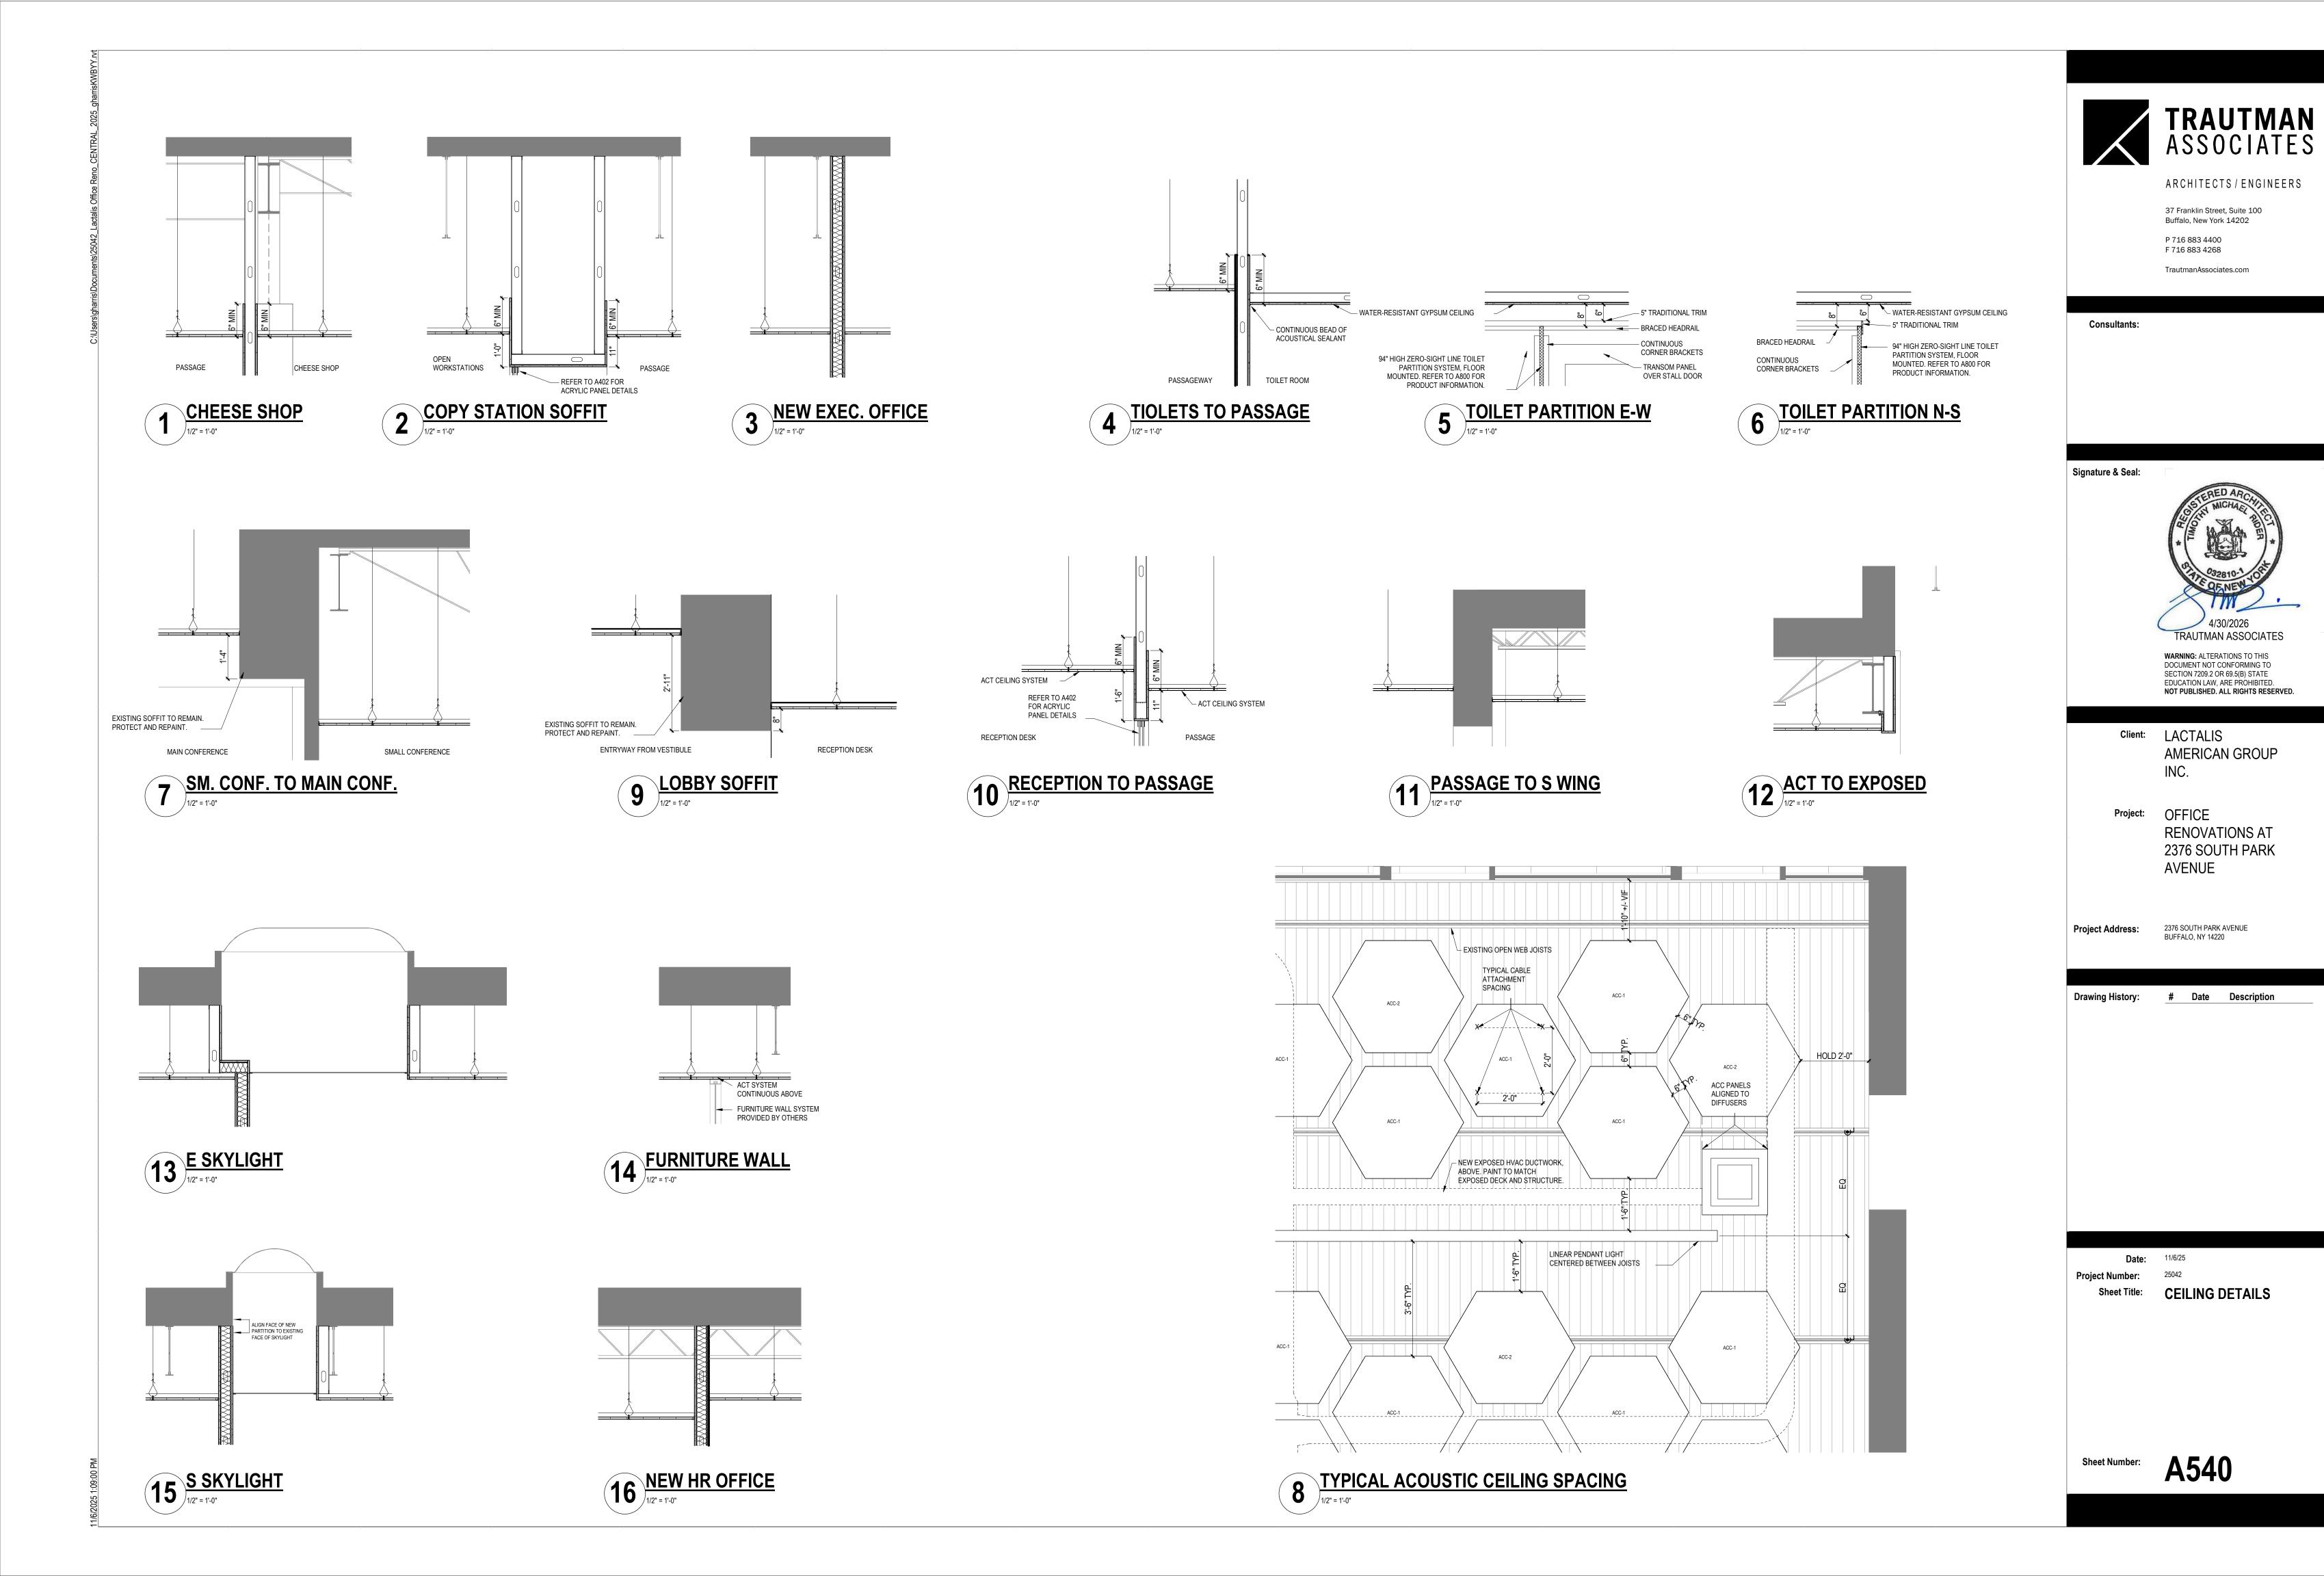

PAINTING NOTES

- A. FOR ALL GWB WALL PAINT LOCATIONS USE SHERWIN WILLIAMS PVA PRIMER AND SEALER. USE SHERWIN WILLIAMS SUPERPAINT INTERIOR ACRYLIC SATIN FOR TOP TWO COATS.
- B. FOR ALL CMU & GLAZED TILE USE SHERWIN WILLIAMS EXTREME BOND PRIMER, BW. USE SHERWIN WILLIAMS SCUFF TUFF INT. WATERBASED ENAMEL, SEMI-GLOSS, S-SERIES FOR TOP TWO COATS.
- C. FOR ALL MECH EQUIPMENT COVERS USE SHERWIN WILLIAMS PRO INDUSTRIAL PRO-CRYL UNIVERSAL PRIMER. USE SHERWIN WILLIAMS PRO INDUSTRIAL DTM ACRYLIC, B- FOR TOP TWO COATS.

GENERAL FINISH NOTES

NOTE: APPLIES TO ALL WORK AREAS.

A. REFER TO FINISH SCHEDULE FOR DESCRIPTION OF MATERIALS. FINAL SELECTION BY OWNER.

B. PATCH AND PREP EXISTING FLOOR TO RECEIVE NEW SCHEDULED FLOOR.

C. PROVIDE LOW PROFILE TRANSITION STRIPS AT CHANGE IN MATERIAL AS REQ'D. REFER TO OWNER FOR FINAL SELECTION.

D. ALL NEW GYPSUM BOARD PARTITIONS TO RECEIVE RESILIENT BASE UNO.

E. PREP, PRIME, AND PAINT ALL NEW GYB.

F. ALL WINDOWS IN PHASES 2-3-4 WORK AREAS TO RECEIVE NEW ROLLER SHADES

FINISH LIST

FLOOR F	FINISHES-	WALL-		CASEWO	ORK-
CPT-1	CARPET TILE 1 MANUFACTURER: MILLIKEN COLLECTION: COLLECTIVE MIND STYLE: ENLIGHTEN COLOR: CURIOUS ELN118-218	PT-1	PAINT 1 MANUFACTURER: SHERWIN WILLIAMS COLOR: DOVER WHITE	PL-1	PLASTIC LAMINATE 1 MANUFACTURER: WILSONART COLOR: FAWN CYPRESS 8202K-16 PRODUCT TYPE: 350 POSTFORMING
	SIZE: 25CM X 1M	PT-2	PAINT 2 MANUFACTURER: SHERWIN WILLIAMS COLOR: PEPPERCORN	PL-2	PLASTIC LAMINATE 2 MANUFACTURER: WILSONART
CPT-2	CARPET TILE 2 MANUFACTURER: MILLIKEN COLLECTION: COLLECTIVE MIND STYLE: ENLIGHTEN	PT-3	PAINT 3 MANUFACTURER: SHERWIN WILLIAMS		COLOR: FROSTY WHITE1573-60 PRODUCT TYPE: 350 POSTFORMING
	COLOR: ENERGY ELN107-218 SIZE: 25CM X 1M	PT-4	COLOR: DEBONAIR PAINT 4	PL-3	PLASTIC LAMINATE 3 MANUFACTURER: WILSONART COLOR: BLACK 1595-60 PRODUCT TYPE: 350 POSTFORMING
CPT-3	CAREPT TILE 3 MANUFACTURER: MILLIKEN		MANUFACTURER: SHERWIN WILLIAMS COLOR: SALTY DOG	SS-1	SOLID SURFACE 1
	COLLECTION: COLLECTIVE MIND STYLE: UNION COLOR: ENERGY UNN107-218 SIZE: 25CM X 1M	T-2	TILE 2 MANUFACTURER: DALTILE COLLECTION: MYTHOLOGY		MANUFACTURER: CORIAN COLOR: ARCTIC ICE
CPT-4	CAREPT TILE 4 MANUFACTURER: MILLIKEN		STYLE: RECTANGLE UNDULATED GLOSSY COLOR: TITAN MY96 SIZE: 4" X 12" INSTALL: 3" OFFSET GROUT: LATICRETE STERLING SILVER 78	SS-2	SOLID SURFACE 2 MANUFACTURER: CORIAN COLOR: CARBON CONCRETE
	COLLECTION: COLLECTIVE MIND STYLE: TRANSCCEND COLOR: ENERGY TRA107-218 SIZE: 25CM X 1M	T-3	TILE 3	SS-3	SOLID SURFACE 3 MANUFACTURER: CORIAN COLOR: EXCAVAGE
			MANUFACTURER: DALTILE COLLECTION: COLOR WHEEL	ACCESS	ORIES-
VT-1	LUXURY VINYL TILE 1 MANUFACTURER: MILLIKEN COLLECTION: FORTIFIED FOUNDATIONS 5.0MM STYLE: POLISHED CONCRETE COLOR: REFLECTIVE POL180 SIZE: 36" X 36"		STYLE: LINEAR GLOSSY COLOR: BISCUIT K175 SIZE: 4" X 12" INSTALL: 3" OFFSET GROUT: LATICRETE STERLING SILVER 78	WP-1	WALL PANEL 1 MANUFACTURER: LUMICOR COLLECTION: TEXTILE COLOR: WHITE MEANDER GAUGE: 1/2" THICKNESS
VT-2	LUVUDV VINVI, TILE O	CEILING-			
.V 1-Z	LUXURY VINYL TILE 2 MANUFACTURER: MILLIKEN COLLECTION: FORTIFIED FOUNDATIONS 5.0MM STYLE: TERRAZZO COLOR: PEARL TRZ213 SIZE: 18" X 36"	ACT-1	ACOUSTIC CEILING TILE 1 MANUFACTURER: ARMSTRONG STYLE: ULTIMA TEMPLOK EDGE: SQUARE LAY-IN SIZE: 24" X 24"	WP-2	WALL PANEL 2 MANUFACTURER: LUMICOR COLLECTION: LUMINOUS COLOR: LAGO GAUGE: 1/2" THICKNESS
.VT-3	LUXURY VINYL TILE 3 MANUFACTURER: MILLIKEN COLLECTION: FORTIFIED FOUNDATIONS 5.0MM STYLE: SIBERIAN LARCH COLOR: COVE SIB211	PT-5	PAINT 5 MANUFACTURER: SHERWIN WILLIAMS COLOR: CEILING BRIGHT WHITE	TR-1	TRANSITION 1 MANUFACTURER: SCHLUTER SYSTEMS STYLE: DILEX-AHK COVE BASE FINISH: ALUM BRUSH CHROME SIZE: 1/2"
	SIZE: 7" X 48"	PT-6	PAINT 6 MANUFACTURER: SHERWIN WILLIAMS COLOR: BLACK OF NIGHT	WF-1	WINDOW FILM 1
ī-1	TILE 1 MANUFACTURER: DALTILE COLLECTION: INDOTERRA STYLE: CONCRETE	PT-7	PAINT 7 ALTERNATIVE MANUFACTURER: SHERWIN WILLIAMS		MANUFACTURER: 3M PRODUCT: FASARA OPAQUE BLACK SH2BKOP LOCATION: GLASS OF VESTIBULE ON CONF ROOM SOUTH WALL
	COLOR: TRAIL IN44 MATTE SIZE: 12" X 24"		COLOR: ARGOS	EB-1	EDGEBAND 1 MANUFACTURER: WILSONART
SE FINIS	SHES- RUBBER BASE 1	ACC-1	ACOUSTIC CEILING CLOUD 1 MANUFACTURER: ACOUFELT COLLECTION: ESSENTIALS COLOR: TALC TALC TAUS		PRODUCT: EDGEBAND COLOR: FROSTY WHITE 1573-60 SIZE: 15/16 X 0.018
-1	MANUFACTURER: ROPPE COLOR: 100 BLACK		SIZE: 48" X 41.57"		
	STYLE: PINNACLE STANDARD TOE SIZE: 6"	ACC-2	ACOUSTIC CEILING CLOUD 2 MANUFACTURER: ACOUFELT COLLECTION: ESSENTIALS COLOR: SHALE SH03		

				ROOI	M FINIS	SH SCHE	DULE
ROOM#	ROOM NAME	CEILING FINISH	AREA	BASE FINISH	FLOOR FINISH	WALL FINISH	COMMENTS
1	CHEESE SHOP	ACT-1	423 SF	RB-1	LVT-2	PT-1,PT-3	PT-3 ON SOUTH WALL
2	SHOP STORAGE	ACT-1	78 SF	RB-1	LVT-2	PT-1	
3	MAIL ROOM	ACT-1	121 SF	RB-1	LVT-3	PT-1, PT-2	PT-2 ON EAST WALL
4	OPEN WORKSTATIONS	ACT-1	1,335 SF	RB-1	CPT-2	PT1, PT-4	SEE PLANS AND ELEVATIONS FOR FINISH LOCATIONS
5	EXEC. OFFICE	ACT-1	190 SF	RB-1	CPT-3	PT-1	
6	EXEC. OFFICE	ACT-1	150 SF	RB-1	CPT-3	PT-1	
7	EXEC. OFFICE	ACT-1	257 SF	RB-1	CPT-3	PT-1	
8	EXEC. OFFICE	ACT-1	173 SF	RB-1	CPT-3	PT-1	
9	WATER METER	GYP	15 SF	RB-1	CONC.	PT-1	
10	SM. CONF. ROOM	ACT-1	136 SF	RB-1	CPT-3	PT-1	PT-3 ON EAST WALL
10B	CLOSET	ACT-1	13 SF	RB-1	CPT-3	PT-1	
11	MAINT. ROOM	ACT-1	176 SF	RB-1	LVT-3	PT-1	
12	PASSAGEWAY	ACT-1	615 SF	RB-1	CPT1	PT-1, PT-4	NEW ACT. NEW RUBBER BASES. NEW COAT OF PAINT ON EACH WALL PT-1. ALL SOFFITS PT-5. END CAPS AT NORTH END OF PASSAGEWAY PT-4
13	W. TOILETS	GYP, P-5	94 SF		T-1	T-2, T-3	SEE PLANS AND ELEVATIONS FOR FINISH LOCATIONS
14	M. TOILETS	GYP, P-5	129 SF		T-1	T-2, T-3	SEE PLANS AND ELEVATIONS FOR FINISH LOCATIONS
15	RECEPTION	ACT-1, GYP-1,PT-5	341 SF	RB-1	LVT-1	PT-1, PT-3	SEE PLANS AND ELEVATIONS FOR FINISH LOCATIONS PT-5 ON ALL SOFFITS
16	MAIN CONFERENCE ROOM	ACT-1, GYP, PT-5	482 SF	RB-1	CPT-4	PT-1, PT-2	PT-2 ON EAST WALLS PT-5 ON ALL SOFFITS
17	VESTIBULE	ACT-1	52 SF	RB-1	LVT-1	PT-1	
18	OPEN WORKSTATIONS	ACT-1	1,874 SF	RB-1	CPT-1	PT-1, PT-4	PT-4 ON EAST WALL/SEE PLANS AND ELEVATIONS FOR FINISH LOCATIONS
18B	CLOSET	ACT-1	15 SF	RB-1	CPT-1	PT-1	
19	SM. MEETING ROOM	ACT-1	114 SF	RB-1	CPT-2	PT-1, PT-3	PT-3 ON SOUTH WALL
20	OFFICE	ACT-1	89 SF	RB-1	CPT-2	PT-1, PT-3	PT-3 ON NORTH WALL
22	OFFICE	ACT-1	92 SF	RB-1	CPT-2	PT-1	
23	OFFICE	ACT-1	92 SF	RB-1	CPT-2	PT-1	
24	OFFICE	ACT-1	92 SF	RB-1	CPT-2	PT-1	
25	OFFICE	ACT-1	92 SF	RB-1	CPT-2	PT-1	
26	EXEC. OFFICE	ACT-1	182 SF	RB-1	CPT-3	PT-1,PT-2	PT-2 ON EAST WALL
27	OFFICE	ACT-1	121 SF	RB-1	CPT-3	PT-1	
28	OFFICE	ACT-1	113 SF	RB-1	CPT-3	PT-1	
29	OFFICE	ACT-1	108 SF	RB-1	CPT-3	PT-1	
30	OFFICE	ACT-1	105 SF	RB-1	CPT-3	PT-1	
31	OFFICE	ACT-1	105 SF	RB-1	CPT-3	PT-1	
33	OPEN WORKSTATIONS		4,008 SF				



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Consultants:

Signature & Seal:



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Client: LACTALIS AMERICAN GROUP

Project:

RENOVATIONS AT 2376 SOUTH PARK **AVENUE**

Project Address: 2376 SOUTH PARK AVENUE BUFFALO, NY 14220

Drawing History: # Date Description

Project Number: 25042

Sheet Title: FINISH

INFORMATION



TRAUTMAN ASSOCIATES

ARCHITECTS / ENGINEERS

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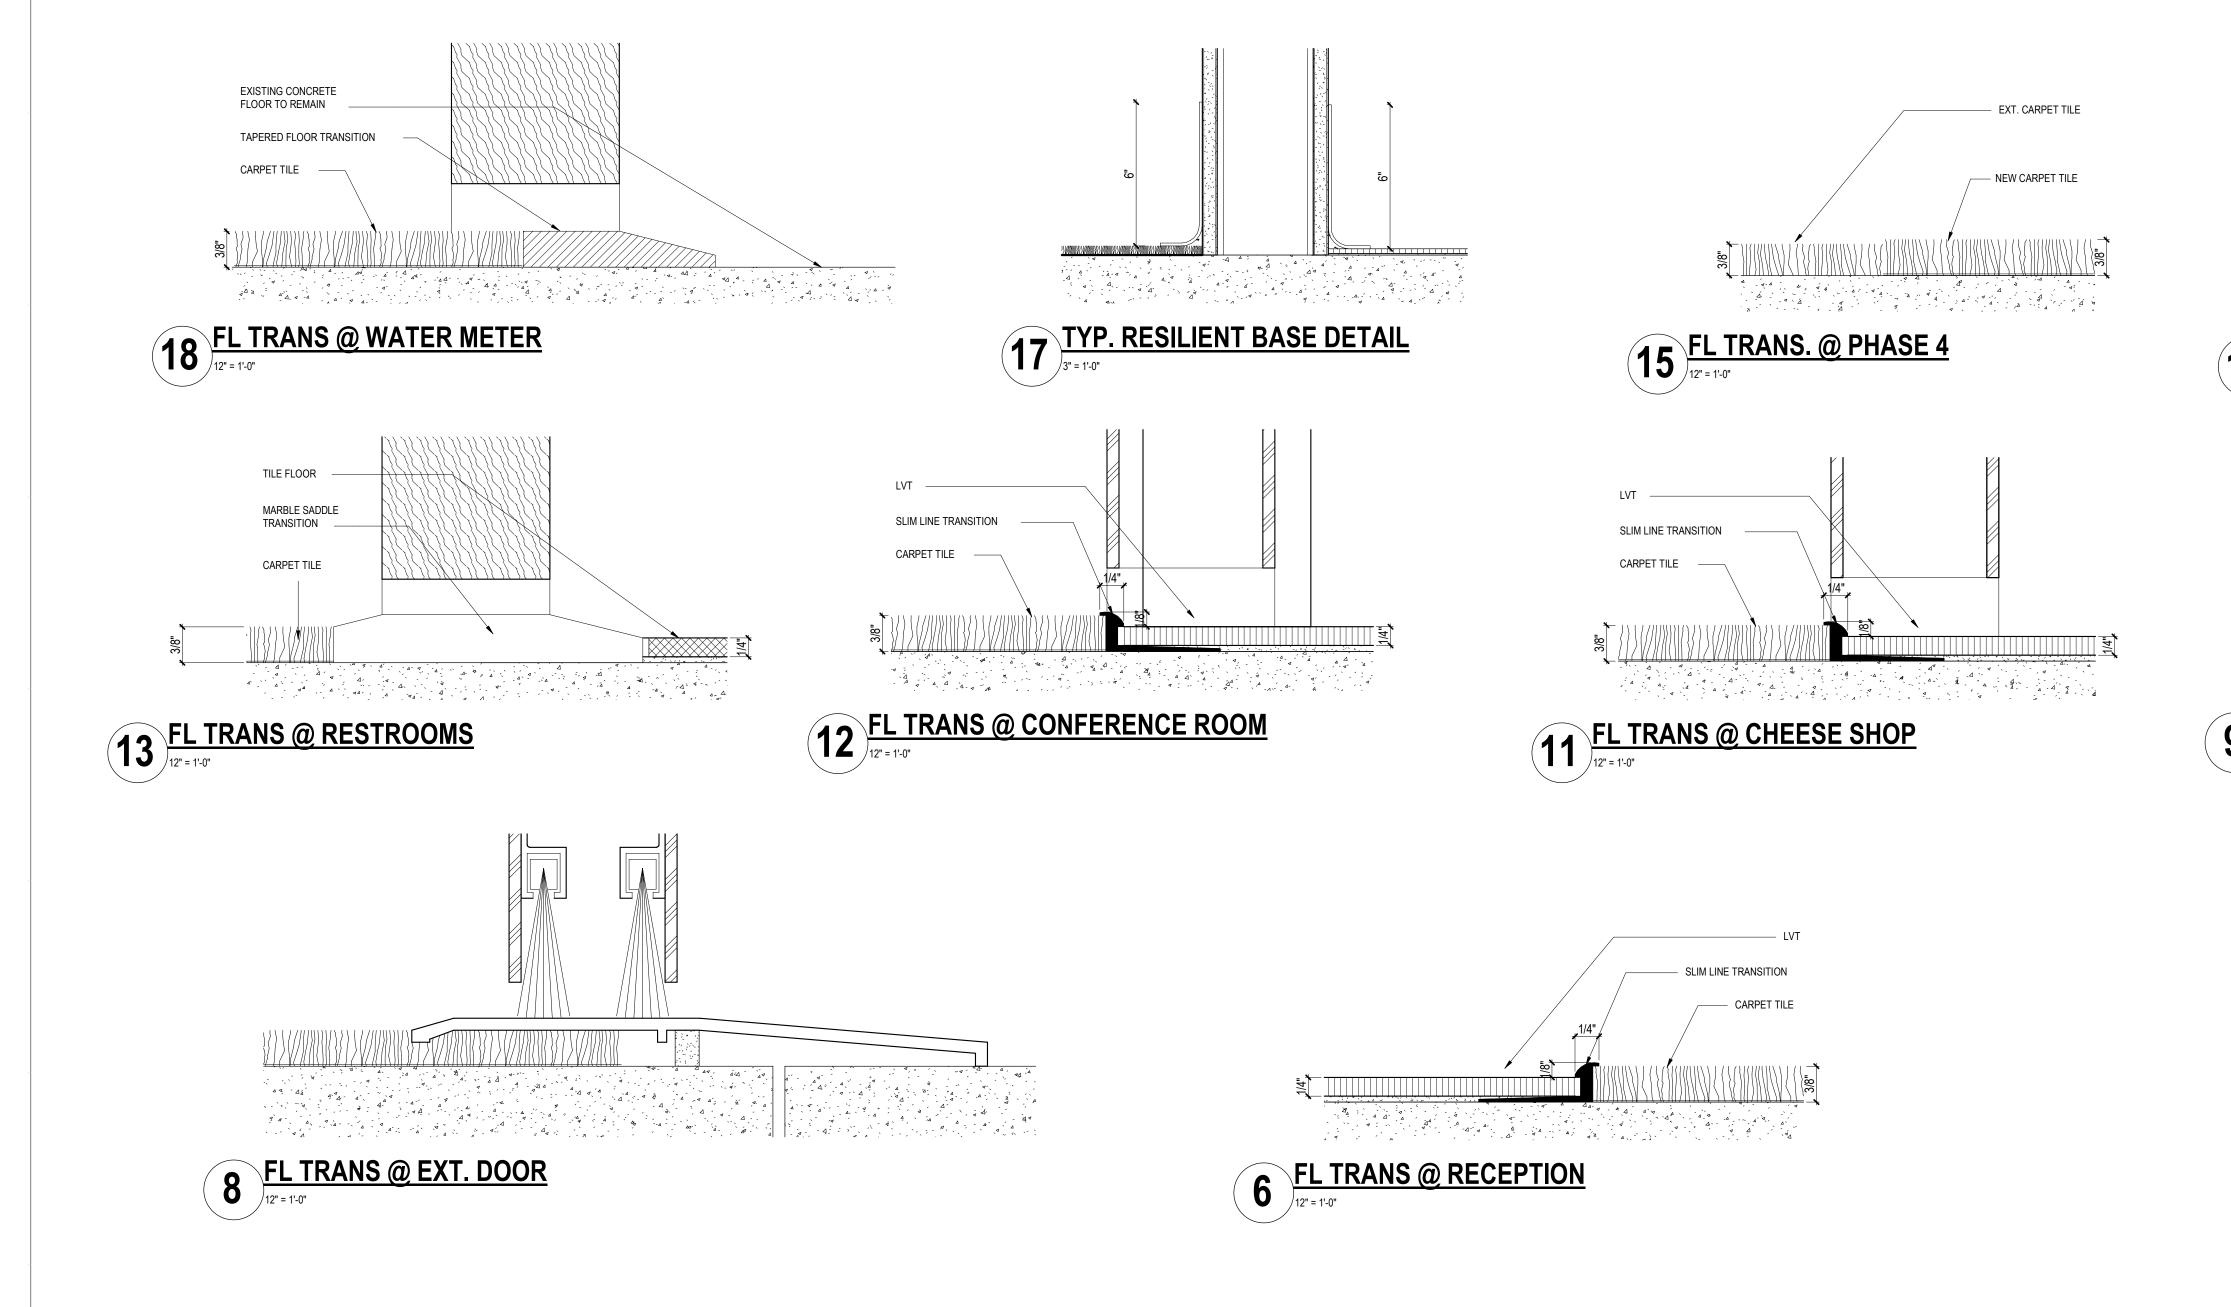
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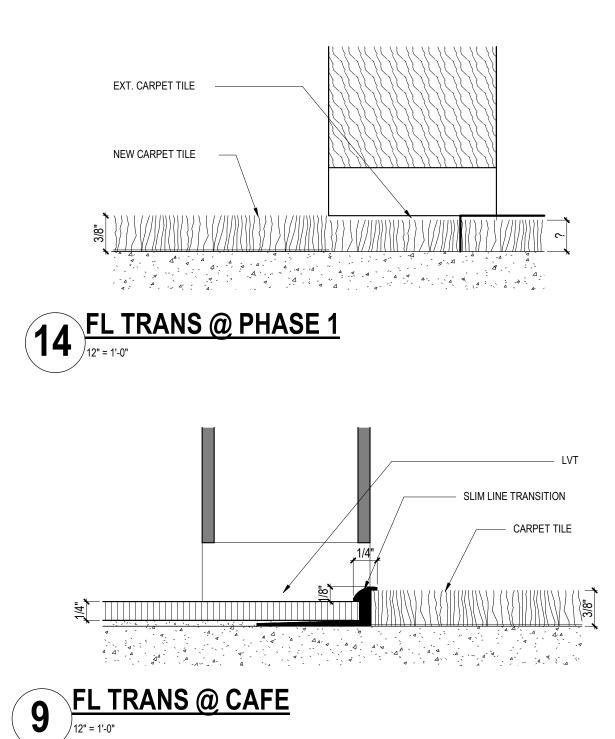
AMERICAN GROUP


RENOVATIONS AT 2376 SOUTH PARK AVENUE

Date Description

FINISH PLAN





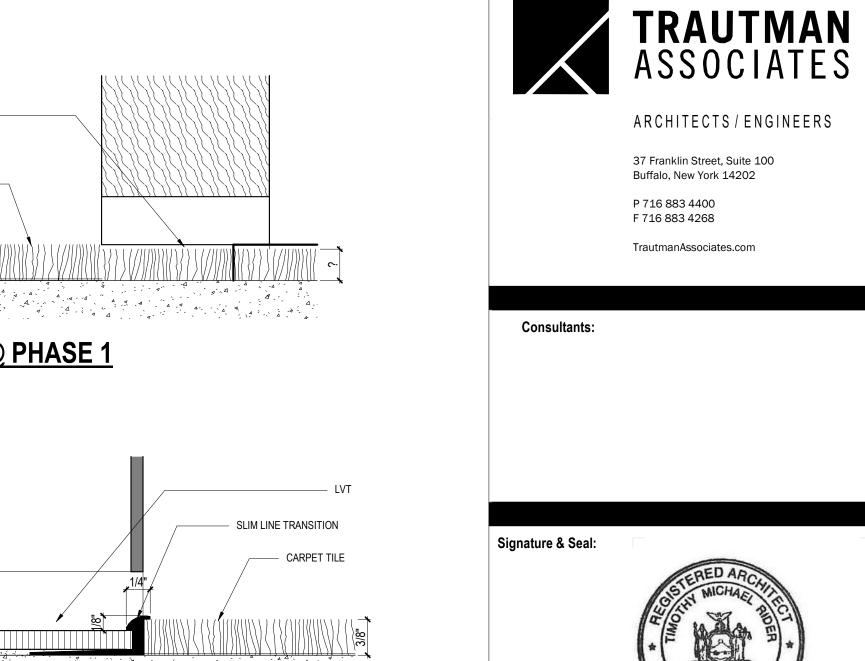

Client: LACTALIS AMERICAN GROUP INC.

4/30/2026 TRAUTMAN ASSOCIATES

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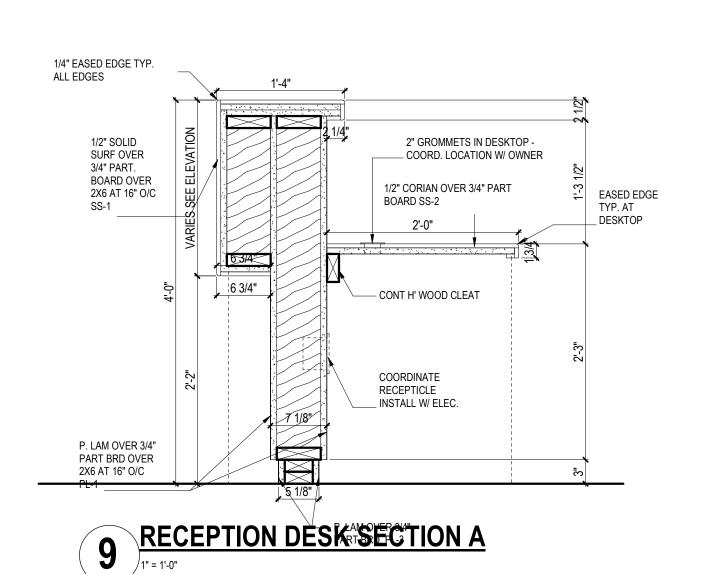
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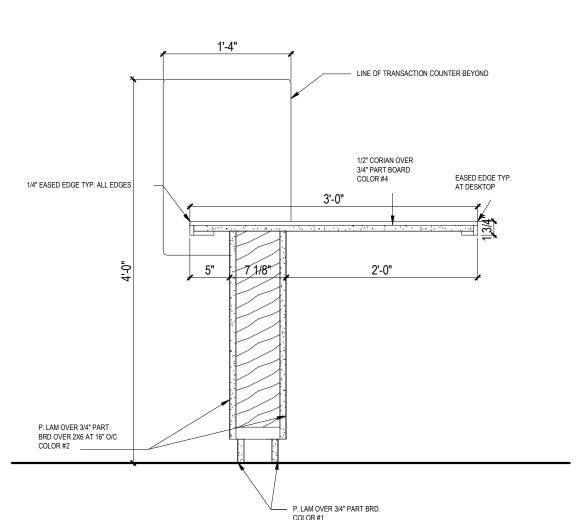
2376 SOUTH PARK AVENUE Project Address: BUFFALO, NY 14220

Date Description Drawing History:


Date: 11/6/25 Project Number: 25042 Sheet Title: FINISH DETAILS


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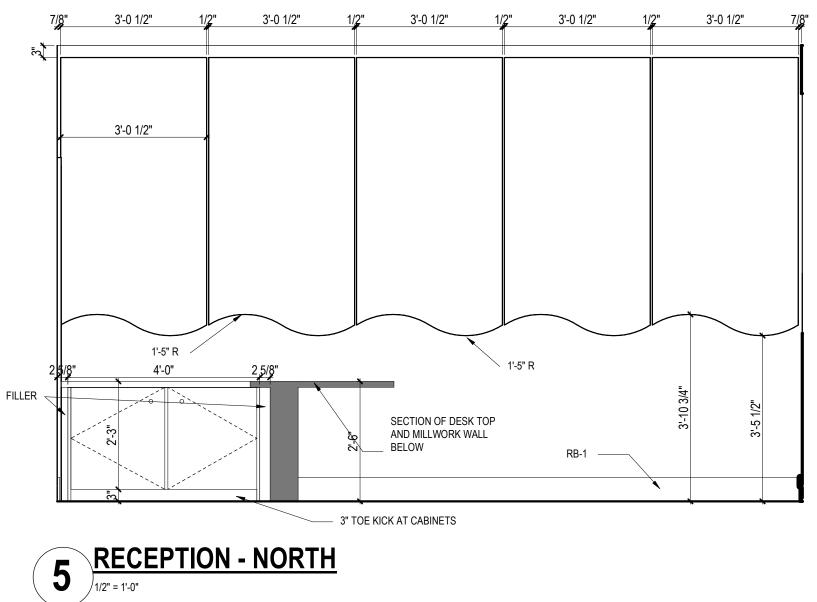





10 RECEPTION DESK SECTION B




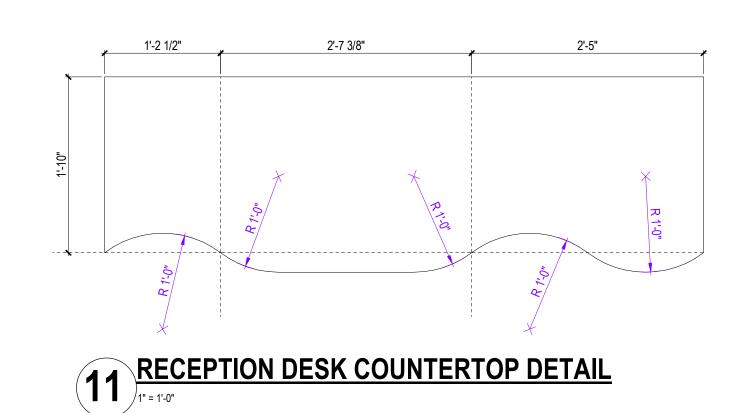


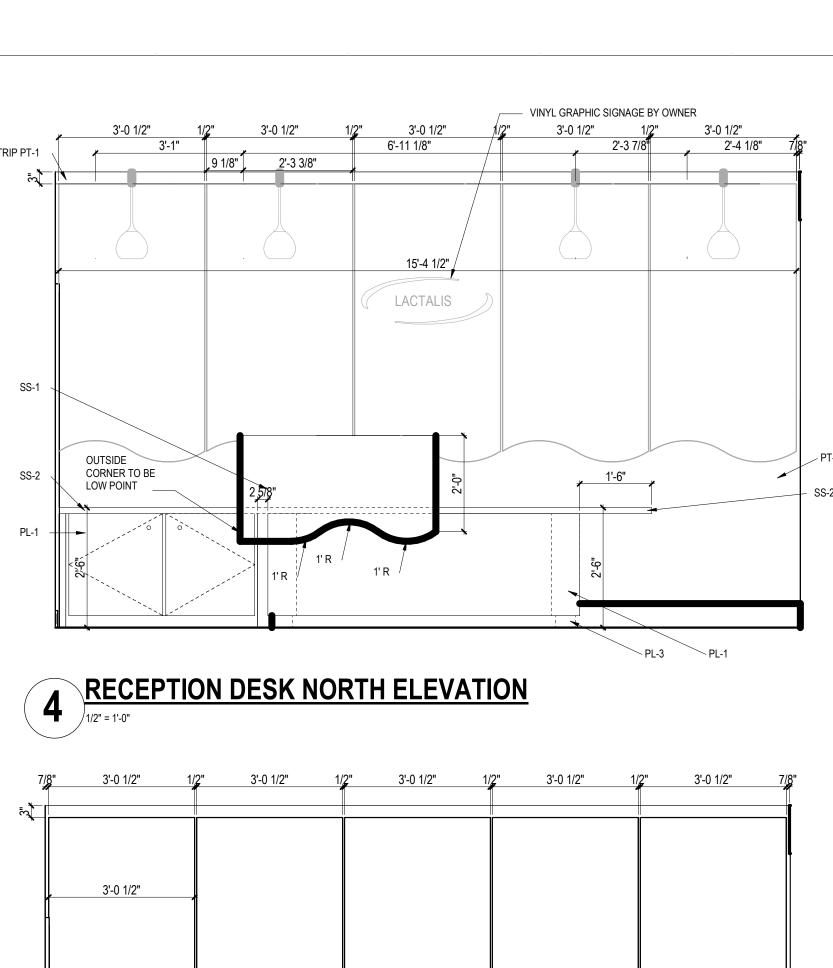


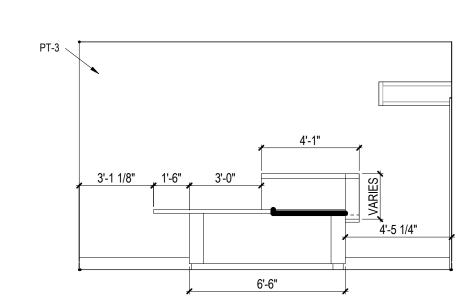



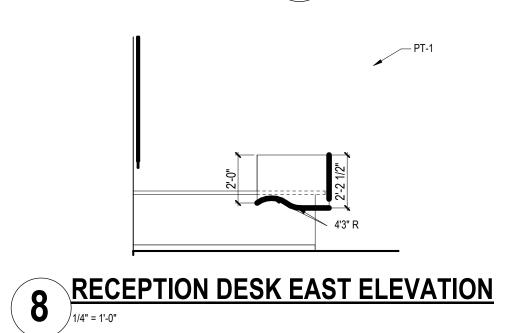


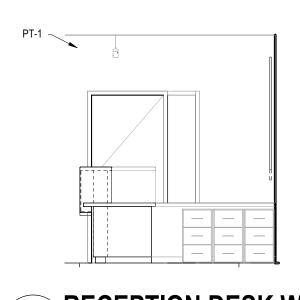

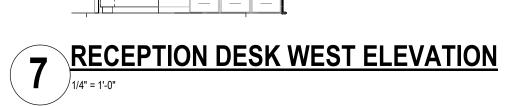

2 A803

REPAIR EXIST GWB FLOOR TO CEIL. _

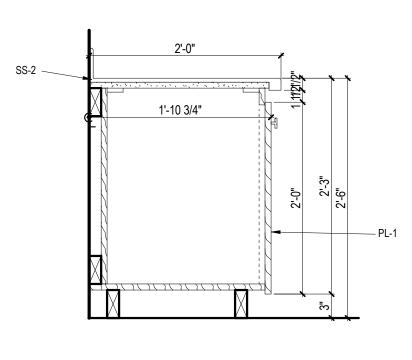

REFER TO OTHER DETAILS

7" WALL BELOW

A803

13" R RADIUSED P. LAM RECEP DESK

9 20" R RADIUSED SOLID SURF TRANSACTION COUNTER


1'-10"

DESK 30" AFF

BACK COUNTER 28

1 CUSTOM RECEPTION DESK CALLOUT



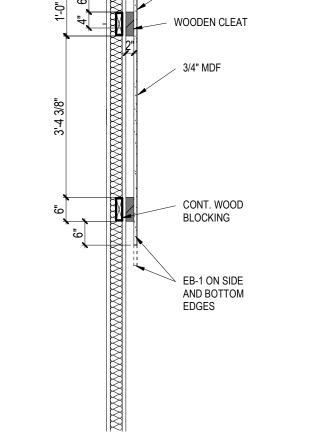

PL-2 ALL EXPOSED EDGES

Section 101/2" = 1'-0"



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Consultants:



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Client: LACTALIS AMERICAN GROUP

> RENOVATIONS AT 2376 SOUTH PARK AVENUE

2376 SOUTH PARK AVENUE BUFFALO, NY 14220

Date Description

Date: Project Number:

11/6/25

RECEPTION DESK INFORMATION

A803

P. LAM OVER 3/4" PART BRD. COLOR #1





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Client: LACTALIS
AMERICAN GROUP

INC.

Project: OFFICE

RENOVATIONS AT 2376 SOUTH PARK AVENUE

Project Address:

ress: 2376 SOUTH PARK AVENUE BUFFALO, NY 14220

Drawing History

Date Description
A 00 XXX 0000 DESCRIPTION

Date: Project Number:

Date: 11/6/25

sheet Title: PROPOSED
FURNITURE PLAN

Sheet Numbe

A851

ABBREVIATIONS:

AFF ABOVE FINISHED FLOOR AMPERE AIC ASYMMETRIC INTERRUPTING CAPACITY AL ALUMINUM ATS AUTOMATIC TRANSFER SWITCH AWG AMERICAN WIRE GAUGE

C CONDUIT CLG CEILING CKT CIRCUIT CU COPPER

BKR BREAKER

DIA DIAMETER DN DOWN ELECTRICAL CONTRACTOR EC

EXHAUST FAN EMER EMERGENCY ETR EXISTING TO REMAIN

FA FIRE ALARM FAAP FIRE ALARM ANNUNCIATOR PANEL FACP FIRE ALARM CONTROL PANEL FTL FEED THRU LUGS

GFCI GROUND FAULT CIRCUIT INTERRUPTER GFI GROUND FAULT INTERRUPTER GND GROUND

HP HORSEPOWER K MULTIPLE OF 1000 JB JUNCTION BOX

LTG LIGHTING LV LOW VOLTAGE

MAX MAXIMUM MCB MAIN CIRCUIT BREAKER MDP MAIN DISTRIBUTION PANEL MIN MINIMUM MLO MAIN LUG ONLY MTG HT MOUNTING HEIGHT

NL NIGHT LIGHT NEC NATIONAL ELECTRICAL CODE NON-FUSED NTS NOT TO SCALE

OC OVER-COUNTER - EC TO VERIFY HEIGHT OF COUNTER TOP OCP OVERCURRENT PROTECTION

POLE PH PNL PHASE PANEL PRI PRIMARY

TVSS TRANSIENT VOLTAGE SURGE SUPPRESSION

UC UNDER-CABINET

VOLT VIF VERIFY IN FIELD

WATT WG WIREGUARD WP WEATHERPROOF

XFMR TRANSFORMER

	DEVICES
SYMBOL	DESCRIPTION
OS DT	WALL - SWITCH OCCUPANCY SENSOR SUBSCRIPTS DENOTE TYPE: PIR - PASSIVE INFRARED US - ULTRASONIC D - 0-10V DIMMER DT - DUAL-TECHNOLOGY
©S) ^{US}	CEILING MOUNTED OCCUPANCY SENSOR SUBSCRIPTS DENOTE TYPE: PIR - PASSIVE INFRARED US - ULTRASONIC USC - ULTRASONIC CORRIDOR COVERAGE DT - DUAL-TECHNOLOGY
SP	SWITCH PACK FOR OCCUPANCY SENSORS
RC	LIGHTING ROOM CONTROLLER
(ALS)	AMBIENT LIGHT SENSOR
PC	PHOTOCELL
(}	TOGGLE SWITCH SUBSCRIPTS DENOTE TYPE: 2 - TWO POLE SWITCH 3 - THREE WAY SWITCH 4 - FOUR WAY SWITCH LV - LOW VOLTAGE SWITCH K - KEY OPERATED SWITCH KP - DIMMING KEYPAD/SCENE CONTROLLER T - MOTOR-RATED SWITCH D - DIMMER CONTROL WP - WEATHER PROOF ROMAN NUMERALS INDICATE GANGED SWITCHES LETTERS (a,b,c) INDICATE SWITCH LEGS
Φ	DUPLEX RECEPTACLE - 125V, 20A SUBSCRIPTS DENOTE TYPE: CH - INTEGRAL USB CHARGER GFI - GROUND FAULT CIRCUIT INTERRUPTER GFIP - CONNECTED TO GFCI CIRCUIT BREAKER OC - OVER COUNTER TVSS - TRANSIENT VOLTAGE SURGE SUPPRESOR UC - UNDER COUNTER

WP - WEATHER PROOF WHILE-IN-USE

EQUIPMENT CONNECTION - DIRECT CONNECTION OR MATCH CORD AND

EQUIPMENT RECEPTACLE - REFER TO NOTE FOR CONFIGURATION

RECESSED FLOOR BOX WITH POWER AND LOW VOLTAGE COMPARTMENTS

DATA OUTLET WITH (1) RJ-45 JACK IN 4" SQUARE OUTLET BOX WITH 3/4" CONDUIT STUBBED TO ABOVE ACCESSIBLE CEILING. PROVIDE (1) CAT-6 CABLE

COMBINATION POWER/LOW-VOLTAGE BOX FOR WALL-MOUNTED TV WITH (1) DUPLEX TVSS RECEPTACLE, (1) CAT-6 CABLE AND (1) RG-6 CABLE TO NEAREST DATA ROOM. REFER TO DRAWING NOTES FOR ALTERNATE REQUIREMENTS

WR - WEATHER-RESISTANT TR - TAMPER RESISTANT

SPLIT-WIRED DUPLEX RECEPTACLE (HALF-SWITCHED)

SURFACE-MOUNTED DUPLEX RECEPTACLE

##AS - AMPERE RATING OF SWITCH

##AF - AMPERE RATING OF FUSE

TO PATCH PANEL IN SERVER ROOM.

CEILING-MOUNTED RECEPTACLE

DOUBLE DUPLEX RECEPTACLE

CAP AS REQUIRED

##AS ##AF

DISCONNECT SWITCH

NF - NON-FUSED

MOTOR CONNECTION

WAP WIRELESS ACCESS POINT PROVISION.


JUNCTION BOX

TIME SWITCH

SUBSCRIPTS DENOTE RATINGS:

	FIRE ALARM
SYMBOL	DESCRIPTION
F	MANUAL PULLSTATION PROVISION
FX	FIRE ALARM NOTIFICATION DEVICE PROVISION
	SECURITY / ACCESS CONTROL
CAMBOI	DECODIDITION

,	SECURITY / ACCESS CONTROL
SYMBOL	DESCRIPTION
CR	RACEWAY/BOX PROVISION FOR CARD/PROXIMITY READER
ES	RACEWAY/BOX PROVISION FOR ELECTRIC LATCH/STRIKE
DC	RACEWAY/BOX PROVISION FOR DOOR CONTACT
РВ	RACEWAY/BOX PROVISION FOR PUSHBUTTON
RTE	RACEWAY/BOX PROVISION FOR REQUEST TO EXIT SENSOR
	SECURITY CAMERA PROVISION

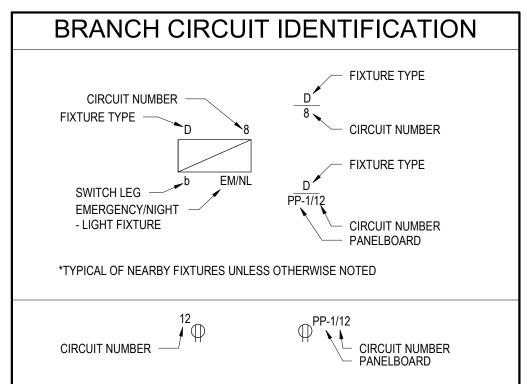

	GENERA	L
DEVICES	DESCRIPTION	
	HEAVY LINEWEIGHT DENOTES NEW DEVIC	E, EQUIPMENT, OR
	LIGHT LINEWEIGHT DENOTES EXISTING DE CONNECTION TO REMAIN	VICE, EQUIPMENT, OR
	BROKEN LIGHT LINEWEIGHT DENOTES EX CONNECTION TO BE REMOVED	ISTING DEVICE, EQUIPMENT, OR
П	ROMAN NUMERALS INDICATE NUMBER OF	DEVICES
	MOUNTING HE	IGHTS
DEVICES		MOUNTING HEIGHT
RECEPTA	ACLES	18" AFF
EXTERIO	R RECEPTACLES	24" AFF
SWITCHE	ES .	44" AFF
DATA/TEI	LCOM OUTLETS	18" AFF
FIRE ALA	RM MANUAL PULLSTATIONS	44" AFF
RESIDEN	TIAL LOAD CENTERS	TOP AT 60" AFF
EIDE AI A	RM VISUAL NOTIFICATION DEVICE	ENTIRE LENS BTW 80"-96" AFF

		MECHAN	ICAL I	EQU	IPM	IENT (CON	NECTIO	N SC	HEDULE	
EQUIP. NO.	EQUIPMENT DESCRIPTION	LOCATION	VOLTAGE	PHASE	AMPS	WIRE SIZE	GND SIZE	CONDUIT SIZE	PANEL	CIRCUIT BREAKER	REMARKS
UH-1	CABINET UNIT HEATER	VESTIBULE	120	1	0.7	#12 AWG	#12 AWG	3/4"	LP-2.3	1P15A	PROVIDE 1P15A TOGGLE DISCONNECT
UH-2	CABINET UNIT HEATER	OPEN WORKSTATIONS 18	120	1	0.7	#12 AWG	#12 AWG	3/4"	LP-X	1P15A	PROVIDE 1P15A TOGGLE DISCONNECT
UH-3	CABINET UNIT HEATER	PASSAGEWAY	120	1	0.7	#12 AWG	#12 AWG	3/4"	LP-2.3	1P15A	PROVIDE 1P15A TOGGLE DISCONNECT
VAV-1	CABINET UNIT HEATER	EXEC. OFFICE 5	120	1	1	#12 AWG	#12 AWG	3/4"	LP-2.3	1P15A	PROVIDE 1P15A TOGGLE DISCONNECT
VAV-2	CABINET UNIT HEATER	EXEC. OFFICE 6	120	1	1	#12 AWG	#12 AWG	3/4"	LP-2.3	1P15A	PROVIDE 1P15A TOGGLE DISCONNECT
VAV-3	CABINET UNIT HEATER	EXEC. OFFICE 7	120	1	1	#12 AWG	#12 AWG	3/4"	LP-2.3	1P15A	PROVIDE 1P15A TOGGLE DISCONNECT
VAV-4	CABINET UNIT HEATER	EXEC. OFFICE 8	120	1	1	#12 AWG	#12 AWG	3/4"	LP-2.3	1P15A	PROVIDE 1P15A TOGGLE DISCONNECT
VAV-5	CABINET UNIT HEATER	RECEPTION	120	1	1	#12 AWG	#12 AWG	3/4"	LP-2.3	1P15A	PROVIDE 1P15A TOGGLE DISCONNECT
VAV-6	CABINET UNIT HEATER	OFFICE 31	120	1	1	#12 AWG	#12 AWG	3/4"	LP-X	1P15A	PROVIDE 1P15A TOGGLE DISCONNECT
VAV-7	CABINET UNIT HEATER	OFFICE 30	120	1	1	#12 AWG	#12 AWG	3/4"	LP-X	1P15A	PROVIDE 1P15A TOGGLE DISCONNECT
VAV-8	CABINET UNIT HEATER	OFFICE 29	120	1	1	#12 AWG	#12 AWG	3/4"	LP-X	1P15A	PROVIDE 1P15A TOGGLE DISCONNECT
VAV-9	CABINET UNIT HEATER	OFFICE 28	120	1	1	#12 AWG	#12 AWG	3/4"	LP-X	1P15A	PROVIDE 1P15A TOGGLE DISCONNECT
VAV-10	CABINET UNIT HEATER	OFFICE 27	120	1	1	#12 AWG	#12 AWG	3/4"	LP-X	1P15A	PROVIDE 1P15A TOGGLE DISCONNECT
VAV-11	CABINET UNIT HEATER	OFFICE 26	120	1	1	#12 AWG	#12 AWG	3/4"	LP-X	1P15A	PROVIDE 1P15A TOGGLE DISCONNECT
VAV-12	CABINET UNIT HEATER	OFFICE 25	120	1	1	#12 AWG	#12 AWG	3/4"	LP-X	1P15A	PROVIDE 1P15A TOGGLE DISCONNECT
VAV-13	CABINET UNIT HEATER	OFFICE 24	120	1	1	#12 AWG	#12 AWG	3/4"	LP-X	1P15A	PROVIDE 1P15A TOGGLE DISCONNECT
VAV-14	CABINET UNIT HEATER	OFFICE 23	120	1	1	#12 AWG	#12 AWG	3/4"	LP-X	1P15A	PROVIDE 1P15A TOGGLE DISCONNECT
VAV-15	CABINET UNIT HEATER	OFFICE 22	120	1	1	#12 AWG	#12 AWG	3/4"	LP-X	1P15A	PROVIDE 1P15A TOGGLE DISCONNECT
VAV-16	CABINET UNIT HEATER	OFFICE 21	120	1	1	#12 AWG	#12 AWG	3/4"	LP-X	1P15A	PROVIDE 1P15A TOGGLE DISCONNECT
VAV-17	CABINET UNIT HEATER	OFFICE 37	120	1	1	#12 AWG	#12 AWG	3/4"	LP-X	1P15A	PROVIDE 1P15A TOGGLE DISCONNECT
VAV-18	CABINET UNIT HEATER	OFFICE 36	120	1	1	#12 AWG	#12 AWG	3/4"	LP-X	1P15A	PROVIDE 1P15A TOGGLE DISCONNECT
VAV-19	CABINET UNIT HEATER	OFFICE 36	120	1	1	#12 AWG	#12 AWG	3/4"	LP-X	1P15A	PROVIDE 1P15A TOGGLE DISCONNECT

SYMBOL	DESCRIPTION
	PANELBOARD/LOAD CENTER - REFER TO PANELBOARD SCHEDULE
2_4 LP-1 *G	HOMERUN TO PANELBOARD - ARROW HEADS INDICATE NUMBER OF POLES. TEXT ADJACENT TO ARROW HEADS INDICATES PANELBOARD AND CIRCUIT DESIGNATIONS. SLASHES INDICATE CURRENT CARRYING CONDUCTORS. SLASH WITH DOT INDICATES GROUNDING CONDUCTOR. SLASH WITH G INDICATES ISOLATED GROUND CONDUCTOR.
-#	RACEWAY OR CABLE WITH CONDUCTORS AS NOTED
	CONDUIT OR CABLE UP
	CONDUIT OR CABLE DOWN
T	TRANSFORMER
-UE-	UNDERGROUND ELECTRICAL CONDUIT

	LIGHTING
SYMBOL	DESCRIPTION
	LIGHTING FIXTURE AND OUTLET BOX
\oslash	CEILING LIGHTING FIXTURE AND OUTLET BOX
90	WALL-MOUNTED LIGHTING FIXTURE AND OUTLET BOX
\leftarrow	POLE-MOUNTED SITE LIGHT
EM	SHADING/EM DENOTES EMERGENCY FIXTURE - FIXTURE TO BE PROVIDED WITH BATTERY BACKUP
NL	SHADING/NL DENOTES NIGHT-LIGHT FIXTURE - FIXTURE TO BE UNSWITCHED
	EXIT SIGN - SOLID QUADRANT DENOTES DIRECTIONAL ARROWS AND LINE DENOTES PANELS/FACES

		LUMIN	NAIRE SCH	EDULE				
TYPE	DESCRIPTION	MANUFACTURER & CAT. No.	LAMP(S)	BALLAST/VOLT.	MOUNTING	NOTES		
L1-4	4"W x 5"H x 4'L DIRECT LINEAR LED FIXTURE WITH EXTRUDED ALUMINUM HOUSING, SATIN ACRYLIC LENS, 0-10V DIMMING, AND FIVE YEAR WARRANTY	COOPER LIGHTING S124DS-C-575D-8-40-4F0-1-U- DD-F-W OR APPROVED EQUAL	LED 575 LM/FT DOWN 4000K 80CRI	MULTIVOLT	SURFACE	PROVIDE 14W EMERGENCY BATTERY PACK (B2) FOR FIXTURES MARKED EM		
L1-8	4"W x 5"H x 8'L DIRECT LINEAR LED FIXTURE WITH EXTRUDED ALUMINUM HOUSING, SATIN ACRYLIC LENS, 0-10V DIMMING, AND FIVE YEAR WARRANTY	COOPER LIGHTING S124DS-C-575D-8-40-8F0-1-U- DD-F-W OR APPROVED EQUAL	LED 575 LM/FT DOWN 4000K 80CRI	MULTIVOLT	SURFACE	PROVIDE 14W EMERGENCY BATTERY PACK (B2) FOR FIXTURES MARKED EM		
L1-12	4"W x 5"H x 12'L DIRECT LINEAR LED FIXTURE WITH EXTRUDED ALUMINUM HOUSING, SATIN ACRYLIC LENS, 0-10V DIMMING, AND FIVE YEAR WARRANTY	COOPER LIGHTING S124DS-C-575D-8-40-12F0-1- U-DD-F-W OR APPROVED EQUAL	LED 575 LM/FT DOWN 4000K 80CRI	MULTIVOLT	SURFACE	PROVIDE 14W EMERGENCY BATTERY PACK (B2) FOR FIXTURES MARKED EM		
_1-28	4"W x 5"H x 28'L DIRECT LINEAR LED FIXTURE WITH EXTRUDED ALUMINUM HOUSING, SATIN ACRYLIC LENS, 0-10V DIMMING, AND FIVE YEAR WARRANTY	COOPER LIGHTING S124DS-C-575D-8-40-28F0-1- U-DD-F-W OR APPROVED EQUAL	LED 575 LM/FT DOWN 4000K 80CRI	MULTIVOLT	SURFACE	PROVIDE 14W EMERGENCY BATTERY PACK (B2) FOR FIXTURE SECTIONS MARKED EM		
L2-8	4"W x 5"H x 8'L DIRECT/INDIRECT LINEAR LED FIXTURE WITH EXTRUDED ALUMINUM HOUSING, SATIN ACRYLIC LENS, 0-10V DIMMING, AND FIVE YEAR WARRANTY	COOPER LIGHTING S124DIP-C-575D-365U- 8-40-8F0-1-U-DD-F-W OR APPROVED EQUAL	LED 575 LM/FT DOWN 365 LM/FT UP 4000K 80CRI	MULTIVOLT	PENDANT			
L2-16	4"W x 5"H x 16'L DIRECT/INDIRECT LINEAR LED FIXTURE WITH EXTRUDED ALUMINUM HOUSING, SATIN ACRYLIC LENS, 0-10V DIMMING, AND FIVE YEAR WARRANTY	COOPER LIGHTING S124DIP-C-575D-365U- 8-40-16F0-1-U-DD-F-W OR APPROVED EQUAL	LED 575 LM/FT DOWN 365 LM/FT UP 4000K 80CRI	MULTIVOLT	PENDANT			
L2-28	4"W x 5"H x 28'L DIRECT LINEAR LED FIXTURE WITH EXTRUDED ALUMINUM HOUSING, SATIN ACRYLIC LENS, 0-10V DIMMING, AND FIVE YEAR WARRANTY	COOPER LIGHTING S124DIP-C-575D-365U- 8-40-12F0-1-U-DD-F-W OR APPROVED EQUAL	LED 575 LM/FT DOWN 365 LM/FT UP 4000K 80CRI	MULTIVOLT	PENDANT	PROVIDE 14W EMERGENCY BATTERY PACK (B2) FOR FIXTURE SECTIONS MARKED EM		
_2-36	4"W x 5"H x 36'L DIRECT LINEAR LED FIXTURE WITH EXTRUDED ALUMINUM HOUSING, SATIN ACRYLIC LENS, 0-10V DIMMING, AND FIVE YEAR WARRANTY	COOPER LIGHTING S124DIP-C-575D-365U- 8-40-36F0-1-U-DD-F-W OR APPROVED EQUAL	LED 575 LM/FT DOWN 365 LM/FT UP 4000K 80CRI		PENDANT	PROVIDE 14W EMERGENCY BATTERY PACK (B2) FOR FIXTURE SECTIONS MARKED EM		
L2-40	4"W x 5"H x 40'L DIRECT LINEAR LED FIXTURE WITH EXTRUDED ALUMINUM HOUSING, SATIN ACRYLIC LENS, 0-10V DIMMING, AND FIVE YEAR WARRANTY	COOPER LIGHTING S124DIP-C-575D-365U- 8-40-40F0-1-U-DD-F-W OR APPROVED EQUAL	LED 575 LM/FT DOWN 365 LM/FT UP 4000K 80CRI	MULTIVOLT	PENDANT	PROVIDE14W EMERGENCY BATTERY PACK (B2) FOR FIXTURE SECTIONS MARKED EM		
L2-48	4"W x 5"H x 48'L DIRECT LINEAR LED FIXTURE WITH EXTRUDED ALUMINUM HOUSING, SATIN ACRYLIC LENS, 0-10V DIMMING, AND FIVE YEAR WARRANTY	COOPER LIGHTING S124DIP-C-575D-365U- 8-40-48F0-1-U-DD-F-W OR APPROVED EQUAL	LED 575 LM/FT DOWN 365 LM/FT UP 4000K 80CRI	MULTIVOLT	PENDANT	PROVIDE 14W EMERGENCY BATTERY PACK (B2) FOR FIXTURE SECTIONS MARKED EM		
L3-2	4"W x 5"H x 2'L DIRECT/INDIRECT LINEAR LED FIXTURE WITH EXTRUDED ALUMINUM HOUSING, SATIN ACRYLIC LENS, 0-10V DIMMING, AND FIVE YEAR WARRANTY	COOPER LIGHTING S124DIW-C-575D-470U- 8-40-2F0-1-U-DD-F-W OR APPROVED EQUAL	LED 575 LM/FT DOWN 470 LM/FT UP 4000K 80CRI	MULTIVOLT	WALL- MOUNTED			
L3-8	4"W x 5"H x 8'L DIRECT/INDIRECT LINEAR LED FIXTURE WITH EXTRUDED ALUMINUM HOUSING, SATIN ACRYLIC LENS, 0-10V DIMMING, AND FIVE YEAR WARRANTY	COOPER LIGHTING ETO165449-S124DIW- C-175D-250U-8-40-8F0-1-U- DD-F-W OR APPROVED EQUAL	LED 175 LM/FT DOWN 250 LM/FT UP 4000K 80CRI	MULTIVOLT	WALL- MOUNTED	PROVIDE 14W EMERGENCY BATTERY PACK (B2) FOR FIXTURES MARKED EM		
L4	2'x2' LED PANEL WITH 0-10V DIMMING, AND FIVE YEAR WARRANTY	COOPER LIGHTING 22FP4240C OR APPROVED EQUAL	LED 4400 LUMENS 4000K 90CRI	MULTIVOLT	RECESSED IN CEILING GRID			
D1	6" ROUND RECESSED LED DOWNLIGHT WITH MEDIUM DISTRIBUTION TRIM, 0-10V DIMMING, AND FIVE YEAR WARRANTY	COOPER LIGHTING LD6C-05-90-40-D010-MD-0-LI OR APPROVED EQUAL	LED 500 LUMENS 4000K 90CRI	MULTIVOLT	RECESSED			
P1	6" ROUND DECORATIVE PENDANT WITH FROSTED GLASS GLOBE AND FIVE YEAR WARRANTY	BICYCLE LIGHTING GLACIAL 763 SINGLE PENDANT OR APPROVED EQUAL	LED E-26 BULB	MULTIVOLT RECESSED		PROVIDE 8W 4000K LED E-26 EDISON BULB ARCHITECT TO SELECT FINISH		
X1	WHITE LED STRIP LIGHTING WITH ALUMINUM CHANNEL, DIFFUSER LENS, AND FIVE YEAR WARRANTY	WAC LIGHTING T24-GE2-24-40WT OR APPROVED EQUAL	LED 200LM/FT 4000K 90CRI	24V	RECESSED BEHIND DECORATIVE WALL PANEL	PROVIDE 24V POWER SUPPLY, ALUMINUM CHANNEL WITH DIFFUSER, AND ALL REQUIRED ACCESSORIES FOR A COMPLETE INSTALLATION		
\otimes	LED EXIT SIGN WITH UV-STABILIZED THERMOPLASTIC HOUSING, NICKEL CADMIUM BATTERY, AND SELF DIAGNOSTICS	LITHONIA LIGHTING LQM-S-W-R-ELN-SD OR APPROVED EQUAL	LED	MULTIVOLT WITH BATTERY PACK	AS INDICATED ON DRAWINGS	PROVIDE FACES AND ARROWS AS INDICATED ON DRAWINGS		
M	LED WET LOCATION SINGLE REMOTE HEAD WITH IMPACT-RESISTANT THERMOPLASTIC HOUSING	LITHONIA LIGHTING ERE-GY-SGL-WP-RD OR APPROVED EQUAL	LED	POWERED FROM EXIT SIGN	WALL MOUNTED			



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Client: LACTALIS

Project: OFFICE RENO AT 2376 SOUTH PARK

Project Address: 2376 SOUTH PARK AVE

Drawing History: <u># Date Description</u>

Project Number: 25042

Sheet Title: SYMBOL LEGEND, **DETAILS & SCHEDULES**

E001



PROVIDE MOUNTING

CLIPS COMPATIBLE

DIFFUSER CHANNEL

ATTACH TO WOOD CLEAT SYSTEM —

WITH ALUMINUM


WALL PANEL (REFER TO ARCHITECTURAL DRAWINGS)

WOOD CLEAT (REFER TO ARCHITECTURAL DRAWINGS)

ALUMINUM DIFFUSER


CHANNEL WITH LED

STRIP LIGHT

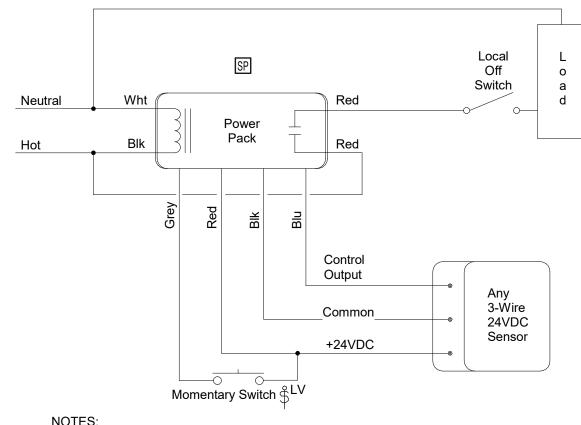

A. CONFIGURE FOR MANUAL ON OPERATION B. TYPICAL FOR STORAGE ROOMS C. POWER PACKS TO BE LOCATED ABOVE ACCESSIBLE CEILINGS


3 VACANCY SENSOR CONTROL WIRING DIAGRAM NOT TO SCALE

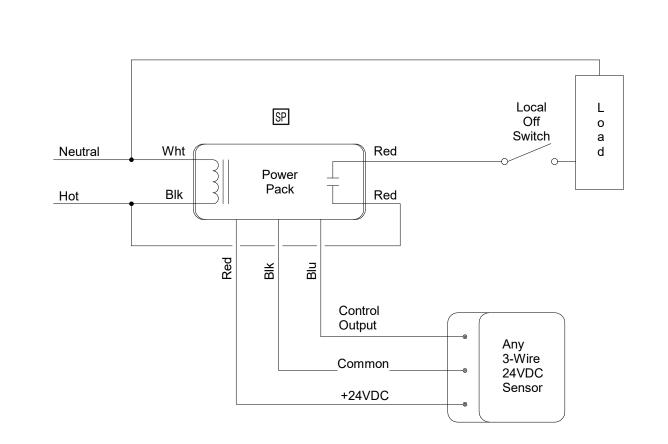

LED STRIP LIGHT MOUNTING DETAIL
NOT TO SCALE

A. CONFIGURE FOR AUTOMATIC ON OPERATION B. TYPICAL FOR RESTROOMS, VESTIBULE, AND SPACES WHERE DIMMING IS NOT REQUIRED C. POWER PACKS TO BE LOCATED ABOVE ACCESSIBLE CEILINGS




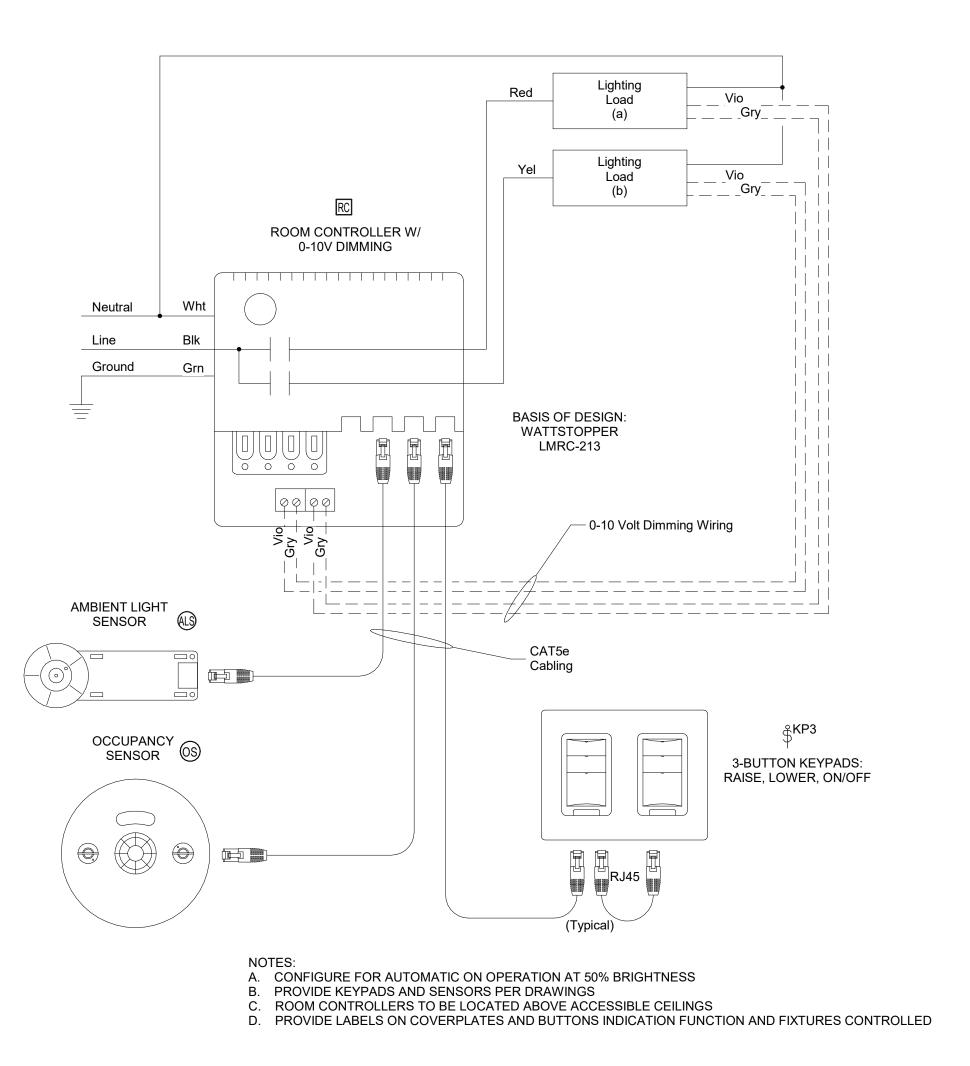

0-10V LIGHTING CONTROL

WIRING DIAGRAM

1/8" = 1'-0"

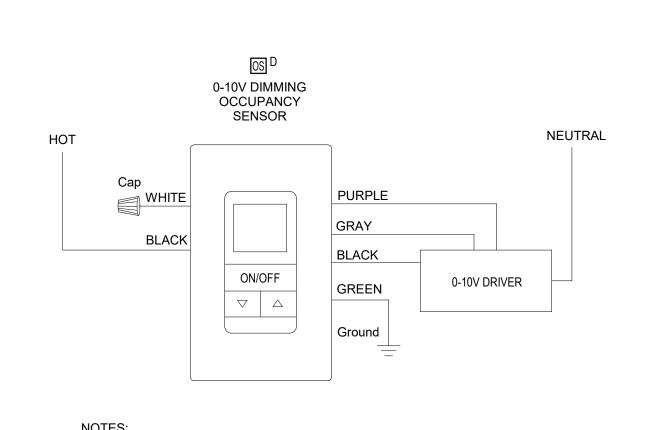

A. CONFIGURE FOR AUTOMATIC ON OPERATION AT 50% BRIGHTNESS

6 0-10V DIMMING WALL OCCUPANCY SENSOR WIRING DIAGRAM
NOT TO SCALE



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Client: LACTALIS

Project: OFFICE RENO AT 2376 SOUTH PARK


Project Address: 2376 SOUTH PARK AVE BUFFALO, NY 14220

Drawing History: # Date Description

Sheet Title: ELECTRICAL

DETAILS

E002

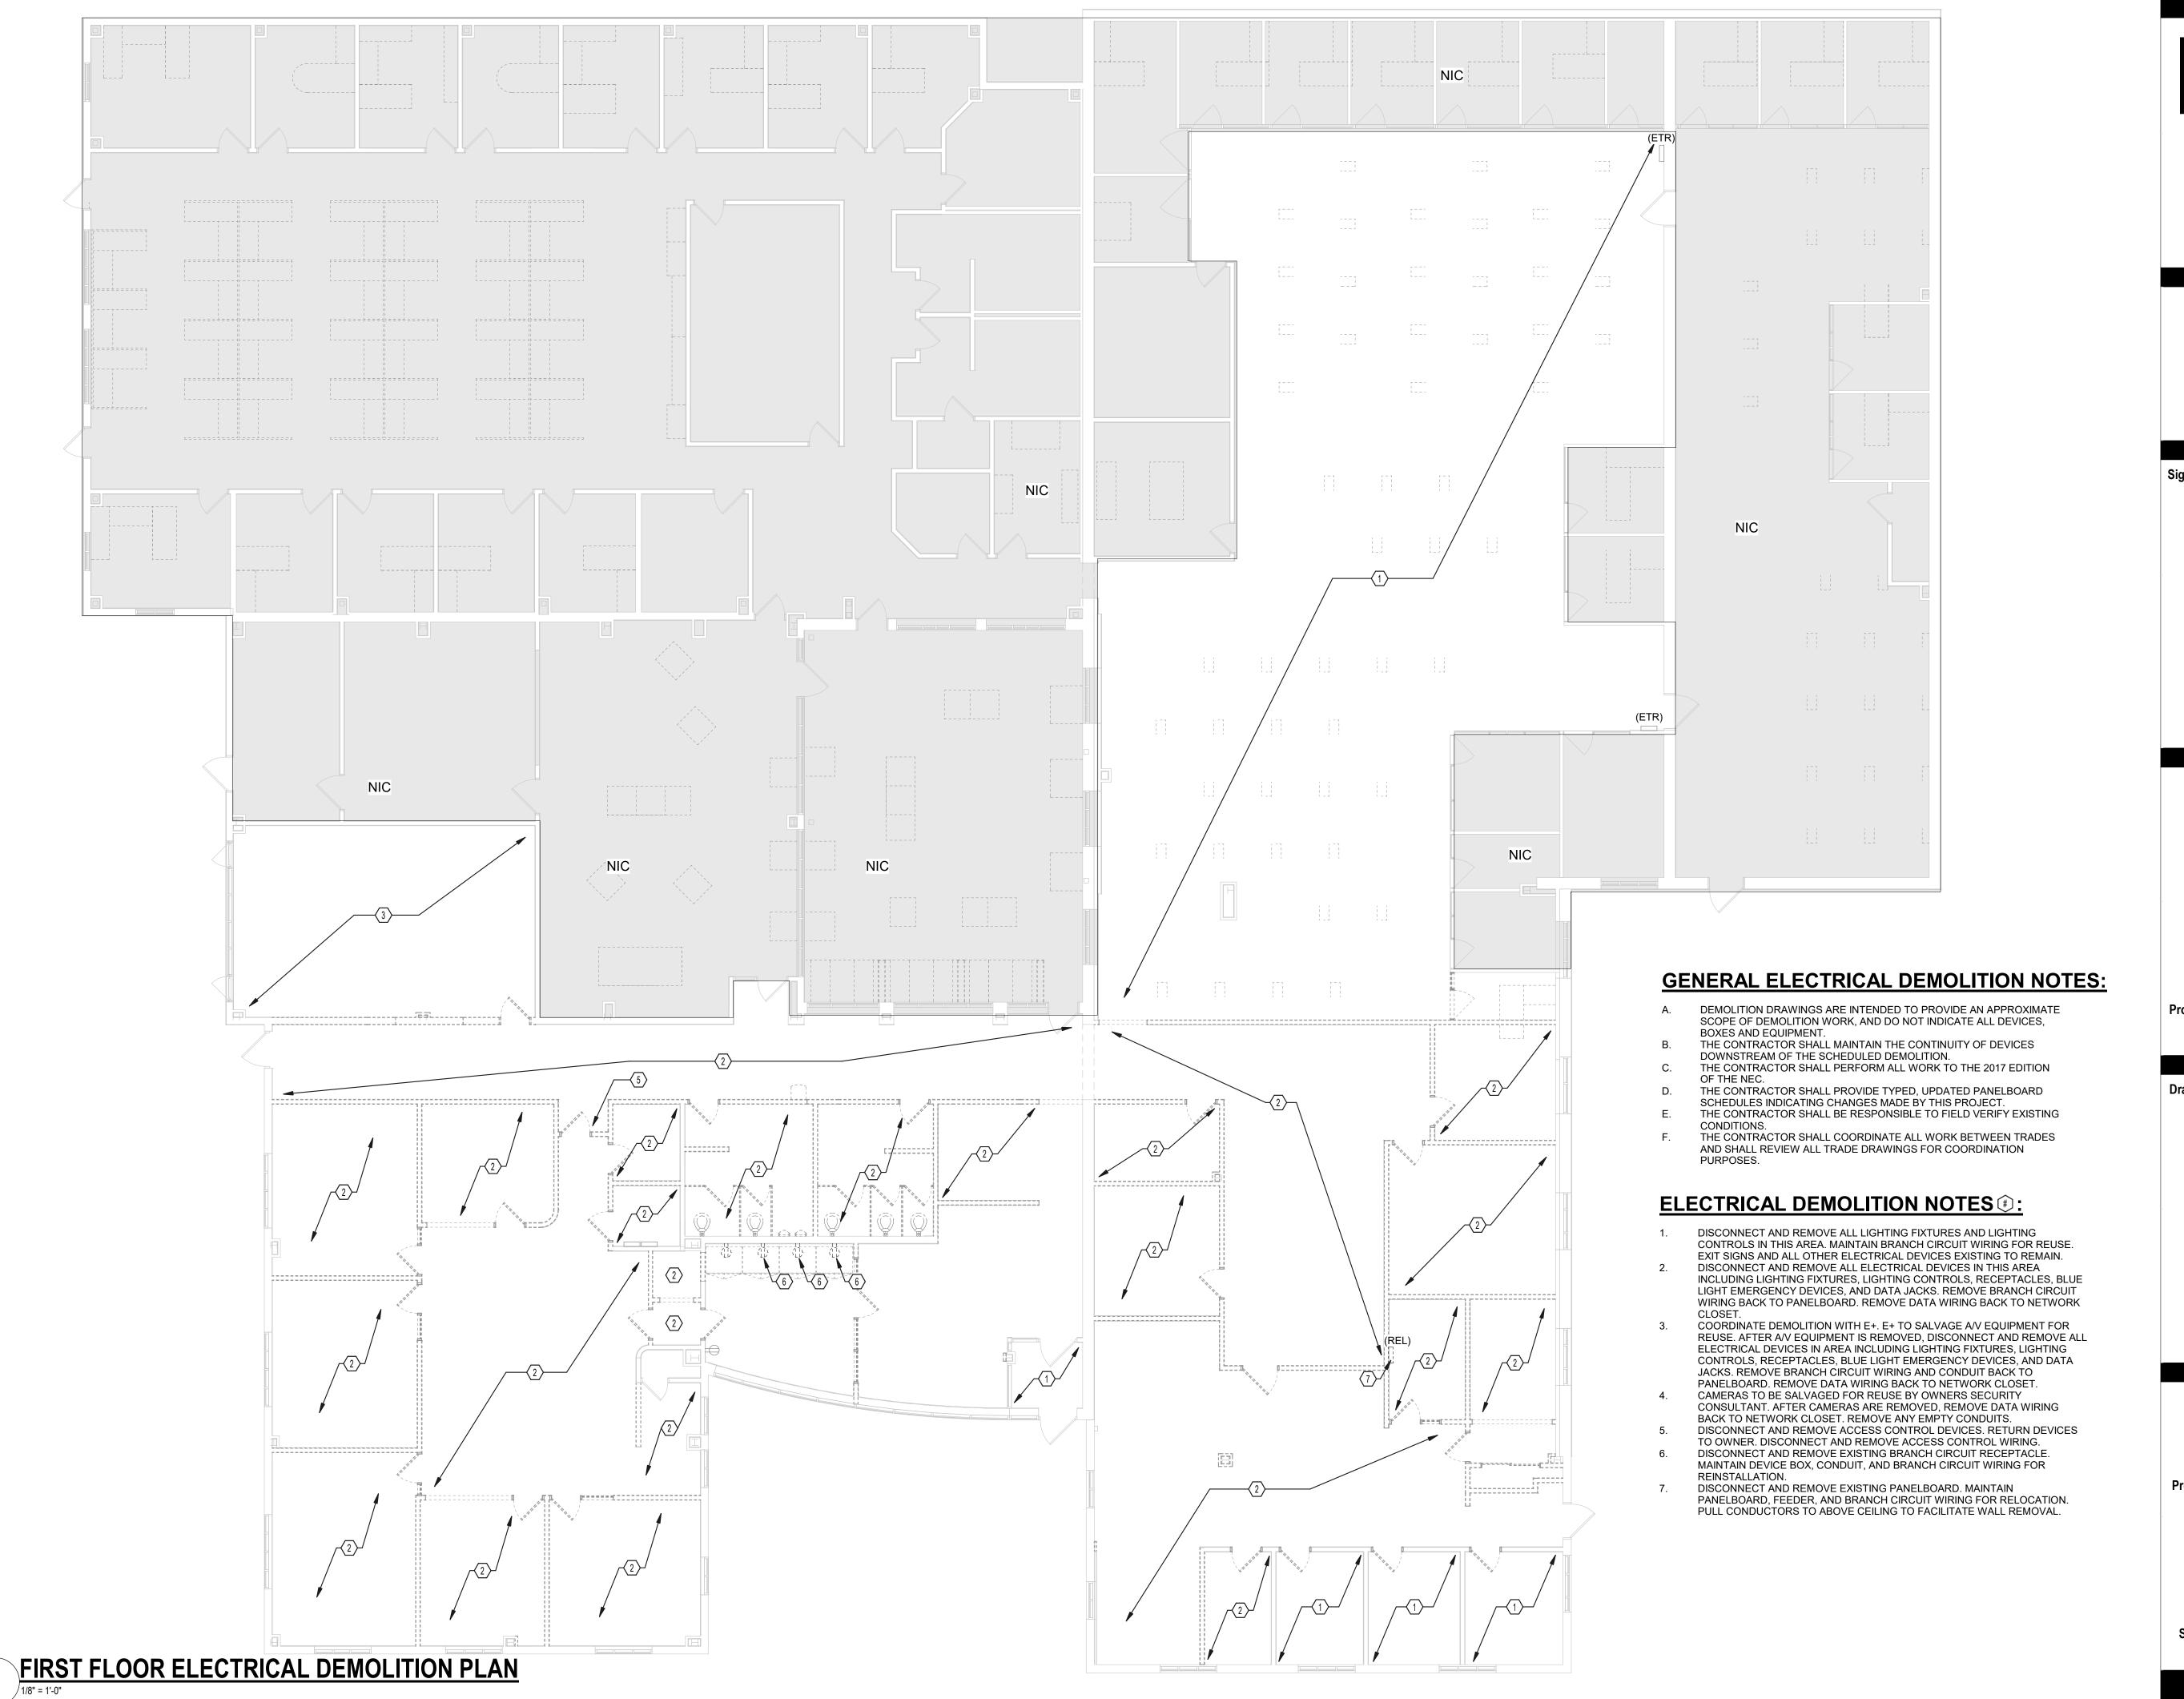

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Client: LACTALIS

Project: OFFICE RENO AT 2376 SOUTH PARK


Project Address: 2376 SOUTH PARK AVE BUFFALO, NY 14220

Drawing History: # Date Description

Date: 11/6/2025 Project Number: 25042

Sheet Title: FIRST FLOOR **ELECTRICAL DEMOLITION PLAN**

ED101

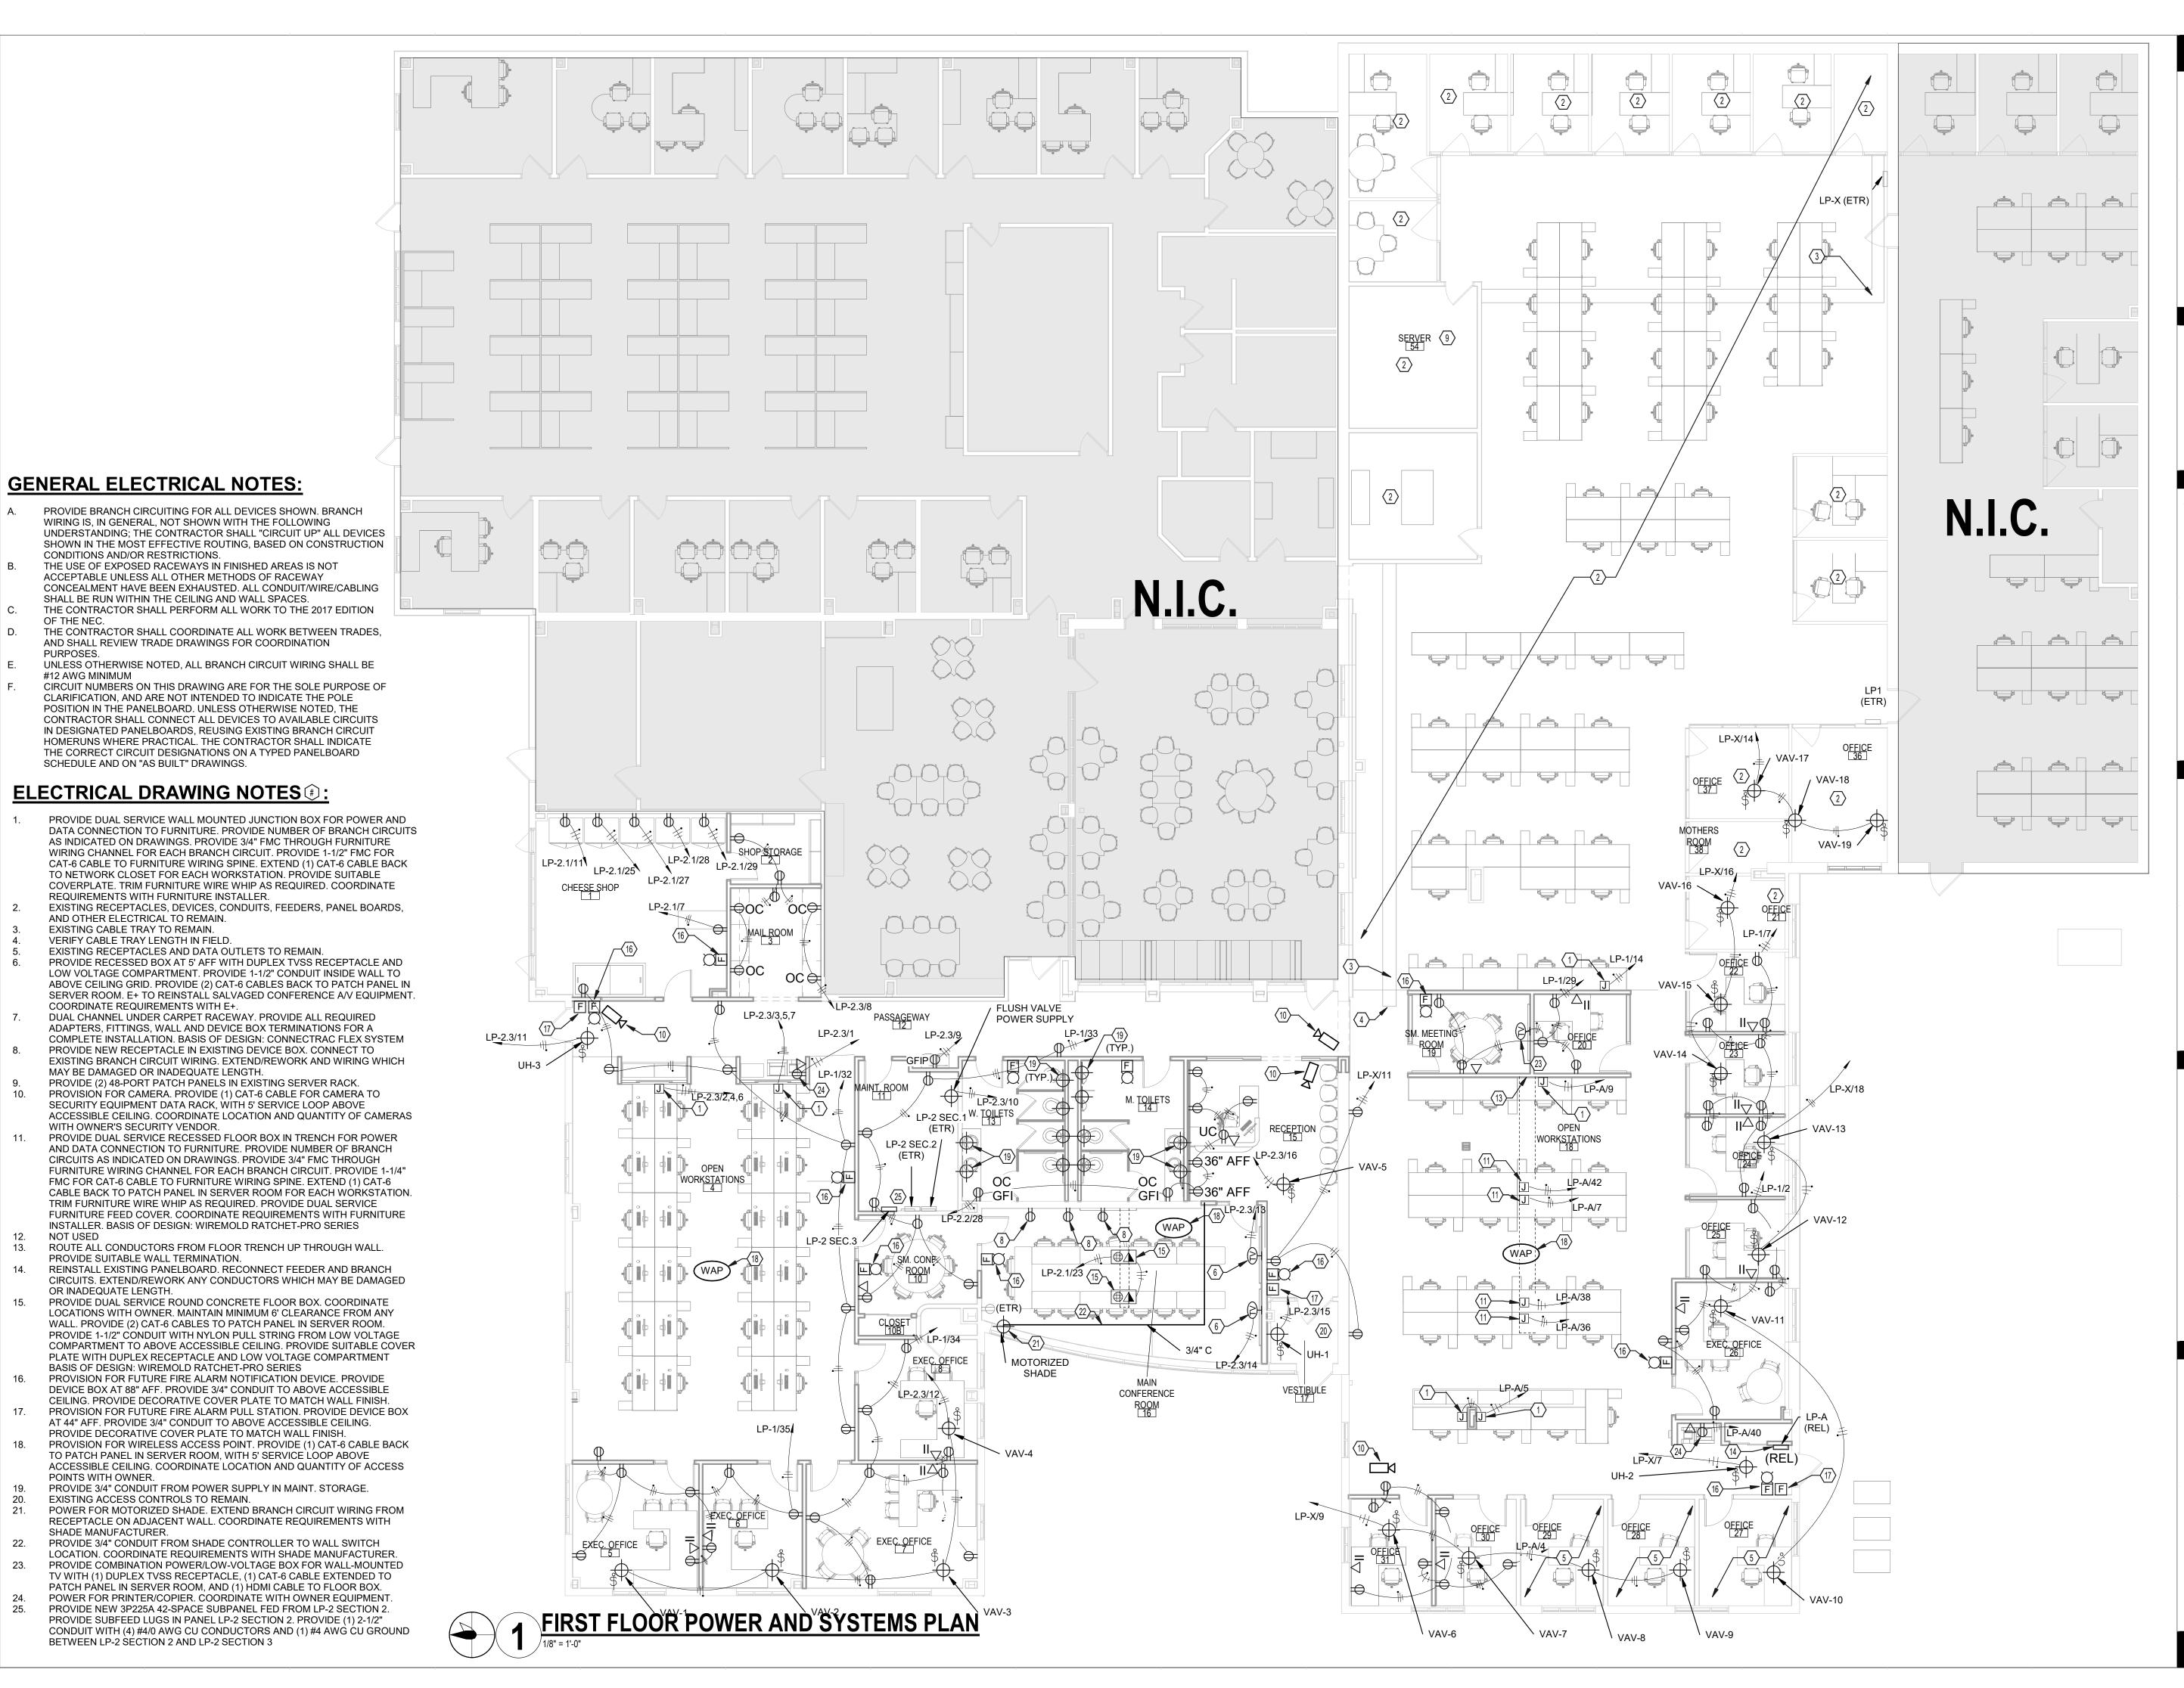



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Client: LACTALIS

Project: OFFICE RENO AT 2376 SOUTH PARK


Project Address: 2376 SOUTH PARK AVE

Drawing History: # Date Description

Sheet Title: FIRST FLOOR POWER & SYSTEMS

PLAN

E101

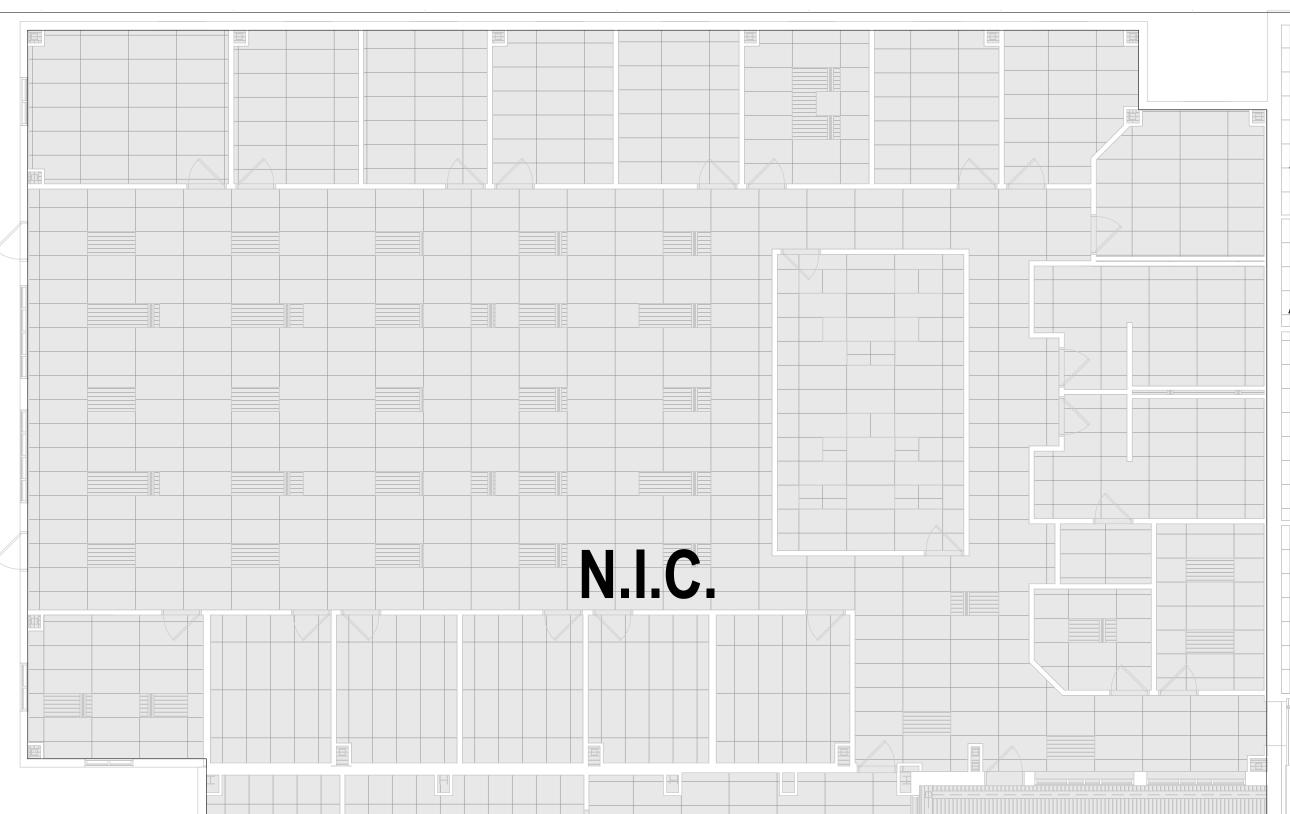


ELECTRICAL DRAWING NOTES (#):

- EXISTING LIGHTING, CONTROLS, AND CIRCUITING TO REMAIN CONFIGURE FOR MANUAL ON OPERATION.
- LOCATE SWITCHPACK ABOVE ACCESSIBLE CORRIDOR CEILING. COORDINATE FIXTURE LOCATION TO CENTER ON WALL WAVE PATTERN.
- REFER TO ARCHITECTURAL DRAWINGS. PROVIDE LED STRIP LIGHTING, ALUMINUM CHANNEL, AND DIFFUSER LENS. INSTALL STRIP LIGHTING CONCEALED BEHIND WALL PANEL REVEAL. CUT CHANNEL AND LIGHTING STRIP TO FIT BEHIND WALL PANEL. COORDINATE
- WITH ARCHITECTURAL DRAWINGS. PROVIDE IN-WALL CONNECTOR BETWEEN LED SEGMENTS. CONCEAL CONNECTOR AND WALL PENETRATION BEHIND WALL PANEL REVEAL.

PROVIDE 24V LED STRIP LIGHT POWER SUPPLY WITH 0-10V DIMMING ABOVE GENERAL ELECTRICAL NOTES: G SWITCH LEG. BASIS

- PROVIDE BRANCH CIRCUITING FOR ALL DEVICES SHOWN. BRANCH WIRING IS, IN GENERAL, NOT SHOWN WITH THE FOLLOWING UNDERSTANDING; THE CONTRACTOR SHALL "CIRCUIT UP" ALL DEVICES SHOWN IN THE MOST EFFECTIVE ROUTING, BASED ON CONSTRUCTION CONDITIONS AND/OR RESTRICTIONS.
- THE USE OF EXPOSED RACEWAYS IN FINISHED AREAS IS NOT ACCEPTABLE UNLESS ALL OTHER METHODS OF RACEWAY CONCEALMENT HAVE BEEN EXHAUSTED. ALL CONDUIT/WIRE/CABLING
- SHALL BE RUN WITHIN THE CEILING AND WALL SPACES. THE CONTRACTOR SHALL PERFORM ALL WORK TO THE 2017 EDITION OF THE NEC.
- THE CONTRACTOR SHALL COORDINATE ALL WORK BETWEEN TRADES, AND SHALL REVIEW TRADE DRAWINGS FOR COORDINATION
- UNLESS OTHERWISE NOTED, ALL BRANCH CIRCUIT WIRING SHALL BE #12 AWG MINIMUM CIRCUIT NUMBERS ON THIS DRAWING ARE FOR THE SOLE PURPOSE OF
- CLARIFICATION, AND ARE NOT INTENDED TO INDICATE THE POLE POSITION IN THE PANELBOARD. UNLESS OTHERWISE NOTED, THE CONTRACTOR SHALL CONNECT ALL DEVICES TO AVAILABLE CIRCUITS IN DESIGNATED PANELBOARDS. THE CONTRACTOR SHALL INDICATE THE CORRECT CIRCUIT DESIGNATIONS ON A TYPED PANELBOARD SCHEDULE AND ON "AS BUILT" DRAWINGS.
- PROGRAM ALL LIGHTING CONTROLS PER 2020 NYS ENERGY CODE. CONNECT BATTERY EMERGENCY LIGHTS TO LINE (UNSWITCHED) SIDE OF NORMAL LIGHTING CIRCUITS.
- CONNECT FIXTURES TO EXISTING BRANCH CIRCUIT WIRING. EXTEND/REWORK EXISTING BRANCH CIRCUIT WIRING THAT MAY BE DAMAGED OR INADEQUATE LENGTH. CIRCUIT NUMBERS SHOWN FOR REFERENCE ONLY.

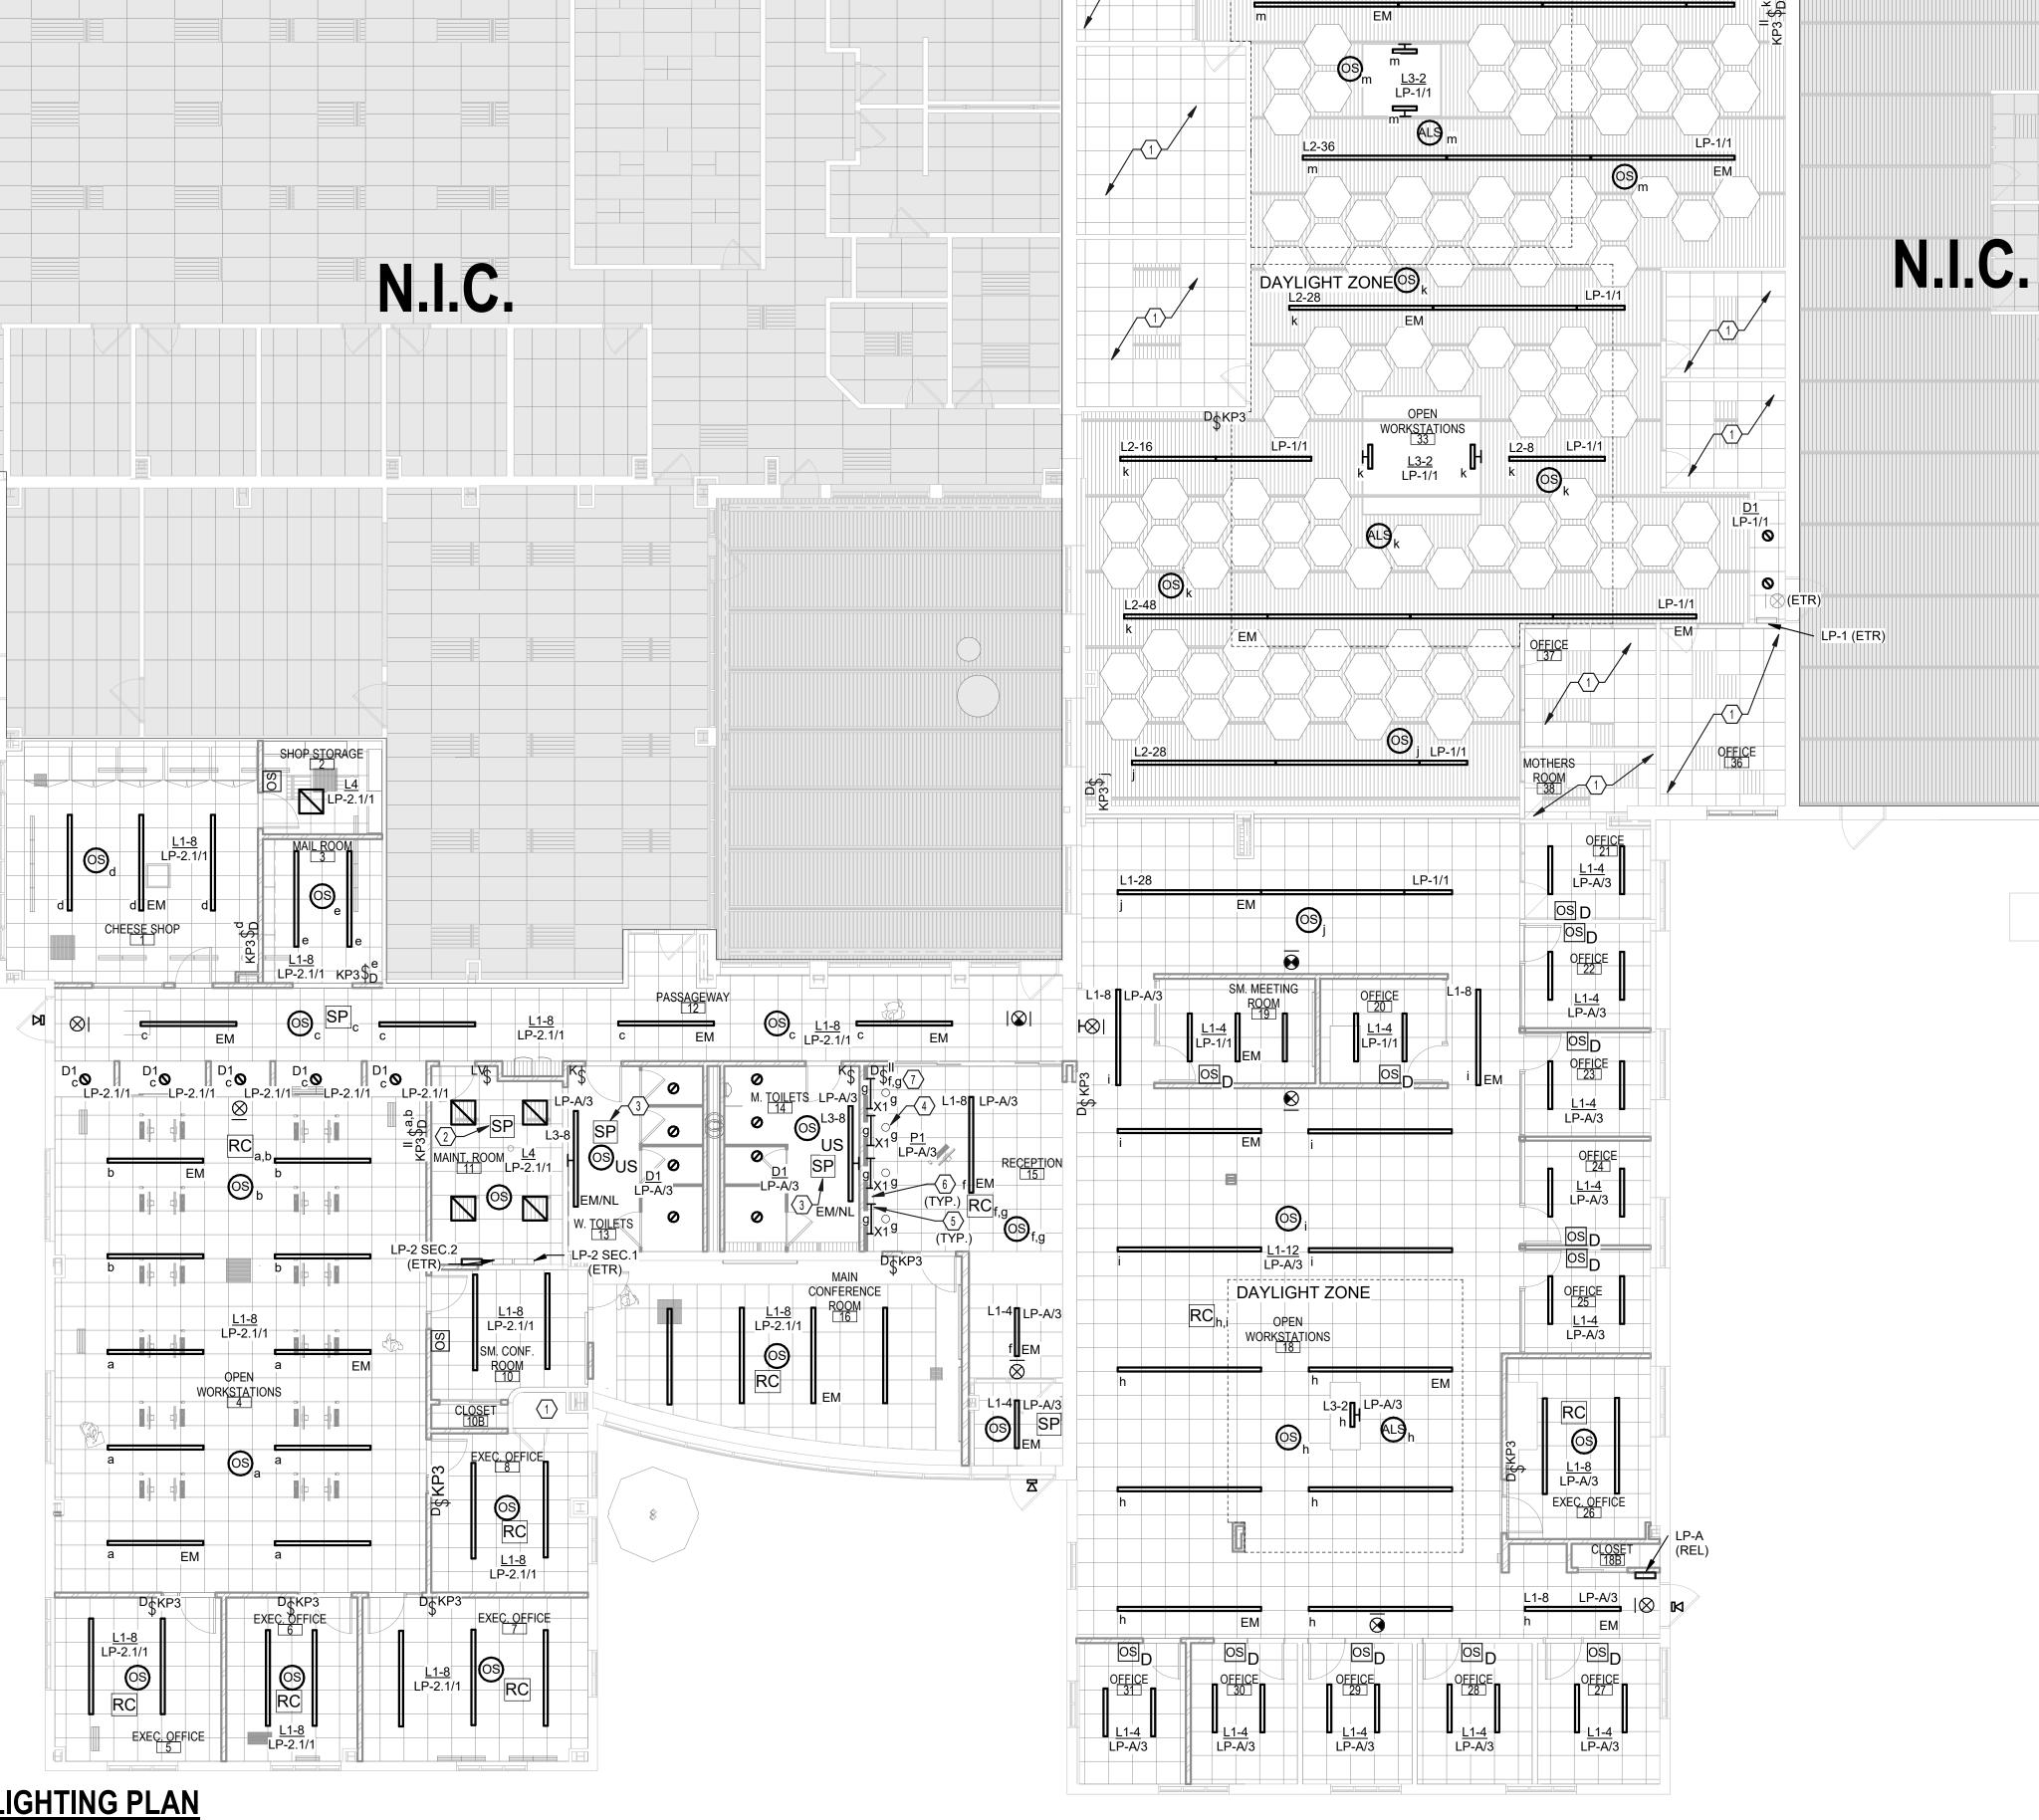

DAYLIGHT ZONE



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Client: LACTALIS

Project: OFFICE RENO AT 2376 SOUTH PARK

Project Address: 2376 SOUTH PARK AVE

Drawing History: # Date Description

11/6/2025 Project Number: 25042

Sheet Title: FIRST FLOOR LIGHTING PLAN

Sheet Number:

E201

1 FIRST FLOOR LIGHTING PLAN
1/8" = 1'-0"

GENERAL NOTES

- 1. THE WORK INCLUDED IN THIS CONTRACT ENCOMPASSES BOTH THE DRAWINGS AND SPECIFICATIONS. WORK INCLUDED ON THE DRAWINGS ONLY, OR IN THE SPECIFICATION ONLY, SHALL BE INCORPORATED
- 2. THE WORK SHALL CONSIST OF PROVIDING ALL MATERIALS, LABOR, EQUIPMENT, AND APPARATUSES AND PERFORMING ALL OPERATIONS REQUIRED FOR INSTALLATION OF A COMPLETE ELECTRICAL SYSTEM. 3. EVERY ITEM OF WORK OR MINOR PIECE OF EQUIPMENT IS NOT SHOWN ON DRAWINGS. THE CONTRACTOR SHALL PROVIDE ALL COMPONENTS NECESSARY FOR A FULLY AND PROPERLY OPERATING SYSTEM IN ACCORDANCE WITH PROFESSIONAL PRACTICE OF THE TRADE.
- 4. THE CONTRACTOR SHALL PERSONALLY INSPECT THE SITE OF THE PROPOSED WORK AND BECOME FULLY INFORMED AS TO THE CONDITIONS UNDER WHICH THE WORK IS TO BE DONE. FAILURE TO DO SO WILL NOT BE CONSIDERED SUFFICIENT JUSTIFICATION TO REQUEST OR OBTAIN EXTRA COMPENSATION OVER AND ABOVE THE CONTRACT PRICE.
- 5. THE DRAWINGS INDICATE SIZE AND GENERAL ARRANGEMENT OF EQUIPMENT, RACEWAYS, DEVICES, ETC. EXACT LOCATIONS AND ROUTINGS SHALL BE DETERMINED IN THE FIELD BEFORE START OF THE WORK AND AS THE WORK PROGRESSES.
- 6. THE DRAWINGS DO NOT INDICATE ALL OFFSETS, CHANGES IN ELEVATION, ETC. WHICH MAY BE REQUIRED BY ACTUAL FIELD CONDITIONS. FIELD VERIFY CONDITIONS PRIOR TO INSTALLATION AND MAKE SUCH CHANGES IN EQUIPMENT, AND RACEWAY LOCATIONS AS NECESSARY TO ACCOMMODATE FIELD CONDITIONS
- 7. THE DRAWINGS DETERMINE THE GENERAL INTENT OF THE PROJECT. THE CONTRACTOR SHALL PERSONALLY VISIT THE SITE OF THE PROPOSED WORK AND FULLY DETERMINE THE EXACT LOCATIONS OF EXISTING EQUIPMENT TO BE REUSED AND RELOCATED, AVAILABILITY OF EXISTING CIRCUIT BREAKERS
- IN EXISTING PANELBOARDS OR BUSDUCTS, QUANTITY AND LOCATION OF EXISTING DEVICES, ETC. 8. VERIFY EXISTING PANELBOARDS FOR SUFFICIENT CAPACITY AND POLE SPACE TO ACCOMMODATE
- PROJECT SCOPE. CONTACT OWNER WITH ANY PANELBOARD CONCERNS. 9. ALL MATERIALS AND APPARATUS SHALL BE NEW AND IN FIRST CLASS CONDITION. ALL MATERIALS AND EQUIPMENT SHALL BE OF COMMERCIAL SPECIFICATION GRADE IN QUALITY. MATERIAL AND EQUIPMENT SHALL BE STORED AND MAINTAINED IN CLEAN CONDITION, AND PROTECTED FROM WEATHER, MOISTURE,
- 10. ALL HOISTS, SCAFFOLDS, TOOLS, MACHINERY, EQUIPMENT, ETC. REQUIRED FOR PERFORMANCE OF THE
- ELECTRICAL WORK SHALL BE FURNISHED BY THE CONTRACTOR. 11. THE CONTRACTOR SHALL COORDINATE ALL WORK BETWEEN TRADES AND SHALL REVIEW ALL TRADE
- DRAWINGS FOR COORDINATION PURPOSES. 12. THE CONTRACTOR SHALL PERFORM ALL WORK IN COMPLIANCE WITH THE CURRENT EDITION OF THE NATIONAL ELECTRICAL CODE AND ALL APPLICABLE NYS CODES AND STANDARDS. BUILDING PERMIT
- SHALL FOLLOW THE 2017 EDITION OF NATIONAL ELECTRICAL CODE 13. THE CONTRACTOR SHALL OBTAIN AND PAY FOR ALL PERMITS, LICENSES, AND/OR BONDS. OBTAIN LOCAL
- ELECTRICAL INSPECTION CERTIFICATE AND DELIVER TO OWNER. 14. PROVIDE PROPER LABELS FOR ELECTRIC SHOCK AND ARC-FLASH HAZARDS FOR ALL NEW PANELBOARDS
- AND DISCONNECT SWITCHES. 15. SUBMIT FOR APPROVAL SUBMITTALS AND SHOP DRAWINGS FOR ALL MAJOR EQUIPMENT.
- 16. THE CONTRACTOR SHALL PERFORM ALL CUTTING AND PATCHING OF FLOORS, WALLS, CEILING, ETC. AS REQUIRED TO INSTALL WORK UNDER THIS SECTION. CUTTING SHALL BE LIMITED TO THE LEAST EXTENT POSSIBLE. ALL PATCHING SHALL MATCH THE ORIGINAL MATERIAL, CONSTRUCTION, AND FINISHES. CUTTING AND PATCHING SHALL BE PERFORMED BY PERSONNEL TRAINED AND REGULARLY EMPLOYED
- FOR SUCH SERVICES. PAINT ALL PATCHED AREAS TO MATCH EXISTING FINISH AND COLOR. 17. SEAL ALL MADE PENETRATIONS TO RESTORE THE FIRE AND SMOKE RATINGS OF WALLS, CEILINGS, ETC. TO MATCH EXISTING CONSTRUCTION.
- 18. ALL ROOF PENETRATIONS TO BE PROVIDED BY OTHERS.
- 19. MAINTAIN FIRE-RATING OF ALL CONSTRUCTION AFFECTED BY ELECTRICAL REMOVALS OR INSTALLATION WORK. INSTALL FIRESTOPPING AT ALL MADE PENETRATIONS AND OPENINGS TO MAINTAIN FIRE RATING OF WALL ASSEMBLIES. EXISTING CORRIDOR WALL ASSEMBLIES SHALL HAVE MINIMUM ONE-HOUR FIRE RATING UNLESS OTHERWISE NOTED. REFER TO A-SERIES DRAWINGS FOR FIRE RATING OF EXSITING
- 20. PRIOR TO MAKING ANY CONCRETE FLOOR SLAB PENETRATIONS USE A "REBAR LOCATOR" TO LOCATE CONCRETE SLAB REINFORCING STEEL AND OTHER EMBEDMENTS. ADJUST LOCATIONS OF PENETRATIONS TO AVOID CUTTING OF SLAB REINFORCING STEEL AND EMBEDMENTS. WHERE CUTTING OF SLAB REF.
- 21. PRIOR TO RELOCATING EXISTING DEVICE(S), VERIFY PROPER FUNCTIONING OF DEVICE(S). REPORT ANY DEFECTIVE DEVICES. VERIFY PROPER FUNCTIONING OF DEVICE(S) AFTER RELOCATION.
- 22. DISPOSE OF REPLACED DEVICES . 23. ALL RACEWAY RUN UNDERGROUND, EXPOSED TO WEATHER, OR OTHER HAZARDOUS CONDITIONS SHALL
- BE RIGID METALLIC CONDUIT OR RIGID NONMETALLIC CONDUIT. 24. ALL OTHER RACEWAY MAY BE EMT WHERE ALLOWED BY CODE.
- 25. FINAL CONNECTIONS TO EACH MOTOR, TRANSFORMER, AND OTHER VIBRATING EQUIPMENT SHALL BE INSTALLED IN FLEXIBLE METALLIC CONDUIT. 26. LIQUID-TIGHT FLEXIBLE METALLIC CONDUIT SHALL BE USED AT WET LOCATIONS AND WHERE EXPOSED
- ΓΟ LIQUIDS OR VAPORS. 27. SURFACE RACEWAYS SHALL NOT BE USED UNLESS ALL OTHER METHODS OF RACEWAY CONCEALMENT
- HAVE BEEN EXHAUSTED AND THEN ONLY AFTER PRE-APPROVAL FROM THE ARCHITECT. 28. MINIMUM RACEWAY SIZE SHALL BE 3/4". RACEWAY SHALL BE INSTALLED CONCEALED ABOVE CEILINGS OR WITHIN WALLS OR FLOORS WHERE POSSIBLE. EXISTING RACEWAYS MAY BE REUSED WHERE IN GOOD CONDITION.
- 29. CONDUITS SHALL BE SECURELY FASTENED IN PLACE WITH APPROVED STRAPS, HANGERS, AND STEEL
- SUPPORTS AS REQUIRED. 30. PROVIDE BRANCH CIRCUITING FOR ALL DEVICES SHOWN. BRANCH CIRCUIT ROUTING IS NOT SHOWN WITH THE FOLLOWING UNDERSTANDING: THE ELECTRICAL CONTRACTOR SHALL CIRCUIT UP ALL DEVICES SHOWN IN THE MOST COST EFFECTIVE ROUTING, BASED ON CONSTRUCTION CONDITIONS AND/OR
- 31. ALL WIRING SHALL HAVE COPPER CONDUCTORS WITH 600V THHN/THWN INSULATION. WIRING SHALL BE #12 AWG MINIMUM WITH THE EXCEPTION OF CONTROL WIRING. METAL CLAD CABLE, TYPE MC, MAY BE USED WHERE CONCEALED WITHIN BUILDING CONSTRUCTION. ALUMINUM CONDUCTORS ARE NOT PERMITTED.
- 32. ALL CIRCUITS SHALL HAVE AN INSULATED EQUIPMENT GROUNDING CONDUCTOR, SIZED PER NEC.
- 33. VOLTAGE DROP IN BRANCH CIRCUITS SHALL NOT EXCEED 3%. INCREASE WIRE SIZES AS REQUIRED. 34. ALL CEILING MOUNTED DEVICES SHALL BE PROPERLY SUPPORTED FROM CEILING SLAB.
- 35. ALL TRANSFORMERS, RACEWAYS, AND EQUIPMENT WHICH REQUIRE GROUNDING SHALL BE EFFECTIVELY GROUNDED IN COMPLIANCE WITH THE NATIONAL ELECTRICAL CODE.
- 36. PROVIDE BRANCH CIRCUIT PROTECTIVE DEVICES IN EXISTING PANELS TO MATCH EXISTING DEVICE TYPE AND INTERRUPTING RATING. NEW CIRCUIT BREAKERS FOR EXISTING PANELBOARDS MUST BE LISTED FOR USE WITH EXISTING EQUIPMENT.
- 37. ALL CIRCUIT BREAKERS MUST BE BOLT-ON TYPE. MULTI-POLE CIRCUIT BREAKERS MUST BE COMMON
- 38. PROVIDE TYPEWRITTEN DIRECTORY IN EACH PANELBOARD AFFECTED BY THE WORK UNDER THIS
- CONTRACT. 39. INSTALL AND CONNECT ALL MOTOR CONTROLLERS FURNISHED BY HVAC CONTRACTOR.
- 40. FURNISH AND INSTALL FUSED OR NON-FUSED SAFETY SWITCHES WHERE REQUIRED BY CODE. 41. PROVIDE ALL SIMPLEX, DUPLEX, GFCI AND SPECIAL RECEPTACLES PER PLANS.
- 42. PROVIDE VIBRATION CONTROLS AND SEISMIC RESTRAINTS FOR ALL ELECTRICAL COMPONENTS AND SYSTEMS AS REQUIRED BY CODE.
- 43. ALL ELECTRICAL DEVICES NOT REQUIRED FOR REUSE AND/OR RELOCATION ARE TO BE DISCONNECTED, REMOVED, AND TURNED OVER TO OWNER.
- 44. MAINTAIN A SET OF RECORD DRAWINGS ON SITE UPON WHICH ALL CHANGES AND DEVIATIONS FROM THE ORIGINAL LAYOUT SHALL BE RECORDED. SUBMIT TO OWNER PRIOR TO APPLICATION FOR FINAL PAYMENT.
- 45. CLEARLY AND PERMANENTLY MARK ALL EQUIPMENT, PANELBOARDS, DISCONNECT SWITCHES, AND
- DEVICE COVERPLATES. 46. COORDINATE ALL REQUIRED SERVICE OUTAGES AND SHUTDOWNS WITH OWNER. PROVIDE OVERTIME
- AND AFTER-HOURS WORK AS REQUIRED TO ACCOMMODATE OWNER-APPROVED SHUTDOWN PERIODS. 47. FURNISH OWNER WITH A WRITTEN GUARANTEE COVERING THIS WORK; INCLUDING ALL EQUIPMENT, DEVICES, MATERIALS, AND WORKMANSHIP AGAINST ALL DEFECTS FOR A PERIOD OF ONE (1) YEAR FROM
- 48. CONTRACTOR SHALL REGULARLY REMOVE FROM THE PREMISES ALL SPOILS FROM THE PERFORMANCE
- OF THE ELECTRICAL WORK TO PREVENT ACCUMULATION.

DATE OF ACCEPTANCE.

49. UNLESS OTHERWISE NOTED ON THE ARCHITECTURAL DRAWINGS, IT IS THE RESPONSIBILITY OF THIS CONTRACTOR TO REMOVE AND REPLACE EXISTING CEILINGS AS REQUIRED FOR PERFORMANCE OF WORK UNDER THIS CONTRACT. EXISTING CEILINGS SHALL BE REMOVED IN A MANNER TO AVOID DAMAGE TO THE CEILING COMPONENTS. STORAGE OF CEILING COMPONENTS UNTIL REINSTALLATION IS THE RESPONSIBILITY OF THE CONTRACTOR. ANY CEILING SYSTEM COMPONENTS DAMAGED DURING REMOVAL, STORAGE, OR INSTALLATION SHALL BE REPLACED WITH NEW TO MATCH EXISTING AT NO EXPENSE TO THE OWNER.

GENERAL LIGHTING AND POWER NOTES:

- A. THE CIRCUIT NUMBERS WHERE SHOWN ON DRAWINGS ARE FOR CIRCUITING INFORMATION ONLY. CONTRACTOR SHALL CONNECT LIGHTING OR RECEPTACLE CIRCUITS TO AVAILABLE CIRCUIT
- BREAKERS AS PRACTICABLE. B. CONTRACTOR SHALL BALANCE LOADS ON THE PANEL AS CLOSELY AS POSSIBLE. CORRECT CIRCUIT DESIGNATIONS SHALL BE INDICATED ON PANEL DIRECTORY AND ON "AS-BUILT" DRAWINGS. EXIT SIGNS SHALL BE CONNECTED TO SEPARATE EXIT LIGHT CIRCUIT WITH #10 AWG WIRES AND
- LUMINAIRES IDENTIFIED AS NIGHT LIGHTS SHALL BE UNSWITCHED, UNLESS OTHERWISE INDICATED. CONNECT BATTERY EMERGENCY LIGHTS TO UNSWITCHED PORTION OF NORMAL LIGHTING CIRCUITS.
- AT EXISTING SWITCH LOCATIONS WHERE MORE NEW SWITCHES ARE SHOWN THAN GANGS IN EXISTING DEVICE BACKBOX THE CONTRACTOR SHALL REMOVE THE EXISTING DEVICE BOX, ENLARGE
- OPENING, PROVIDE LARGER DEVICE BOX TO ACCEPT NEW SWITCHES ONE SWITCH PER GANG. G. APPROVED WIRING DEVICE MANUFACTURERS INCLUDE BUT ARE NOT LIMITED TO: HUBBELL, LEVITON, LEGRAND (PASS AND SEYMOUR) AND EATON (ARROW HART).

PANELBOARDS AND ENCLOSED BREAKERS:

- A. FURNISH AND INSTALL PANELBOARDS AS INDICATED ON PLANS. PANELS SHALL BE UL LISTED AND
- PANELS SHALL HAVE BOLT-ON CIRCUIT BREAKERS WITH INVERSE TIME MAGNETIC TRIP ELEMENT. CIRCUIT BREAKERS SHALL COMPLY WITH UL 489. INTERRUPTING CAPACITY SHALL BE RATED FOR AVAILABLE
- GFCI CIRCUIT BREAKERS SHALL HAVE SINGLE AND DOUBLE-POLE CONFIGURATIONS WITH CLASS A GROUND FAULT PROTECTION (6 mA TRIP).
- SHUNT TRIP CIRCUIT BREAKERS SHALL HAVE 120V TRIP COIL SET TO TRIP AT 75% OF RATED VOLTAGE. MOUNT RECESSED PANELS WITH FRONT UNIFORMLY FLUSH WITH WALL FINISH AND MATING WITH BACKBOX
- PROVIDE DIRECTORY CARD INSIDE PANELBOARD DOOR, MOUNTED IN METAL FRAME WITH TRANSPARENT PROTECTIVE COVER.
- H. APPROVED MANUFACTURERS INCLUDE EATON, SQUARE D AND SIEMENS. ELECTRONIC TRIP CIRCUIT BREAKERS SHALL BE FIELD-ADJUSTABLE WITH RMS SENSING INSTANTANEOUS, LONG, AND SHORT TIME PICKUP LEVELS.
- ENCLOSED SWITCHES AND CIRCUIT BREAKERS SHALL COMPLY WITH UL 489, UL 50, UL 50E AND NEMA KS 1. ENCLOSED CIRCUIT BREAKER OPERATING HANDLE MUST BE DIRECTLY OPERABLE THROUGH FRONT COVER OF
- ENCLOSURE (UL 50E TYPE 1). HANDLE SHALL BE LOCKABLE IN OFF POSITION. EQUIPMENT FINISHES SHALL BE GRAY BAKED ENAMEL PAINT, ELECTRODEPOSITED ON CLEANED PHOSPHATE

STEEL.

ELECTRICAL INSPECTIONS NOTES:

- A. ELECTRICAL INSPECTIONS SHALL BE PERFORMED BY A NYS QUALIFIED ELECTRICAL INSPECTOR. B. ELECTRICAL INSPECTOR SHALL BE ENGAGED BY THE OWNER (OR OWNER'S AGENT), AND NOT BY THE
- CONTRACTOR OR SUB-CONTRACTOR WHOSE WORK IS TO BE INSPECTED. C. ELECTRICAL INSPECTIONS SHALL BE PERFORMED FOR ALL ELECTRICAL WORK INCLUDING WORK THAT
- IS TO BE CONCEALED (I.E. UNDERGROUND , ROUGH-IN), IN PROGRESS WORK, AND THE FINAL INSPECTION.
- D. ELECTRICAL INSPECTOR SHALL SUBMIT DETAILED INSPECTION REPORTS SUBSEQUENT TO EACH INSPECTION.
- E. ELECTRICAL INSPECTOR SHALL SUBMIT A FINAL CERTIFICATE OF INSPECTION UPON COMPLETION OF CONSTRUCTION.

- ELECTRICAL CONTRACTOR SHALL BE RESPONSIBLE FOR MAINTAINING OF FIRE-RATING OF ALL
- CONSTRUCTION AFFECTED BY INSTALLATION OF ELECTRICAL WORK.
- THIS CONTRACTOR SHALL BE RESPONSIBLE FOR INSTALLING FIRE-STOPPING SYSTEMS AT ALL NEW PENETRATIONS. PER MANUFACTURER'S INSTRUCTIONS.
- THIS CONTRACTOR SHALL PROVIDE ALL PATCHING AND INFILL OF WALL/ FLOOR/ ROOF SYSTEMS REQUIRED FOR PROPER FIRE-STOP INSTALLATION TO MAINTAIN CONTINUITY OF EXISTING CONSTRUCTION.

TELECOMMUNICATIONS NOTES:

- HORIZONTAL CABLING SHALL COMPLY WITH TRANSMISSION STANDARDS IN TIA/EIA-568-B.1 PROVIDE CABLE TRAYS, CONDUITS AND SLEEVES AS REQUIRED. THE MAXIMUM ALLOWABLE CABLE LENGTH SHALL NOT EXCEED 295 FEET.
- C. ALL DATA AND LOW VOLTAGE CABLES ABOVE CEILING SHALL BE PLENUM RATED.
- D. PROVIDE UNSHIELDED CATEGORY 6 CABLES WITH MINIMUM 52V RATING AND RJ45 JACKS FOR ALL COMPUTER, PHONE AND PRINTER OUTLETS.
- E. DATA CABLES SHALL BE FACTORY TESTED FROM 1 MHZ TO 1 GHZ. MANUFACTURERS INCLUDE.
- BUT ARE NOT LIMITED TO: 3M, BELDEN, GENERAL CABLE, HUBBELL AND LEVITON. F. PROVIDE MODULAR NUMBERED PATCH PANELS WITH PUNCH DOWN CAPS FOR ALL UTP CABLES.
- PROVIDE IDC TYPE CONNECTORS FOR PERMANENT CONNECTION OF EACH DATA CABLE. ALL TERMINATIONS SHALL COMPLY WITH BICSI ITSIM STANDARDS. G. PROVIDE ALL JACKS AND JACK ASSEMBLIES WITH COLOR CODED IDC TYPE TERMINALS.
- PROVIDE 100 OHM, BALANCED, FOUR-PAIR, EIGHT POSITION MODULAR DATA JACKS.
- H. GROUNDING SHALL COMPLY WITH J-STD-607-A.

LIGHTING CONTROL SYSTEM:

- PROVIDE NEW LIGHTING CONTROL SYSTEM COMPLIANT WITH 2020 NYS ENERGY CONSERVATION CODE. BASIS OF DESIGN: WATTSTOPPER. ALTERNATE MANUFACTURERS INCLUDE SENSOR SWITCH INC., HUBBELL, NX CONTROLS AND SENSORWORX.
- ALL DEVICES SHALL BE HARDWIRED. WIRELESS CONTROLS ARE NOT PERMITTED.
- THE SYSTEM SHALL SUPPORT ETHERNET BASED LAN ON USER'S NETWORK.
- THE CONTRACTOR SHALL FURNISH AND INSTALL ALL DEVICES AND WIRING FOR A COMPLETE FUNCTIONING SYSTEM, INCLUDING BUT NOT LIMITED TO: SWITCH PACKS, ROOM CONTROLLERS, DIMMERS, OCCUPANCY/VACANCY SENSORS AND AMBIENT LIGHT SENSORS.
- LIGHTS WITH INTEGRAL DRIVERS SHALL USE 0-10V DIMMING. LIGHTS WITH 120V LAMPS SHALL USE
- FORWARD/REVERSE PHASE DIMMING. COORDINATE WITH MANUFACTURER'S REQUIREMENTS. CEILING-MOUNTED OCCUPANCY SENSORS SHALL HAVE A MINIMUM COVERAGE AREA OF 2000 SQ. FT.
- THE CONTRACTOR SHALL PROGRAM ALL DEVICES PER NYS ENERGY CODE.
- ADMINISTER AND PERFORM TESTS AND INSPECTIONS WITH ASSISTANCE OF A FACTORY-AUTHORIZED
- REPRESENTATIVE. PERFORM STARTUP AND INCLUDE TRAINING FOR OWNER'S REPRESENTATIVE. THE LIGHTING CONTROL SYSTEM SHALL HAVE A MINIMUM 2 YEAR WARRANTY.



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Client: LACTALIS

Project: OFFICE RENO AT 2376 SOUTH PARK

BUFFALO, NY 14220

Project Address: 2376 SOUTH PARK AVE

Drawing History: # Date Description

Project Number: 25042

Sheet Title: ELECTRICAL **SPECIFICATIONS**

HVAC SYMBOLS / ABBREVIATIONS LEGEND:

	NEW WORK	——⊗——	BALANCING VALVE
V()——	CHILLED WATER(S-SUPPLY, R-RETURN)	———	UNION
V()——	HOT WATER(S-SUPPLY, R-RETURN)		STRAINER
C()——	HOT/CHILLED WATER(S-SUPPLY, R-RETURN)		STRAINER, BLOW OFF
D	CONDENSATE DRAIN	<u> </u>	AIR VENT
	CAP	φ 🔊	AIIVENT
_	RISE		PRESSURE GAUGE
	DROP	_++_	
—	TEE - OUTLET UP		EXPANSION LOOP
	TEE - OUTLET DOWN	<u>P av</u>	AUTOMATIC AIR VENT
ţ	BRANCH - TOP CONNECTION	\H ^{MV}	MANUAL AIR VENT
<u> </u>	BRANCH - BOTTOM CONNECTION	$\bigcap_{\mathbf{I}}$	
<u> </u>	BRANCH - SIDE CONNECTION	⊢ ∑ †	AIR SEPARATOR
\leftarrow	ANCHOR	₽FS	
-	EXPANSION JOINT		FLOW SWITCH
	PIPE GUIDE		THERMOMETER
 г.	FLOW - IN DIRECTION OF ARROW		
<u> </u>	BALL VALVE	FD	FLOOR DRAIN
<u> </u>	BUTTERFLY VALVE	T	THERMOSTAT
5	PLUG VALVE	\bigcirc_{D}	TEMPERATURE SENSOR (DUCT)
PS	PRESSURE SWITCH		TEMPERATURE CONTROLLER
		SD	SMOKE DETECTOR
>	PUMP (INDICATE USE)	_	045
ከ	UNIT HEATER	C	CAP POINT OF REMOVAL
ľ		R P	POINT OF REMOVAL POINT OF CONNECTION
	MOTOR OPERATED DAMPER		SUPPLY DIFFUSER (CEILING)
E OR P			RETURN / EXHAUST GRILLE(CEILING)
_			DUCT SECTION, POSITIVE PRESSURE
SRV-1	ROOF VENTILATOR, INTAKE		
ERV-1	ROOF VENTILATOR, EXHAUST		DUCT SECTION, NEGATIVE PRESSURE
			DIRECTION OF FLOW
	ROOF VENTILATOR, LOUVERED		DUCT SIZE
		$\begin{array}{c} \\ \\ \end{array}$	CHANGE OF ELEVATION
IR OUTLE	T / INLET SYMBOL		ACCESS DOOR
CFM	600 CFM	<u> </u>	ACOUSTICAL LINING
	SD - 1 8"		BACK DRAFT DAMPER
DEVI	ICE SIZE		VERTICAL POSTITION FIRE DAMPER
	\ TYPE		
	THREE WAY VALVE	<u>} □ </u>	HORZONTAL POSTITION DAMPER
	GATE VALVE	7 1	MANUAL VOLUME DAMPER
√	VALVE		MANUAL SPLITTER DAMPER
\triangleleft TD	TRIPLE DUTY VALVE		SMOKE DAMPER
	GLOBE VALVE		
Д́—	2-WAY CONTROL VALVE		STANDARD BRANCH (S-SUPPLY, R-RETURN)
	CHECK VALVE		LINEAR DIFFUSER
⋛—	PRESSURE REDUCING VALVE	T	ENAL III DIII OOLI
<u></u>	RELIEF VALVE		TRANSITION
₩ <u></u>	FLEXIBLE CONNECTION		TURNING VANES
ш <u></u> Птті			

EF, EXF EG ER ET FC FD FR GPM HUH HWP HWR HWS LRR LSR	ACCESS DOOR ABOVE FINISHED FLOOR AIR HANDLING UNIT AIR INTAKE AIR SEPARATOR AIR VENT BALANCING DAMPER BACKDRAFT DAMPER BACK FLOW PREVENTOR CONDENSATE DRAIN CUBIC FEET PER MINUTE CEILING CABINET UNIT HEATER COLD WATER CHILLED WATER PUMP EXHAUST FAN EXHAUST GRILLE EXHAUST REGISTER EXPANSION TANK FAN COIL FIRE DAMPER FINNED TUBE RADIATION GALLONS PER MINUTE HORIZONTAL UNIT HEATER HOT WATER PUMP HOT WATER RETURN HOT WATER RETURN HOT WATER SUPPLY LINEAR RETURN REGISTER 1,000 BRITISH THERMAL UNITS (C-COOLING, H-HEATING) MOTOR OPERATED DAMPER
NC NO OED	NORMALLY CLOSED NORMALLY OPENED OPEN END DUCT
P PF	SYSTEM PUMP PROPELLER FAN
PRV	PRESSURE REGULATING VALVE
RD RF	RETURN DIFFUSER ROOF FAN
RG	RETURN GRILLE
RR RV	RETURN REGISTER RELIEF VENT
SR	SUPPLY REGISTER
SHWP SD	SECONDARY HOT WATER PUMP SUPPLY DIFFUSER
TC	TEMPERATURE CONTROL
TG TYP	TRANSFER GRILLE TYPICAL
TV	TURNING VANES
UH WC	UNIT HEATER WATER CHILLER
VD	VOLUME DAMPER

						MODEL		003 - ROW 003	3 - ROW 003 - ROW
						NOTES:	1	1	
				REGISTE	R / DIFFUSE	R SCHEDUL	_E		
UNIT NO.		SD-1	SD-2	SD-3	RD-1	RD-2	RG-1	RG-2	EG-1
SERVICE		SUPPLY DIFFUSER	SUPPLY DIFFUSER	SUPPLY DIFFUSER	RETURN DIFFUSER	RETURN DIFFUSER	RETURN AIR	RETURN AIR	EXHAUST GRILLE
NECK SIZE		AS TAGGED							
FACE		12"X12"	24"x24"	24"X24"	12"X12"	24"X24"	12"X10"	18"X10"	10"x10"
DAMPER		YES	NO						
MOUNTING	DUCT			X			Х	Х	
	WALL								
	CEILING	X	X		X	X			X
	FLOOR								
CONSTRUCTION	FRAME	STEEL	STEEL	STEEL	ALUMINUM	ALUMINUM	ALUMINUM	ALUMINUM	ALUMINUM
	CORE	STEEL	STEEL	STEEL	ALUMINUM	ALUMINUM	HORIZONTAL BARS	HORIZONTAL BARS	STEEL
	FINISH	BY ARCH							
MAKE	•	PRICE							
MODEL		SPD	SPD	SCD	PDDR	PDDR	SDG-10-12X12	SDG-10-18X12	530 - RETURN
•									

PANEL MOUNT

390 CFM

585 CFM

PANEL MOUNT

SPACE

SIZE / CFM FAMILY

@180F EWT EWT / LWT

MOUNTING

HEATING CAPACITY (BTUH)

HOT WATER UNIT HEATER

UH-2

SOUTH ENTRANCE

003 / ~330

22,400

180 F / 160 F

2.0

CEILING MOUNTED

UH-3

NORTH ENTRANCE

003 / ~330

22,400

180 F / 160 F

2.0

CEILING MOUNTED

MODINE

45° DEFLECTION - $\frac{3}{4}$ " BLADE SPACING

UH-1

VESTIBULE / MAIN ENTRANCE

003 / ~330

22,400

180 F / 160 F

2.0

WALL MOUNTED

MODINE

									H	ISTAW TC	R VAV SC	HEDULE									
UNIT	NO.	VAV-1	VAV-2	VAV-3	VAV-4	VAV-5	VAV-6	VAV-7	VAV-8	VAV-9	VAV-10	VAV-11	VAV-12	VAV-13	VAV-14	VAV-15	VAV-16	VAV-17	VAV-18	VAV-19	VAV-20
type	oe e	Single Duct	Single Duct	Single Duct	Single Duct	Single Duct	Single Duct	Single Duct	Single Duct	Single Duct	Single Duct	Single Duct	Single Duct	Single Duct	Single Duct	Single Duct	Single Duct	Single Duct	Single Duct	Single Duct	Single Duct
SIZ	ΖE	6	5	6	5	7	4	4	5	4	6	6	4	5	5	4	5	4	4	5	7
AIRFLOW	MIN.	135	95	80	125	100	90	130	80	80	80	80	80	80	180	80	85	85	70	100	200
CAPACITY	MAX.	400	250	400	250	550	150	150	250	150	400	400	150	250	•	150	250	150	150	250	550
	DESIGN	280	210	340	235	500	150	145	180	120	260	310	110	160	200	95	170	100	100	250	420
MIN. ΔPs	(in.w.g.)	0.14	0.01	0.14	0.01	0.07	0.01	0.01	0.01	0.01	0.14	0.14	0.01	0.01	0.01	0.01	0.01	0.01	0.01	0.01	0.07
COIL T	TYPE	2 ROW HW	2 ROW HW	2 ROW HW	2 ROW HW	2 ROW HW	2 ROW HW	2 ROW HW	2 ROW HW	2 ROW HW	2 ROW HW	2 ROW HW	2 ROW HW	2 ROW HW	2 ROW HW	2 ROW HW	2 ROW HW	2 ROW HW	2 ROW HW	2 ROW HW	2 ROW HW
REHEAT COIL (DESIGN		6,500 BTUH	5,000 BTUH	7,500 BTUH	5,500 BTUH	11,000 BTUH	3,500 BTUH	3,500 BTUH	4,000 BTUH	3,000 BTUH	6,000 BTUH	7,000 BTUH	2,500 BTUH	3,500 BTUH	4,500 BTUH	2,500 BTUH	4,000 BTUH	2,500 BTUH	2,500 BTUH	5,500 BTUH	9,500 BTUH
DISCHARGE	ΔΡS	1.5	1.5	1.5	1.5	1.5	1.5	1.5	1.5	1.5	1.5	1.5	1.5	1.5	1.5	1.5	1.5	1.5	1.5	1.5	1.5
SOUND	NC	24	25	24	25	24	24	24	25	24	24	24	24	25	25	24	25	24	24	25	25
RADIATED	ΔPS	1.5	1.5	1.5	1.5	1.5	1.5	1.5	1.5	1.5	1.5	1.5	1.5	1.5	1.5	1.5	1.5	1.5	1.5	1.5	1.5
SOUND	NC	26	21	26	21	24	-	-	21	-	26	26	-	21	21	-	21	-	-	21	21
MAK	KE	PRICE	PRICE	PRICE	PRICE	PRICE	PRICE	PRICE	PRICE	PRICE	PRICE	PRICE	PRICE	PRICE	PRICE	PRICE	PRICE	PRICE	PRICE	PRICE	PRICE
MOD	DEL	SDV-6	SDV-5	SDV-6	SDV-5	SDV-7	SDV-4	SDV-4	SDV-5	SDV-4	SDV-6	SDV-6	SDV-4	SDV-5	SDV-5	SDV-4	SDV-5	SDV-4	SDV-4	SDV-5	SDV-7
ACCESS	SORIES	Motorized damper / Water reheat coil		Motorized damper / Water reheat coil	•			Motorized damper / Water reheat coil	•	•	•		Motorized damper / Water reheat coil		Motorized damper / Water reheat coil	ı		Motorized damper / Water reheat coil			
		NOTES:										+									

ACCESSORIES REMARKS

PANEL MOUNT

PANEL MOUNT

EXPOSED CEILING

INSTALLATION - HUNG



ARCHITECTS / ENGINEERS

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Client: LACTALIS AMERICAN GROUP

RENOVATIONS AT 2376 SOUTH PARK **AVENUE**


Project Address: 2376 SOUTH PARK AVENUE BUFFALO, NY 14220

Drawing History: # Date Description

Date: 11/06/2025

Project Number: 25042 Sheet Title: SYMBOLS, LEGEND,

& SCHEDULES

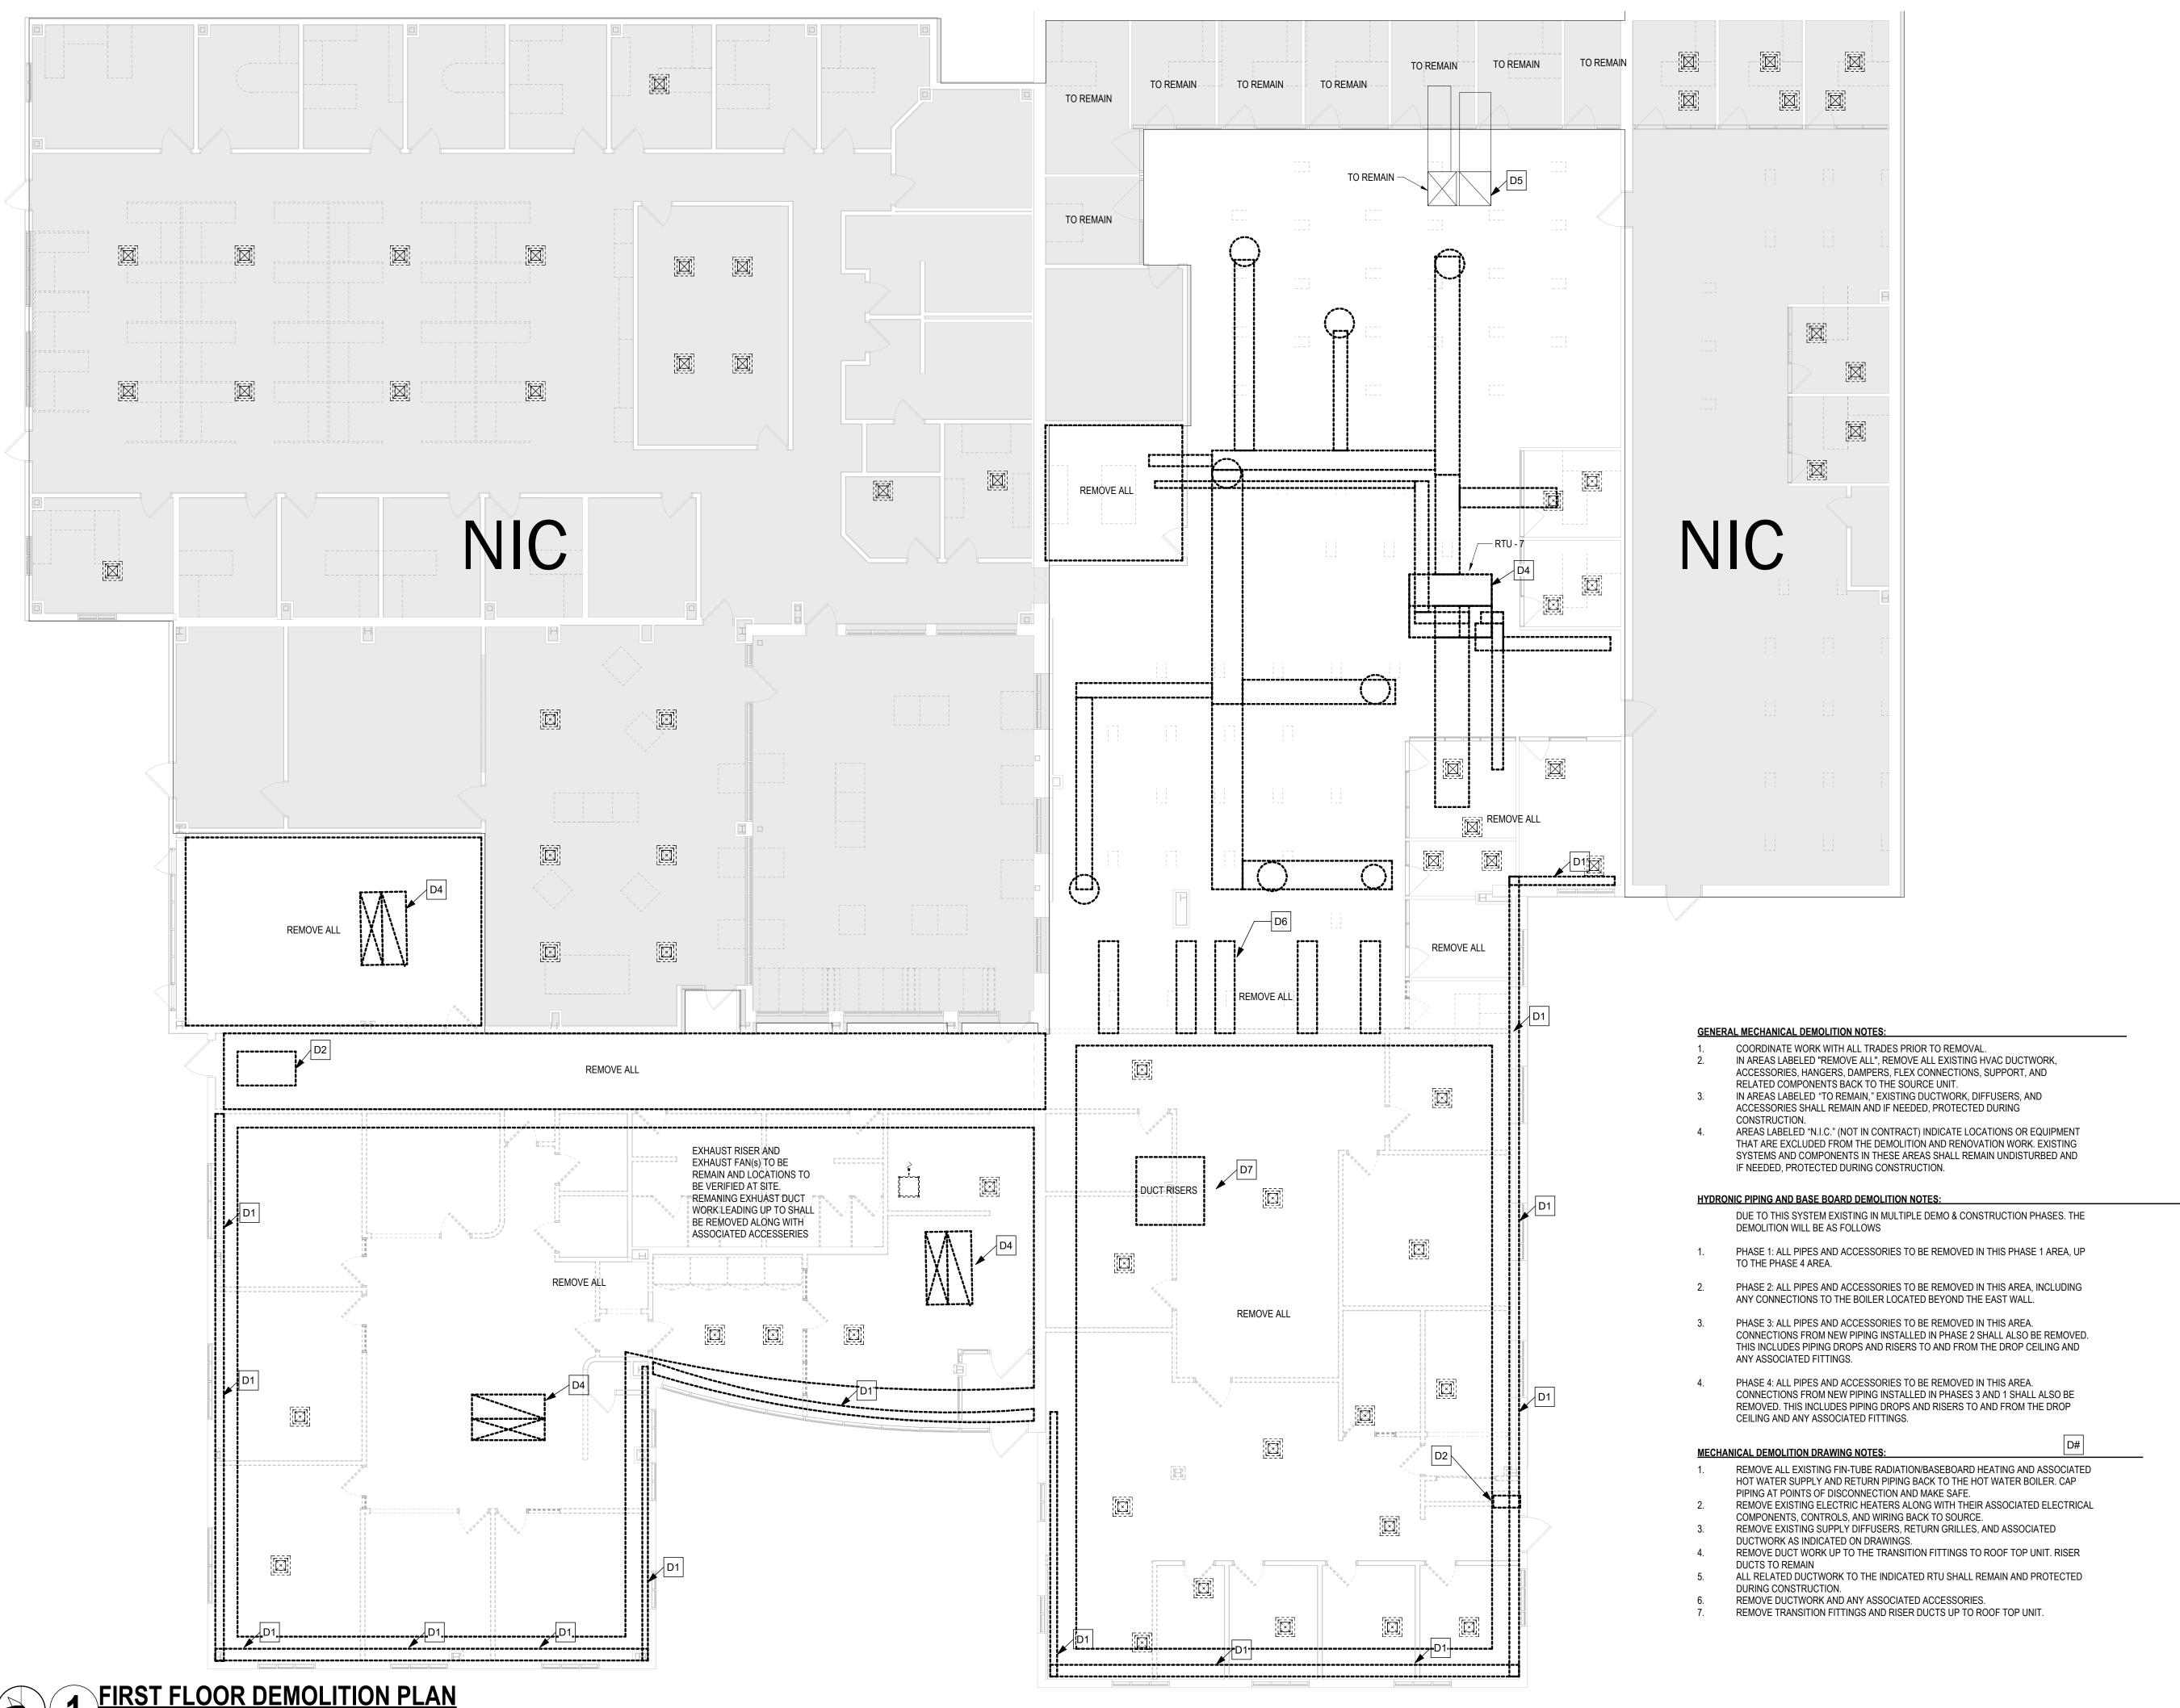



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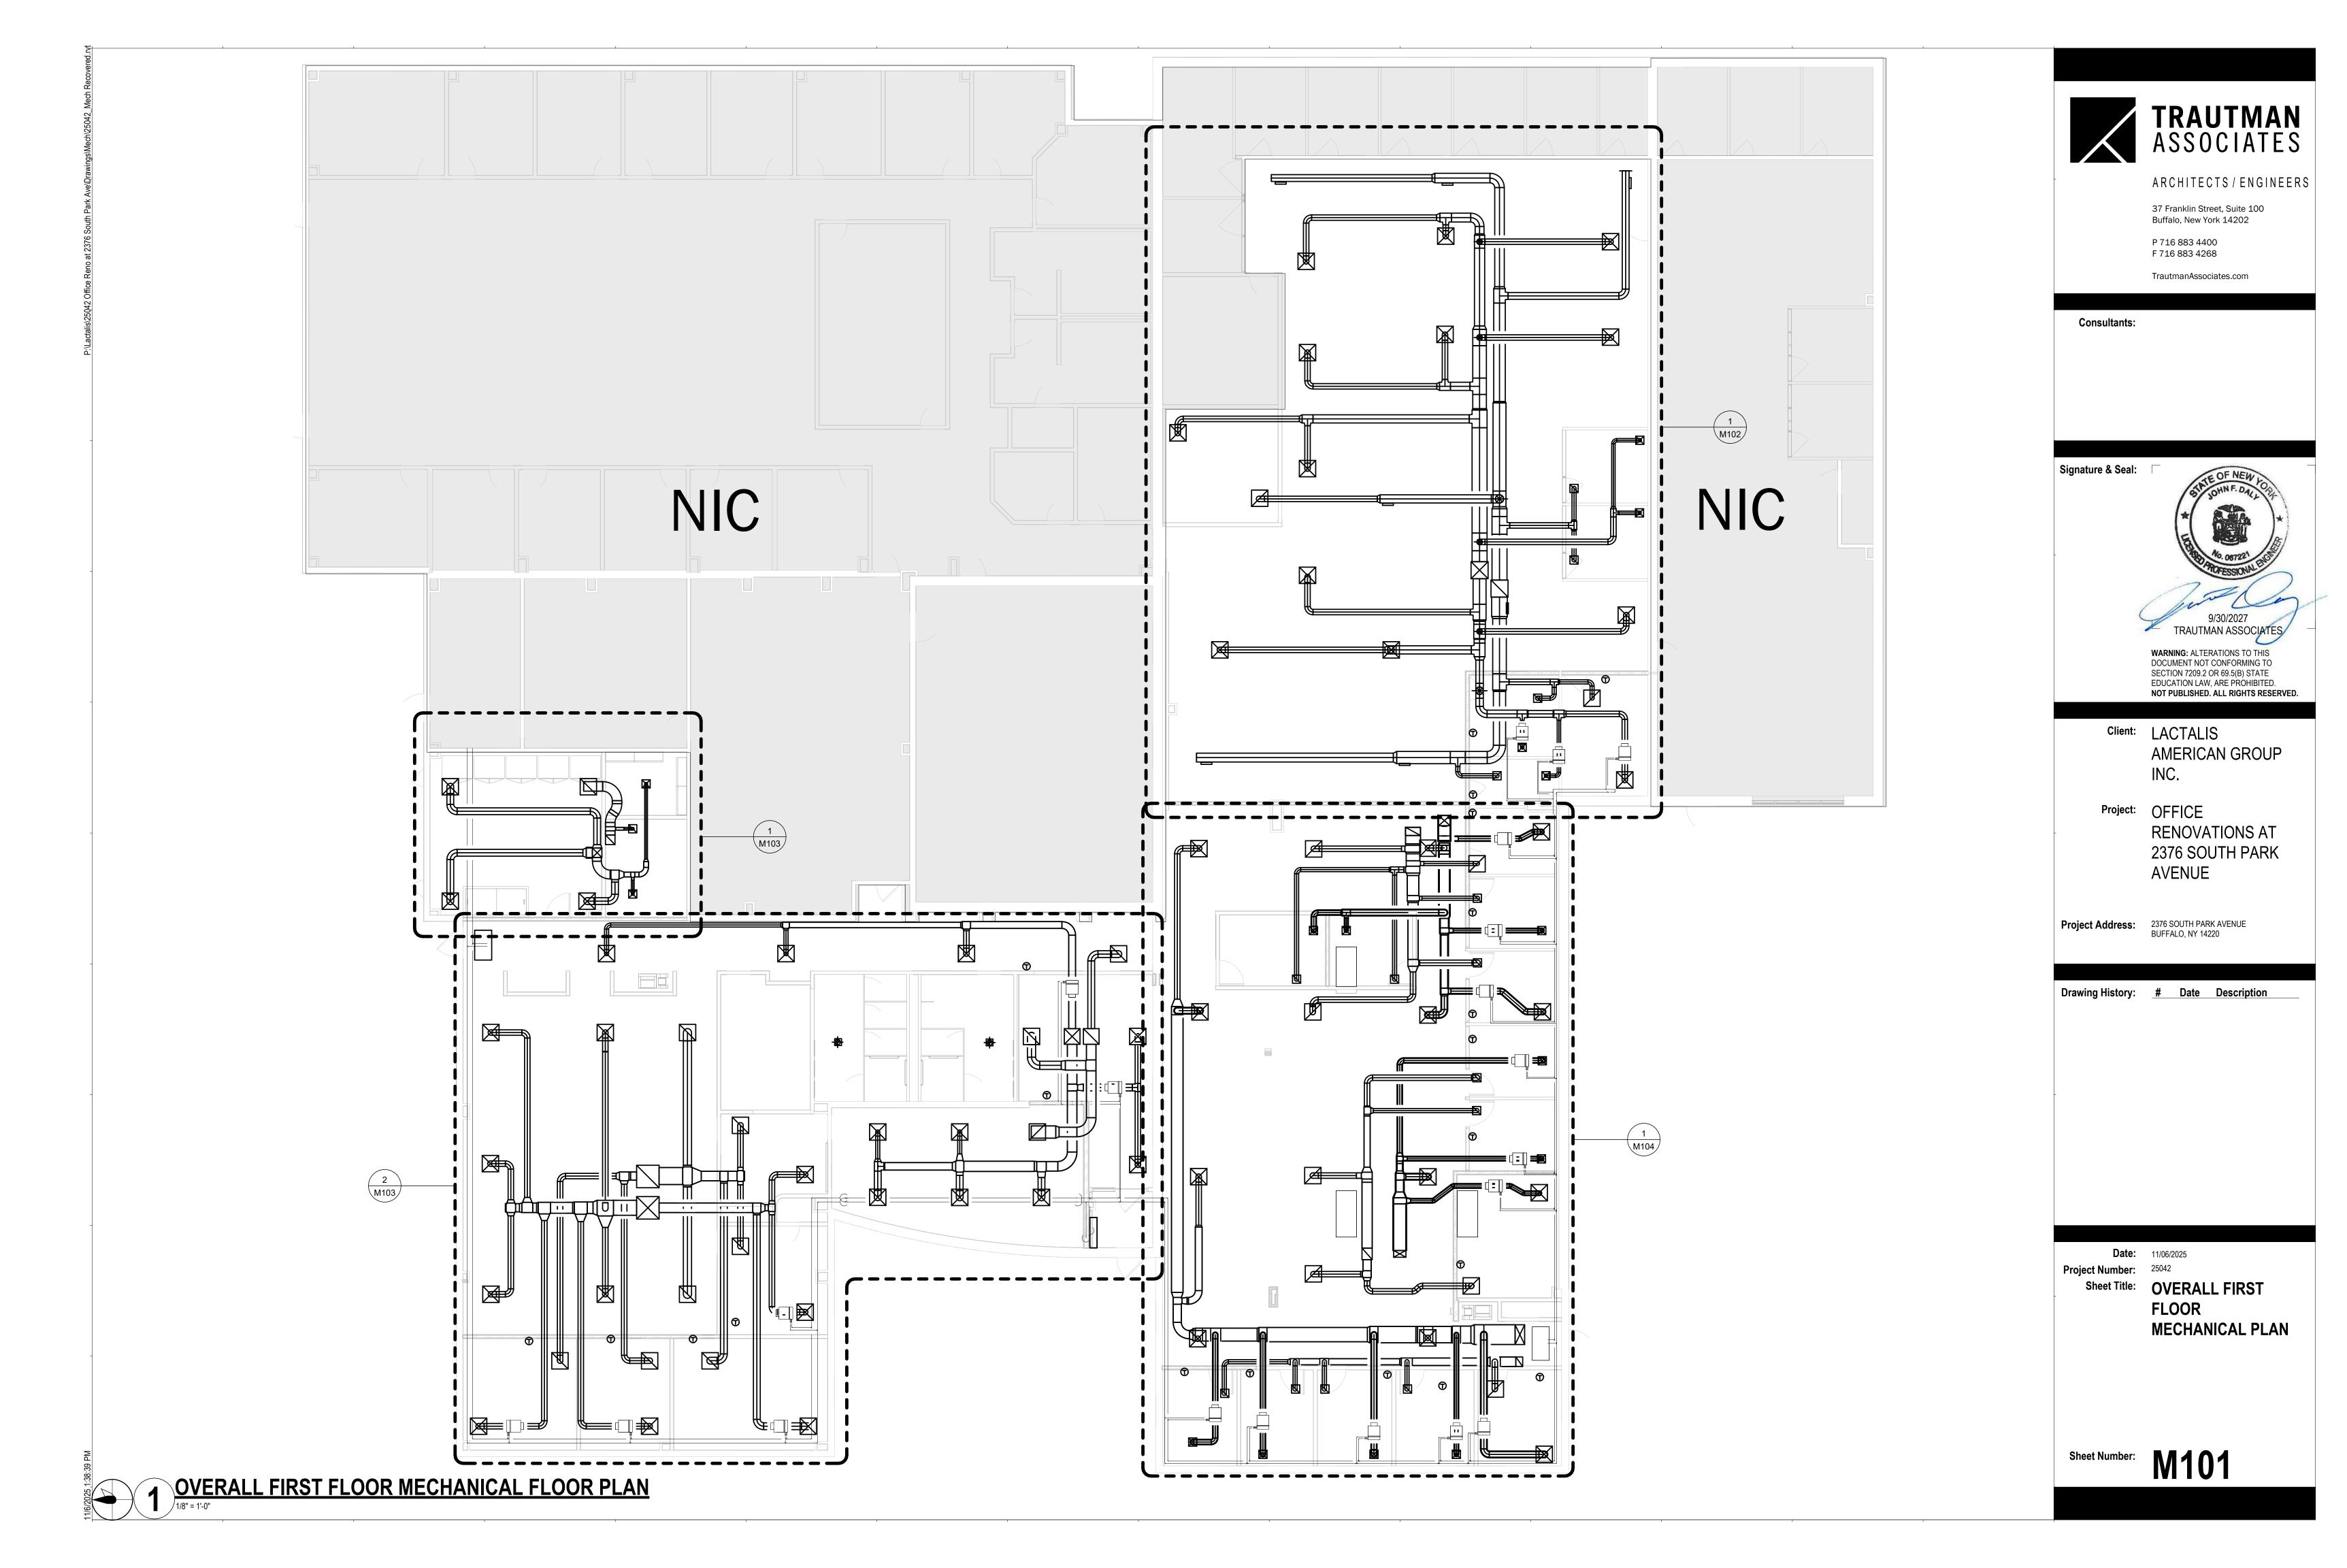
Project Number: 25042


Sheet Title: OVERALL FIRST

FLOOR MECHANICAL DEMOLITION PLAN

MD101

1 FIRST FLOOR DEMOLITION PLAN
1/8" = 1'-0"



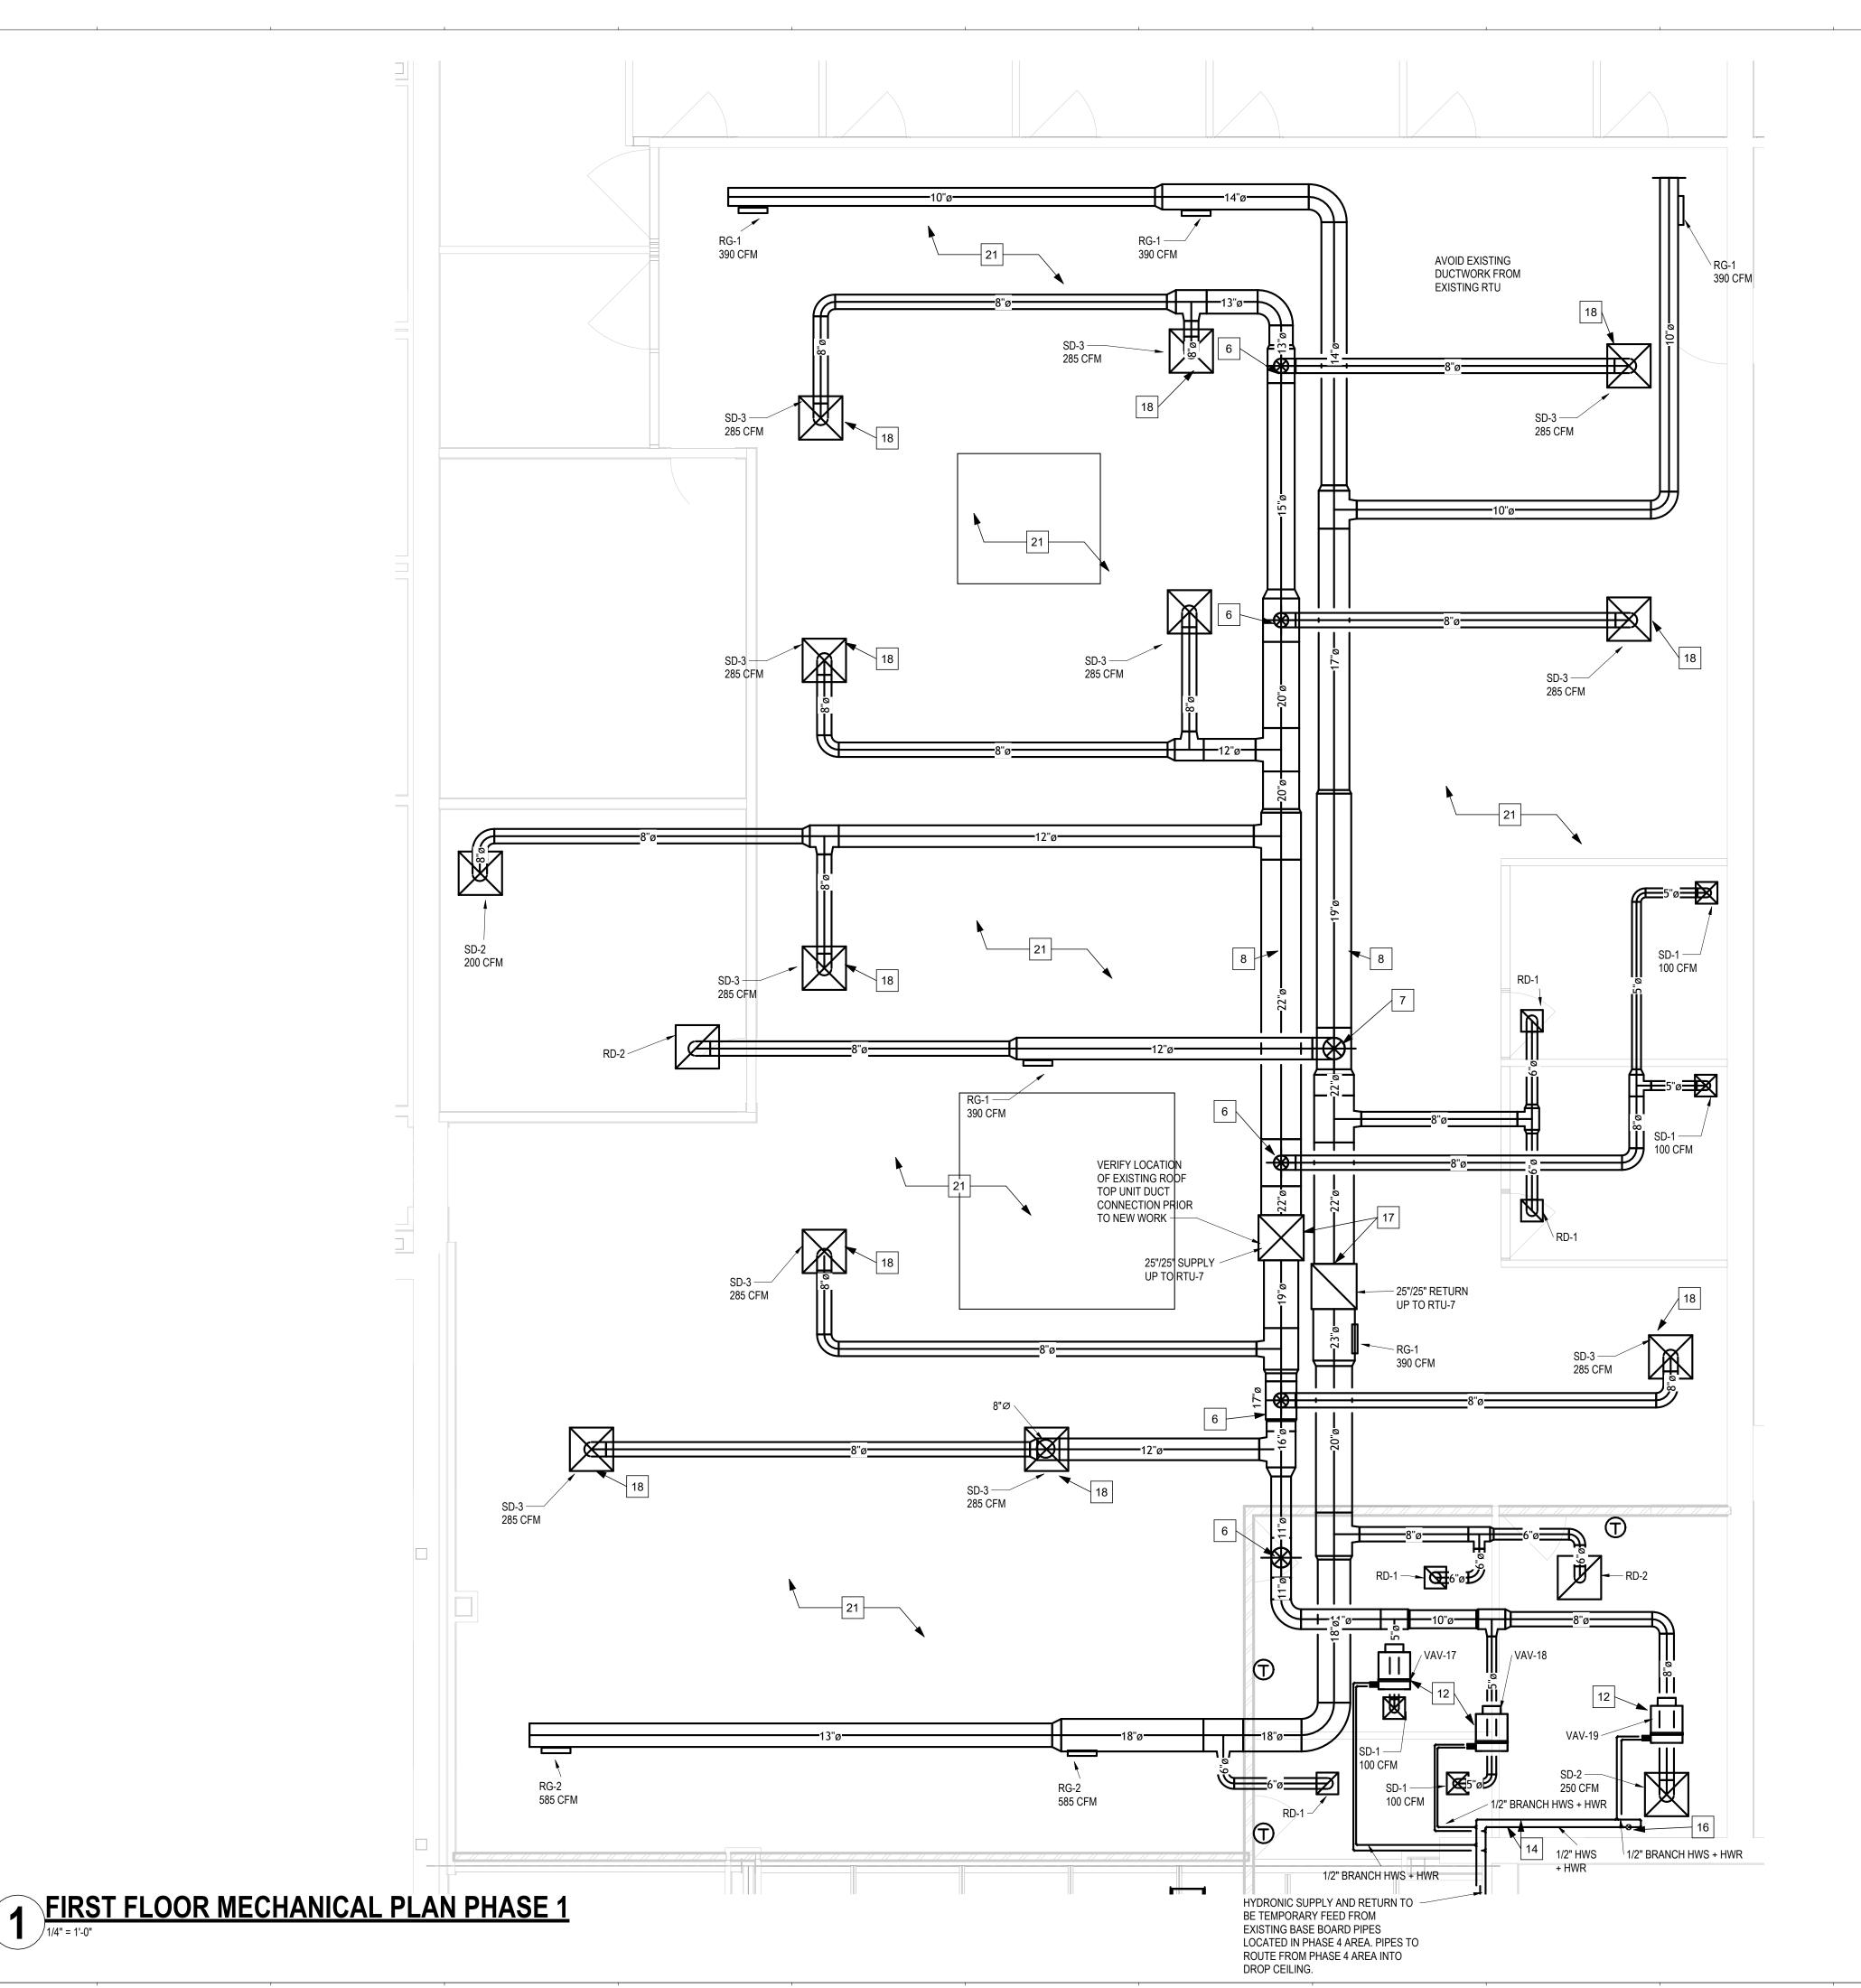



- COORDINATE WORK WITH ALL TRADES PRIOR TO INSTILLATION. ALL 90 DEGREE TRANSITIONS IN DUCTWORK TO BE PROVIDED TURNING VANES.
- PROVIDE VOLUME DAMPERS ON ALL DUCTWORK BRANCHES FOR BALANCING. INSTALL ALL UNITS PER MANUFACTURERS REQUIREMENTS.
- PROVIDE 1" THICK INSULATION ON ALL SUPPLY DUCTWORK. DIFFUSERS LOCATIONS TO AVOID LIGHTING FIXTURES, COORDINATE WITH LIGHTING FIXTURE INSTALLATION.

HYDRONIC PIPING FOR VAV REHEAT AND UNIT HEATERS CONSTRUCTION NOTES:

DUE TO THIS SYSTEM EXISTING IN MULTIPLE DEMO & CONSTRUCTION PHASES. THE CONSTRUCTION SHALL PROCEED AS FOLLOWS:

- PHASE 1: INSTALL HYDRONIC PIPING AS DIRECTED IN THE DRAWINGS. TIE INTO THE EXISTING FLOOR HYDRONIC PIPING FROM THE FIN-TUBE/BASEBOARD LOCATED IN
- PHASE 2: INSTALL HYDRONIC PIPING AS DEPICTED IN THE DRAWINGS UP TO THE BOILER. ADD NEW CONNECTIONS AND PIPING AS REQUIRED. TIE INTO THE EXISTING FLOOR PIPING FROM THE FIN-TUBE/BASEBOARD LOCATED IN PHASE 3.
- PHASE 3: INSTALL HYDRONIC PIPING AS DEPICTED IN THE DRAWINGS. TIE INTO THE NEW PIPING LOCATED IN THE DROP CEILING OF PHASE 2, AND ALSO TIE INTO THE EXISTING FIN-TUBE/BASEBOARD PIPING LOCATED ON THE PHASE 4 FLOOR LEVEL.
- PHASE 4: INSTALL HYDRONIC PIPING AS DEPICTED IN THE DRAWINGS. TIE INTO THE NEW PIPING LOCATED IN THE DROP CEILING OF PHASES 3 AND 1.

MECHANICAL DRAWING NOTES:

- HOT WATER HEATER TO BE PROVIDED WITH INTEGRAL THERMOSTATE, VALVE KIT
- ALL ROOF DUCTWORK DESIGNED AS THERMODUCT, CONTRACTOR MAY PROVIDE
- SUPPLY DIFFUSER TO BE INSTALLED BELOW MAIN DUCT AND SUPPLIED FROM A
- OVERLAPPING DUCTWORK MAY BE INSTALLED EITHER WAY SUPPLY OVER RETURN OR RETURN OVER SUPPLY, AS COORDINATED IN FIELD.
- SUPPLY BRANCHES OFF FROM ABOVE MAIN SUPPLY DUCT. RETURN BRANCHES OFF FROM ABOVE MAIN RETURN DUCT.
- ALL BRANCHES ON INDICATED DUCT MAY CONNECT FROM ABOVE, BELOW, OR SIDE AS COORDINATED IN FIELD.
- SUPPLY AND RETURN DROPS DUCTS WITHIN THEIR OWN RESPECTIVE JOIST SPACE. JOIST LOCATIONS TO BE VERIFIED AT SITE.
- DUCTWORK ROUTED BETWEEN JOISTS.

DUCTWORK PASSES THROUGH JOISTS.

- DUCTWORK ROUTED UNDERNEATH JOISTS.
- VAV FOR REHEAT CONTROL. PROVIDE WALL THERMOSTAT FOR VAV CONTROL. PIPING TO HAVE VALVE KIT WITH CONTROL VALVE. HYDRONIC SUPPLY AND RETURN
- TO BE TIED INTO VAV COIL FROM MAIN PIPES. COORDINATE ALL ROOF CUTTING, PATCHING, AND FLASHING WITH GENERAL
- CONTRACTOR FOR ALL ROOF PENETRATIONS. HYDRONIC SUPPLY AND RETURN PIPING SERVING VAV REHEAT COILS AND UNIT
- HEATERS. ROUTED IN DROP CEILINGS UNLESS NOTED OTHERWISE. SUPPLY & RETURN TO BE INSULATED PER CODE.
- CABINET UNIT HEATER FOR VESTIBULE HEAT, UNIT TO HAVE INTEGRAL THERMOSTAT, HEAT TO TURN ON WHEN SPACE IS BELOW 50 F, UNIT TO TURN OFF WHEN SPACE IS
- CIRCUIT SETTER FOR HYDRONIC SYSTEM CONTROL, COORDINATE WITH EXISTING BOILER & PUMP REQUIREMENTS.
- NEW SUPPLY AND RETURN DUCTWORK TO CONNECT TO EXISTING DUCT TRANSITION. SERVING RTU. PROVIDE TRANSITION FITTINGS AS REQUIRED BETWEEN DRAWING INDICATED DUCT RISER AND EXISTING RTU CONNECTION. CONNECTION LOCATIONS
- AND DIMENSIONS VERIFIED AT SITE. PROVIDE INTERNAL AIR SPLITTER OR TURING VEINS WITHIN THE SUPPLY PLENUM TO ALLOW SMOOTHER AIR SPLITTING. SUPPLY DIFFUSERS TO BE ELEVATED ON SAME LEVEL AS ACOUSTIC PANELS AND LOCATED BETWEEN THEM AS DEPICTED ON DRAWING. DIFFUSERS DUCT TO BE
- ROUTED SUCH THAT IT AVOIDS ACOUSTIC HANGERS. COORDINATE WITH ACOUSTIC PANEL INSTALLATION. DUCT WORK AND DIFFUSER PLACEMENT TO AVOID LIGHTING FIXTURES AND HANGERS, COORDINATE WITH LIGHTING INSTALLATION. BRANCH MAY GO ROUTE THROUGH JOISTS IF SPACE RESTRICTS OTHERWISE
- ALL SUPPLY DUCTWORK FROM INDICATED UNIT DESIGNED AS THERMODUCT, CONTRACTOR MAY PROVIDE EQUAL.
- ALL EXPOSED DUCT WORK, ACCESSORIES, AND DIFFUSERS TO AT PHASE 1 SHALL BE

LOCATIONS INSTALLATION.

DIFFUSERS TO AVOID LIGHTING FIXTURES, COORDINATE WITH LIGHTING FIXTURE

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AVENUE

RENOVATIONS AT 2376 SOUTH PARK


Project Address: 2376 SOUTH PARK AVENUE BUFFALO, NY 14220

Drawing History: # Date Description

Date: 11/06/2025

Project Number: 25042 Sheet Title: FIRST FLOOR **MECHANICAL PLAN**

- PHASE 1

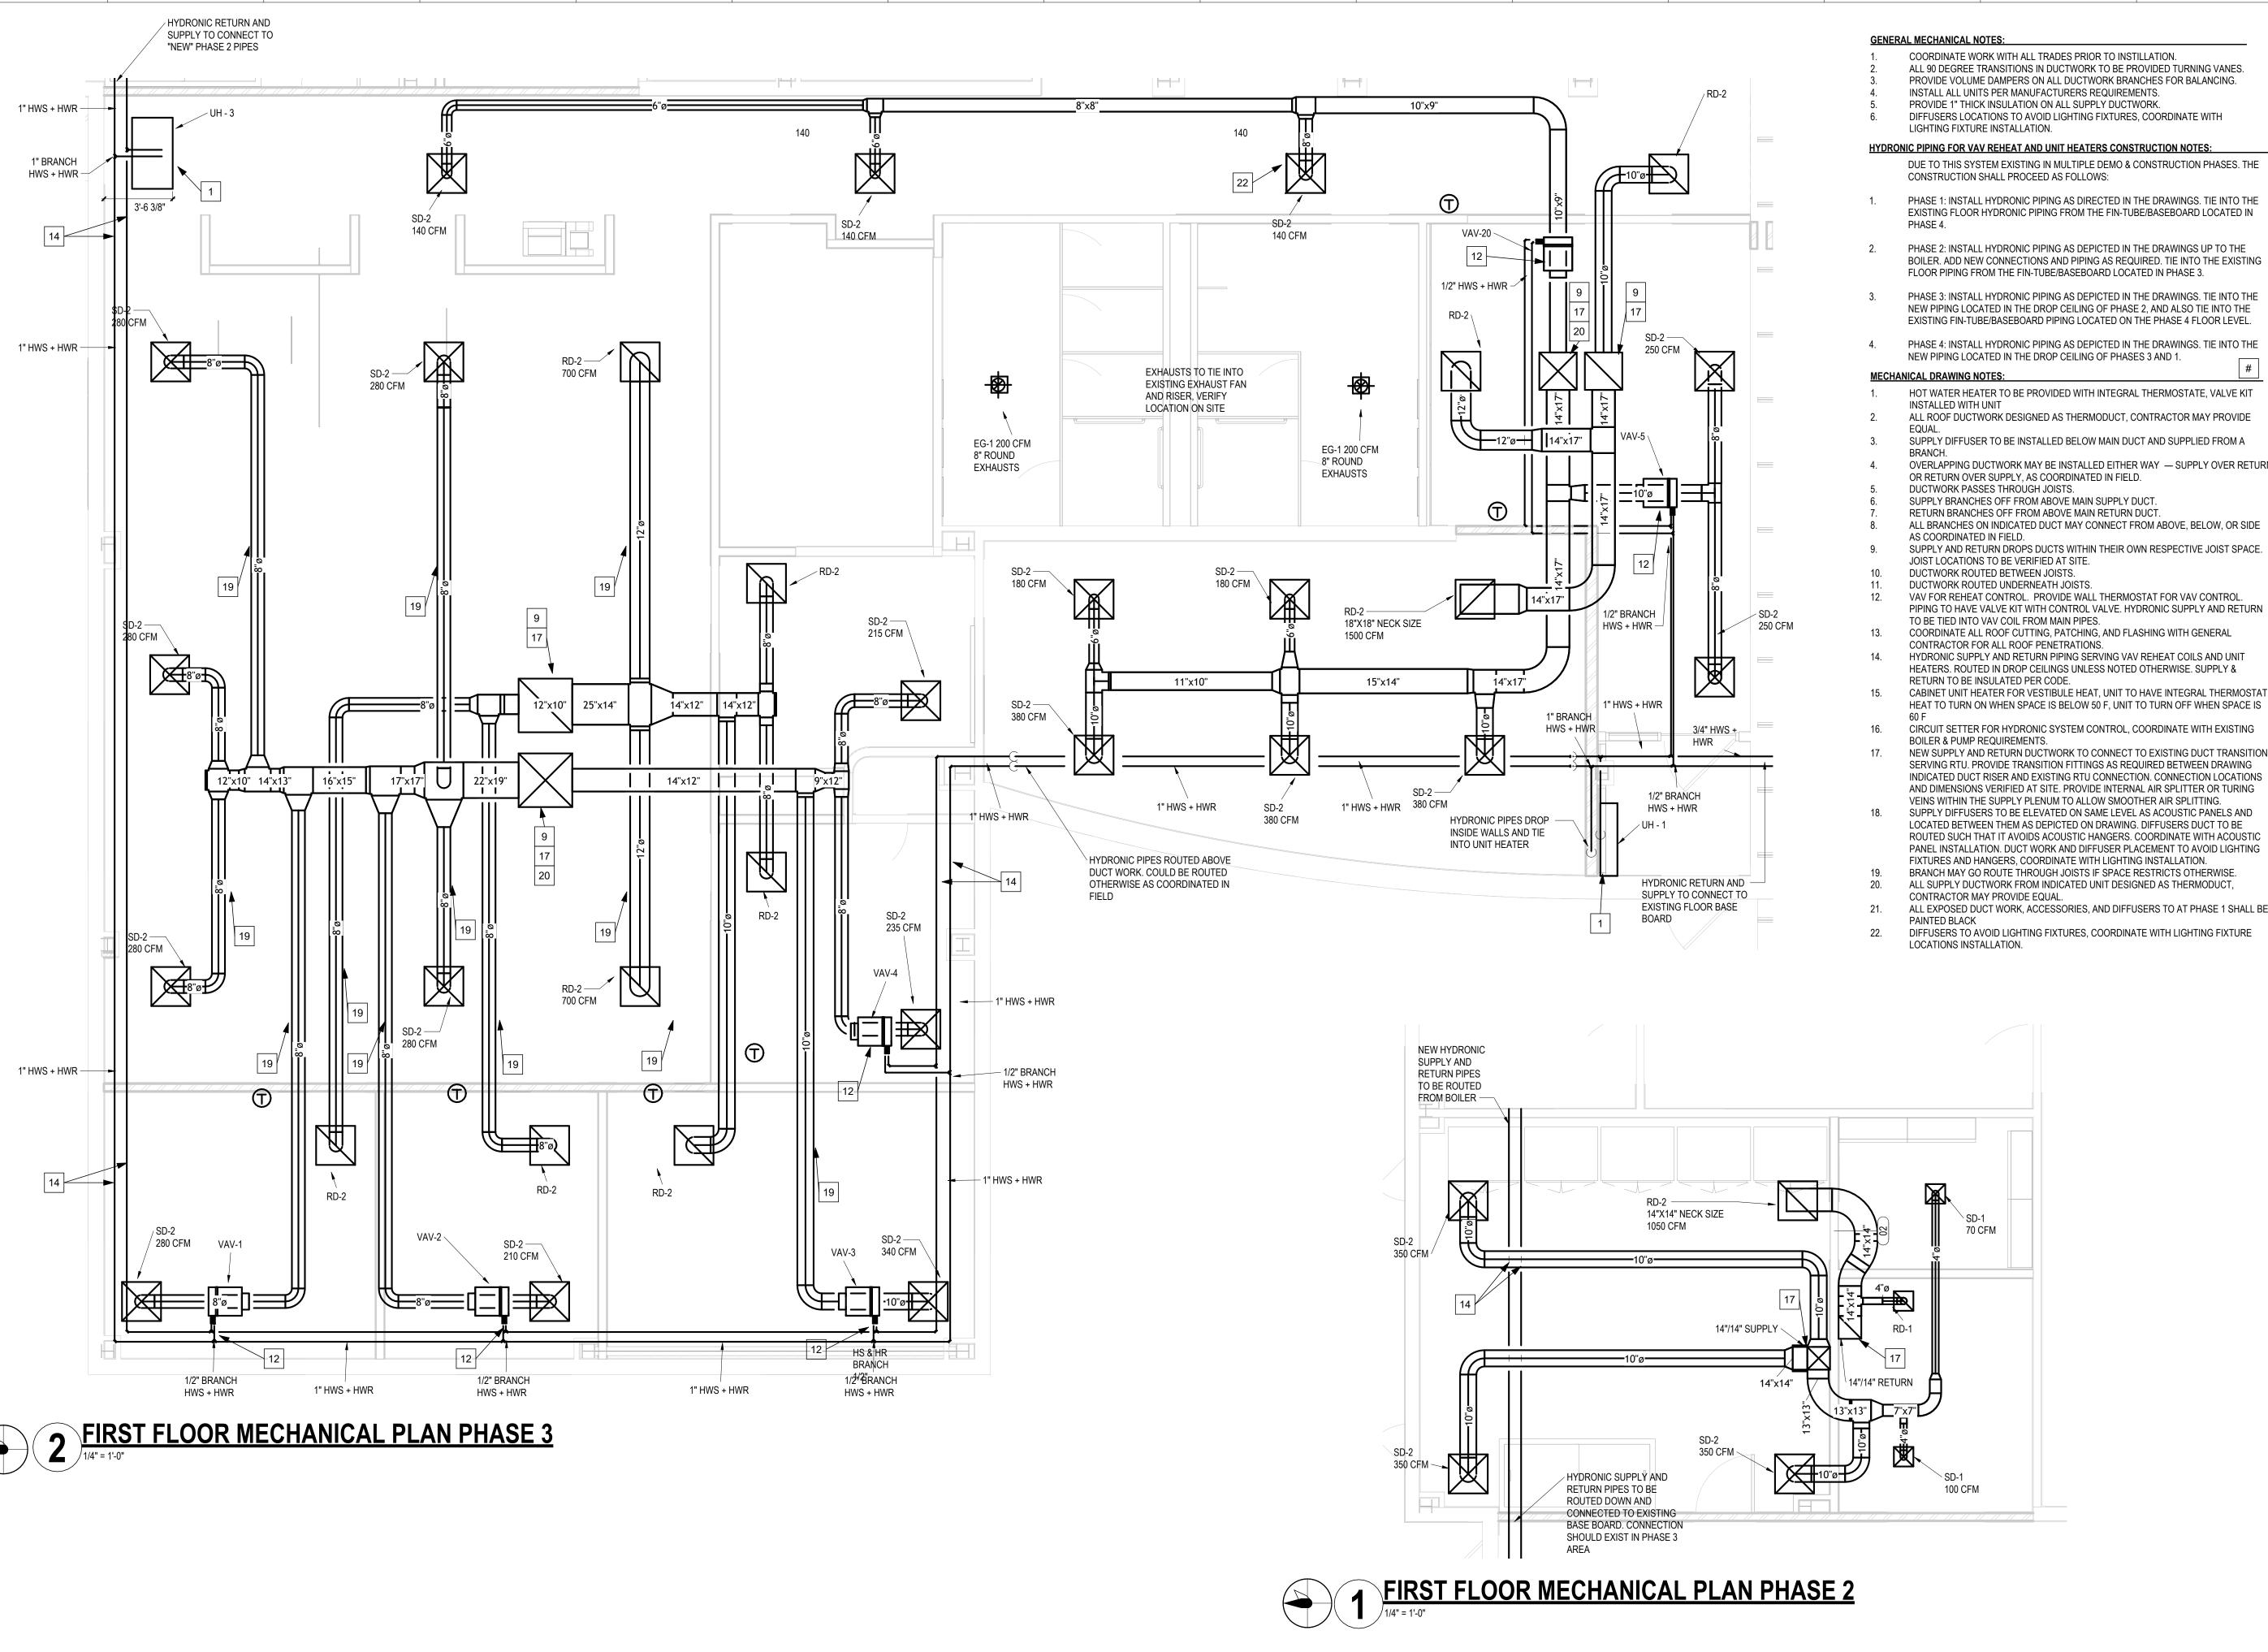

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PHASE 4: INSTALL HYDRONIC PIPING AS DEPICTED IN THE DRAWINGS. TIE INTO THE

- HOT WATER HEATER TO BE PROVIDED WITH INTEGRAL THERMOSTATE, VALVE KIT
- SUPPLY DIFFUSER TO BE INSTALLED BELOW MAIN DUCT AND SUPPLIED FROM A
- OVERLAPPING DUCTWORK MAY BE INSTALLED EITHER WAY SUPPLY OVER RETURN
- ALL BRANCHES ON INDICATED DUCT MAY CONNECT FROM ABOVE, BELOW, OR SIDE
- VAV FOR REHEAT CONTROL. PROVIDE WALL THERMOSTAT FOR VAV CONTROL. PIPING TO HAVE VALVE KIT WITH CONTROL VALVE. HYDRONIC SUPPLY AND RETURN
- HYDRONIC SUPPLY AND RETURN PIPING SERVING VAV REHEAT COILS AND UNIT HEATERS. ROUTED IN DROP CEILINGS UNLESS NOTED OTHERWISE. SUPPLY &
- CABINET UNIT HEATER FOR VESTIBULE HEAT, UNIT TO HAVE INTEGRAL THERMOSTAT,
- NEW SUPPLY AND RETURN DUCTWORK TO CONNECT TO EXISTING DUCT TRANSITION. SERVING RTU. PROVIDE TRANSITION FITTINGS AS REQUIRED BETWEEN DRAWING INDICATED DUCT RISER AND EXISTING RTU CONNECTION. CONNECTION LOCATIONS
- SUPPLY DIFFUSERS TO BE ELEVATED ON SAME LEVEL AS ACOUSTIC PANELS AND LOCATED BETWEEN THEM AS DEPICTED ON DRAWING. DIFFUSERS DUCT TO BE ROUTED SUCH THAT IT AVOIDS ACOUSTIC HANGERS. COORDINATE WITH ACOUSTIC PANEL INSTALLATION. DUCT WORK AND DIFFUSER PLACEMENT TO AVOID LIGHTING

- 21. ALL EXPOSED DUCT WORK, ACCESSORIES, AND DIFFUSERS TO AT PHASE 1 SHALL BE

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Client: LACTALIS AMERICAN GROUP

RENOVATIONS AT 2376 SOUTH PARK **AVENUE**


2376 SOUTH PARK AVENUE BUFFALO, NY 14220

Drawing History: # Date Description

Date: 11/06/2025

Sheet Title: FIRST FLOOR

MECHANICAL PLAN - PHASE 2 & 3

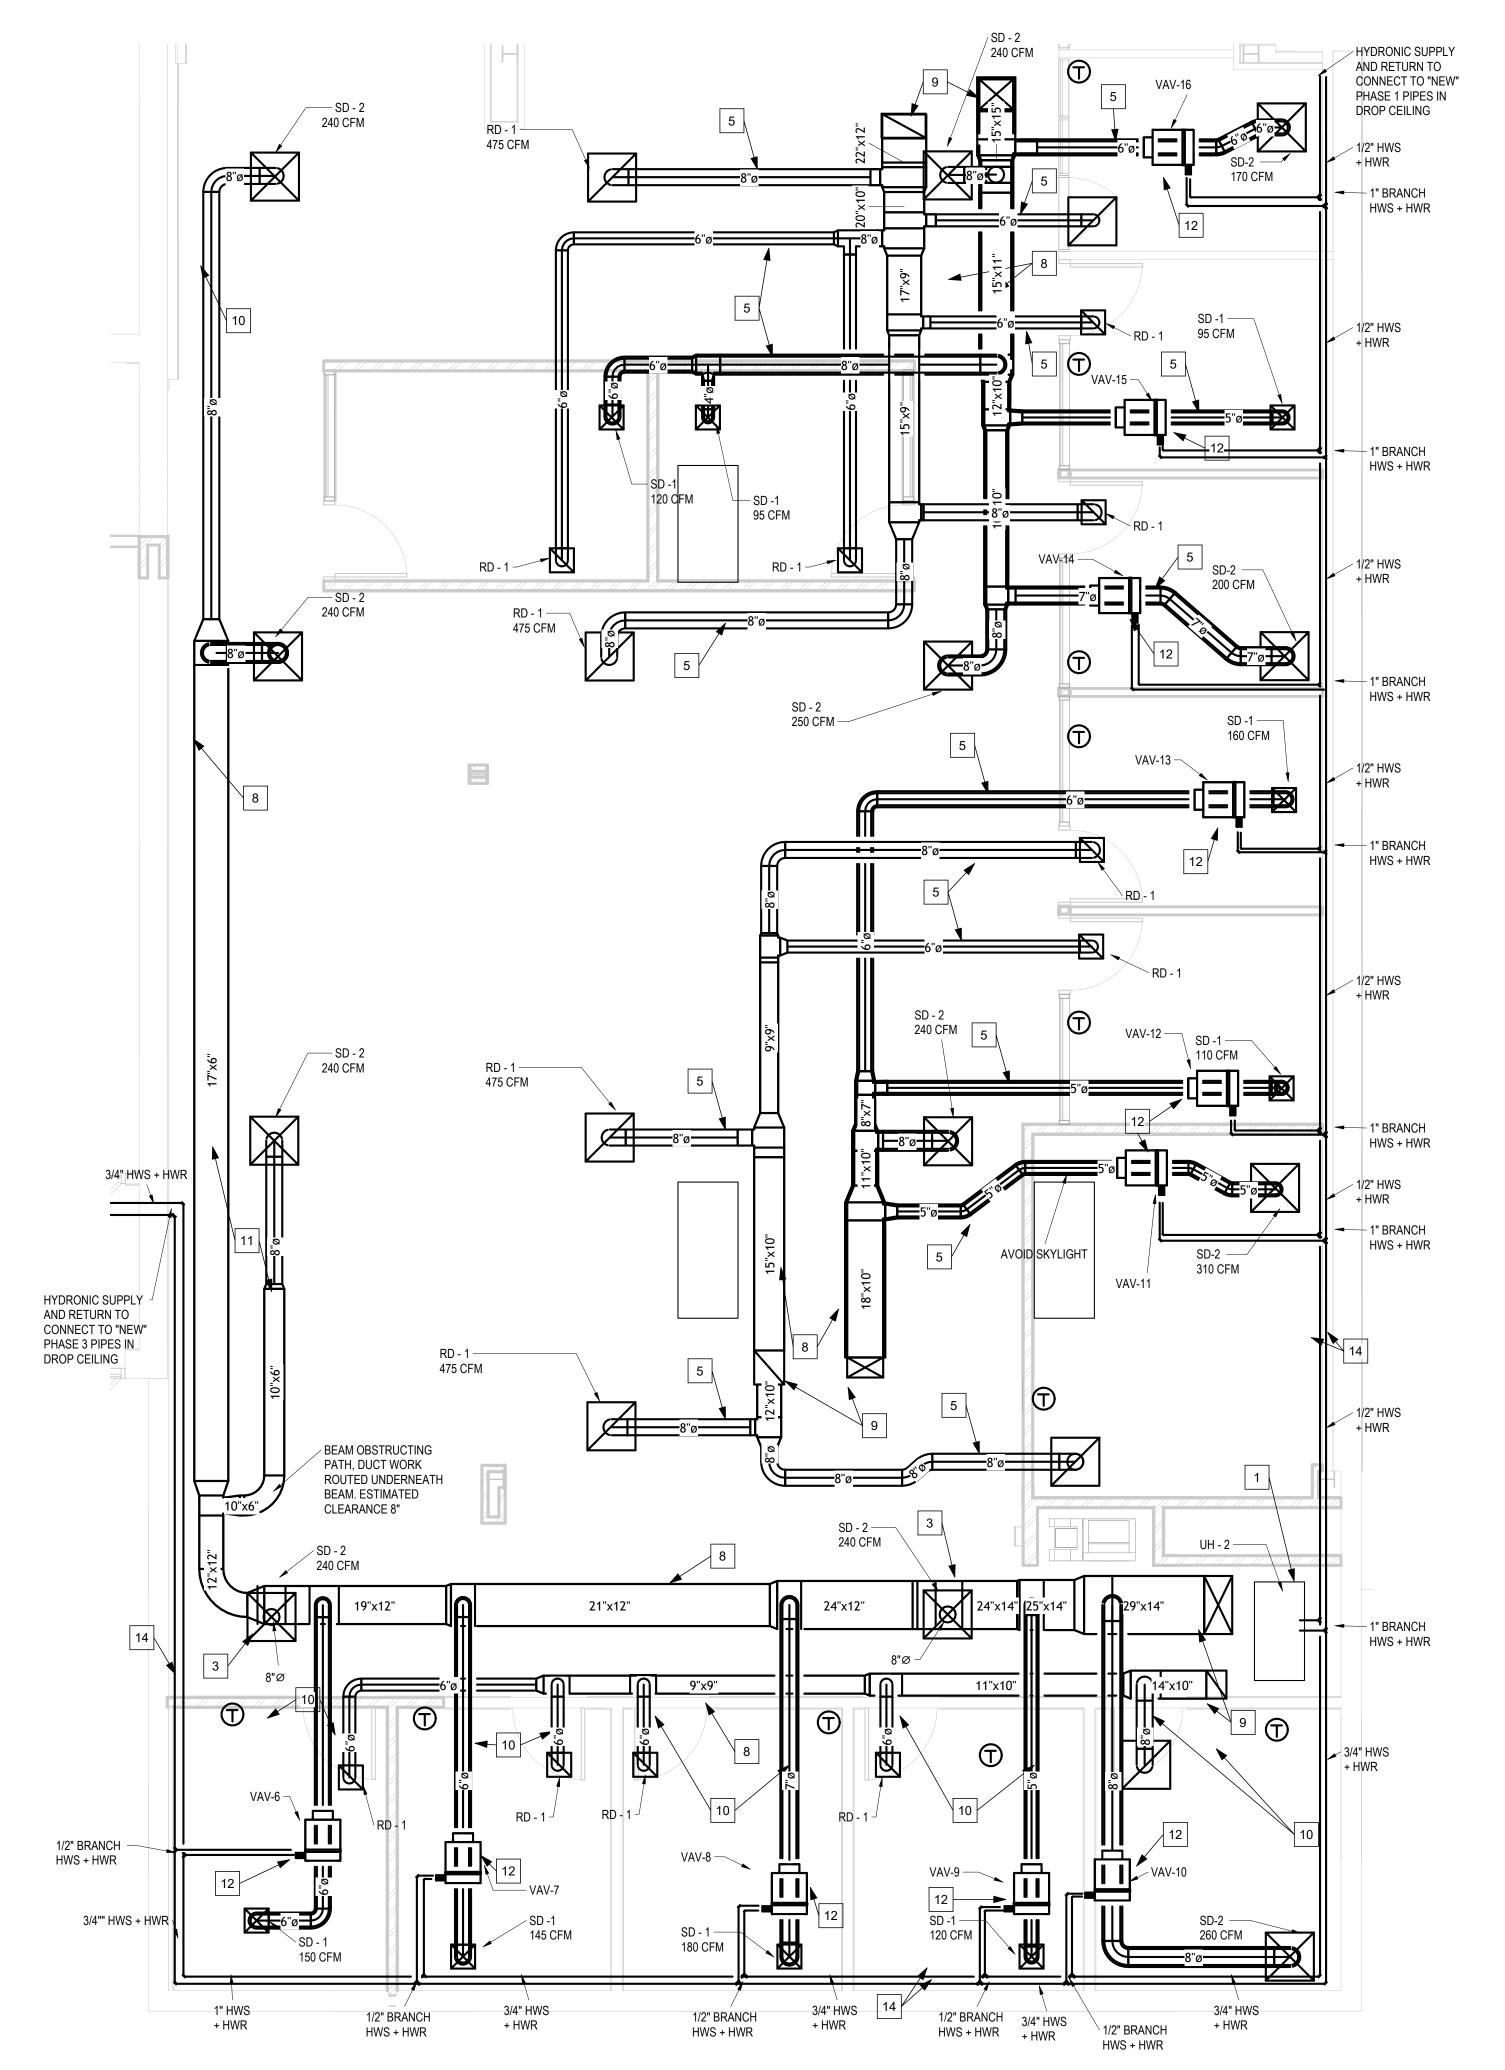

GENERAL MECHANICAL NOTES:

COORDINATE WORK WITH ALL TRADES PRIOR TO INSTILLATION. ALL 90 DEGREE TRANSITIONS IN DUCTWORK TO BE PROVIDED TURNING VANES. PROVIDE VOLUME DAMPERS ON ALL DUCTWORK BRANCHES FOR BALANCING.

INSTALL ALL UNITS PER MANUFACTURERS REQUIREMENTS. PROVIDE 1" THICK INSULATION ON ALL SUPPLY DUCTWORK.

DIFFUSERS LOCATIONS TO AVOID LIGHTING FIXTURES, COORDINATE WITH LIGHTING FIXTURE INSTALLATION.

HYDRONIC PIPING FOR VAV REHEAT AND UNIT HEATERS CONSTRUCTION NOTES: DUE TO THIS SYSTEM EXISTING IN MULTIPLE DEMO & CONSTRUCTION PHASES. THE CONSTRUCTION SHALL PROCEED AS FOLLOWS:

PHASE 1: INSTALL HYDRONIC PIPING AS DIRECTED IN THE DRAWINGS. TIE INTO THE EXISTING FLOOR HYDRONIC PIPING FROM THE FIN-TUBE/BASEBOARD LOCATED IN

PHASE 2: INSTALL HYDRONIC PIPING AS DEPICTED IN THE DRAWINGS UP TO THE BOILER. ADD NEW CONNECTIONS AND PIPING AS REQUIRED. TIE INTO THE EXISTING FLOOR PIPING FROM THE FIN-TUBE/BASEBOARD LOCATED IN PHASE 3.

PHASE 3: INSTALL HYDRONIC PIPING AS DEPICTED IN THE DRAWINGS. TIE INTO THE NEW PIPING LOCATED IN THE DROP CEILING OF PHASE 2, AND ALSO TIE INTO THE EXISTING FIN-TUBE/BASEBOARD PIPING LOCATED ON THE PHASE 4 FLOOR LEVEL.

PHASE 4: INSTALL HYDRONIC PIPING AS DEPICTED IN THE DRAWINGS. TIE INTO THE NEW PIPING LOCATED IN THE DROP CEILING OF PHASES 3 AND 1.

HOT WATER HEATER TO BE PROVIDED WITH INTEGRAL THERMOSTATE, VALVE KIT INSTALLED WITH UNIT

ALL ROOF DUCTWORK DESIGNED AS THERMODUCT, CONTRACTOR MAY PROVIDE

SUPPLY DIFFUSER TO BE INSTALLED BELOW MAIN DUCT AND SUPPLIED FROM A

OVERLAPPING DUCTWORK MAY BE INSTALLED EITHER WAY — SUPPLY OVER RETURN OR RETURN OVER SUPPLY, AS COORDINATED IN FIELD. DUCTWORK PASSES THROUGH JOISTS.

SUPPLY BRANCHES OFF FROM ABOVE MAIN SUPPLY DUCT. RETURN BRANCHES OFF FROM ABOVE MAIN RETURN DUCT.

ALL BRANCHES ON INDICATED DUCT MAY CONNECT FROM ABOVE, BELOW, OR SIDE AS COORDINATED IN FIELD.

SUPPLY AND RETURN DROPS DUCTS WITHIN THEIR OWN RESPECTIVE JOIST SPACE. JOIST LOCATIONS TO BE VERIFIED AT SITE.

DUCTWORK ROUTED BETWEEN JOISTS. DUCTWORK ROUTED UNDERNEATH JOISTS.

VAV FOR REHEAT CONTROL. PROVIDE WALL THERMOSTAT FOR VAV CONTROL. PIPING TO HAVE VALVE KIT WITH CONTROL VALVE. HYDRONIC SUPPLY AND RETURN TO BE TIED INTO VAV COIL FROM MAIN PIPES.

COORDINATE ALL ROOF CUTTING, PATCHING, AND FLASHING WITH GENERAL CONTRACTOR FOR ALL ROOF PENETRATIONS.

HYDRONIC SUPPLY AND RETURN PIPING SERVING VAV REHEAT COILS AND UNIT HEATERS. ROUTED IN DROP CEILINGS UNLESS NOTED OTHERWISE. SUPPLY & RETURN TO BE INSULATED PER CODE.

CABINET UNIT HEATER FOR VESTIBULE HEAT, UNIT TO HAVE INTEGRAL THERMOSTAT. HEAT TO TURN ON WHEN SPACE IS BELOW 50 F, UNIT TO TURN OFF WHEN SPACE IS

CIRCUIT SETTER FOR HYDRONIC SYSTEM CONTROL, COORDINATE WITH EXISTING

BOILER & PUMP REQUIREMENTS.

NEW SUPPLY AND RETURN DUCTWORK TO CONNECT TO EXISTING DUCT TRANSITION. SERVING RTU. PROVIDE TRANSITION FITTINGS AS REQUIRED BETWEEN DRAWING INDICATED DUCT RISER AND EXISTING RTU CONNECTION. CONNECTION LOCATIONS AND DIMENSIONS VERIFIED AT SITE. PROVIDE INTERNAL AIR SPLITTER OR TURING VEINS WITHIN THE SUPPLY PLENUM TO ALLOW SMOOTHER AIR SPLITTING.

SUPPLY DIFFUSERS TO BE ELEVATED ON SAME LEVEL AS ACOUSTIC PANELS AND LOCATED BETWEEN THEM AS DEPICTED ON DRAWING. DIFFUSERS DUCT TO BE ROUTED SUCH THAT IT AVOIDS ACOUSTIC HANGERS. COORDINATE WITH ACOUSTIC PANEL INSTALLATION. DUCT WORK AND DIFFUSER PLACEMENT TO AVOID LIGHTING FIXTURES AND HANGERS, COORDINATE WITH LIGHTING INSTALLATION.

BRANCH MAY GO ROUTE THROUGH JOISTS IF SPACE RESTRICTS OTHERWISE. ALL SUPPLY DUCTWORK FROM INDICATED UNIT DESIGNED AS THERMODUCT,

CONTRACTOR MAY PROVIDE EQUAL. ALL EXPOSED DUCT WORK, ACCESSORIES, AND DIFFUSERS TO AT PHASE 1 SHALL BE PAINTED BLACK

DIFFUSERS TO AVOID LIGHTING FIXTURES, COORDINATE WITH LIGHTING FIXTURE LOCATIONS INSTALLATION.

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Client: LACTALIS AMERICAN GROUP

RENOVATIONS AT 2376 SOUTH PARK **AVENUE**

Project Address: 2376 SOUTH PARK AVENUE

Drawing History: # Date Description

Date: 11/06/2025

Project Number: 25042 Sheet Title: FIRST FLOOR **MECHANICAL PLAN**

- PHASE 4

GENERAL MECHANICAL NOTES:

- COORDINATE WORK WITH ALL TRADES PRIOR TO INSTILLATION.
- ALL 90 DEGREE TRANSITIONS IN DUCTWORK TO BE PROVIDED TURNING VANES.
 PROVIDE VOLUME DAMPERS ON ALL DUCTWORK BRANCHES FOR BALANCING.
- I. INSTALL ALL UNITS PER MANUFACTURERS REQUIREMENTS.
 PROVIDE 1" THICK INSULATION ON ALL SUPPLY DUCTWORK.
- DIFFUSERS LOCATIONS TO AVOID LIGHTING FIXTURES, COORDINATE WITH LIGHTING FIXTURE INSTALLATION.
- LIGHTING FIXTOIL INGTALLATION.

HYDRONIC PIPING FOR VAV REHEAT AND UNIT HEATERS CONSTRUCTION NOTES:

DUE TO THIS SYSTEM EXISTING IN MULTIPLE DEMO & CONSTRUCTION PHASES. THE CONSTRUCTION SHALL PROCEED AS FOLLOWS:

- 1. PHASE 1: INSTALL HYDRONIC PIPING AS DIRECTED IN THE DRAWINGS. TIE INTO THE EXISTING FLOOR HYDRONIC PIPING FROM THE FIN-TUBE/BASEBOARD LOCATED IN
- BOILER. ADD NEW CONNECTIONS AND PIPING AS REQUIRED. TIE INTO THE EXISTING FLOOR PIPING FROM THE FIN-TUBE/BASEBOARD LOCATED IN PHASE 3.

PHASE 2: INSTALL HYDRONIC PIPING AS DEPICTED IN THE DRAWINGS UP TO THE

- 3. PHASE 3: INSTALL HYDRONIC PIPING AS DEPICTED IN THE DRAWINGS. TIE INTO THE NEW PIPING LOCATED IN THE DROP CEILING OF PHASE 2, AND ALSO TIE INTO THE EXISTING FIN-TUBE/BASEBOARD PIPING LOCATED ON THE PHASE 4 FLOOR LEVEL.
- 4. PHASE 4: INSTALL HYDRONIC PIPING AS DEPICTED IN THE DRAWINGS. TIE INTO THE NEW PIPING LOCATED IN THE DROP CEILING OF PHASES 3 AND 1.

MECHANICAL DRAWING NOTES:

- HOT WATER HEATER TO BE PROVIDED WITH INTEGRAL THERMOSTATE, VALVE KIT INSTALLED WITH UNIT
- 2. ALL ROOF DUCTWORK DESIGNED AS THERMODUCT, CONTRACTOR MAY PROVIDE FOUAL.
- 3. SUPPLY DIFFUSER TO BE INSTALLED BELOW MAIN DUCT AND SUPPLIED FROM A
- 4. OVERLAPPING DUCTWORK MAY BE INSTALLED EITHER WAY SUPPLY OVER RETURN OR RETURN OVER SUPPLY, AS COORDINATED IN FIELD.
- 5. DUCTWORK PASSES THROUGH JOISTS.
- SUPPLY BRANCHES OFF FROM ABOVE MAIN SUPPLY DUCT.
 RETURN BRANCHES OFF FROM ABOVE MAIN RETURN DUCT.
- 8. ALL BRANCHES ON INDICATED DUCT MAY CONNECT FROM ABOVE, BELOW, OR SIDE AS COORDINATED IN FIELD.
- 9. SUPPLY AND RETURN DROPS DUCTS WITHIN THEIR OWN RESPECTIVE JOIST SPACE. JOIST LOCATIONS TO BE VERIFIED AT SITE.
- 10. DUCTWORK ROUTED BETWEEN JOISTS.
- 10. DUCTWORK ROUTED BETWEEN JOISTS.11. DUCTWORK ROUTED UNDERNEATH JOISTS.
- 12. VAV FOR REHEAT CONTROL. PROVIDE WALL THERMOSTAT FOR VAV CONTROL. PIPING TO HAVE VALVE KIT WITH CONTROL VALVE. HYDRONIC SUPPLY AND RETURN
- TO BE TIED INTO VAV COIL FROM MAIN PIPES.

 13. COORDINATE ALL ROOF CUTTING, PATCHING, AND FLASHING WITH GENERAL
- CONTRACTOR FOR ALL ROOF PENETRATIONS.

 14. HYDRONIC SUPPLY AND RETURN PIPING SERVING VAV REHEAT COILS AND UNIT
- HEATERS. ROUTED IN DROP CEILINGS UNLESS NOTED OTHERWISE. SUPPLY & RETURN TO BE INSULATED PER CODE.
- 15. CABINET UNIT HEATER FOR VESTIBULE HEAT, UNIT TO HAVE INTEGRAL THERMOSTAT, HEAT TO TURN ON WHEN SPACE IS BELOW 50 F, UNIT TO TURN OFF WHEN SPACE IS
- 16. CIRCUIT SETTER FOR HYDRONIC SYSTEM CONTROL, COORDINATE WITH EXISTING BOILER & PUMP REQUIREMENTS.
- 17. NEW SUPPLY AND RETURN DUCTWORK TO CONNECT TO EXISTING DUCT TRANSITION.

 SERVING RTU. PROVIDE TRANSITION FITTINGS AS REQUIRED BETWEEN DRAWING
 INDICATED DUCT RISER AND EXISTING RTU CONNECTION. CONNECTION I OCATIONS
- INDICATED DUCT RISER AND EXISTING RTU CONNECTION. CONNECTION LOCATIONS AND DIMENSIONS VERIFIED AT SITE. PROVIDE INTERNAL AIR SPLITTER OR TURING VEINS WITHIN THE SUPPLY PLENUM TO ALLOW SMOOTHER AIR SPLITTING.

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BRANCH MAY GO ROUTE THROUGH JOISTS IF SPACE RESTRICTS OTHERWISE.

- ALL SUPPLY DUCTWORK FROM INDICATED UNIT DESIGNED AS THERMODUCT, CONTRACTOR MAY PROVIDE EQUAL.
- 21. ALL EXPOSED DUCT WORK, ACCESSORIES, AND DIFFUSERS TO AT PHASE 1 SHALL BE
- 22. DIFFUSERS TO AVOID LIGHTING FIXTURES, COORDINATE WITH LIGHTING FIXTURE LOCATIONS INSTALLATION.

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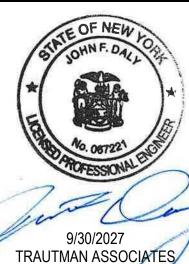
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Client: LACTALIS

AMERICAN GROUP

Project: OFFICE
RENOVATIONS AT
2376 SOUTH PARK

AVENUE

Project Address: 2376 SOUTH PARK AVENUE BUFFALO, NY 14220

Drawing History: # Date Description

Date: 11/06/2025

Project Number: 25042

Sheet Title: ROOF MECHANICAL

PLAN - PHASE 4

et Number: M201

ROOF MECHANICAL PLAN PHASE 4

PLUMBING SYMBOLS / ABBREVIATIONS LEGEND:

SOLENOID OPERATED VALVE

EXPANSION JOINT (EJ)

BACKFLOW PREVENTER

RPZ = REDUCE PRESSURE ZONE TYPE

	- NEW PIPING	O⊢ VIR	VALVE IN RISER
	- DEMOLITION	C	RISER DOWN (ELBOW)
	EXISTING TO REMAIN	0	RISER UP (ELBOW)
V	- VENT		RISE OR DROP
ST	STORM / RAINWATER DRAIN		BRANCH - TOP CONNECTION
SS	SOIL, WASTE, OR SANITARY SEWER (SAN)		BRANCH - BOTTOM CONNECTION
G_	- NATURAL GAS		
EST	- EMERGENCY (SECONDARY) STORM DRAIN		BRANCH - SIDE CONNECTION
_	,		CAP ON END OF PIPE
CD	CONDENSATE DRAIN (COND)	Œ—	TRAP
	- DOMESTIC COLD WATER (DCW)	◯ FD	FLOOR DRAIN
	- DOMESTIC HOT WATER (DHW)	<u>. </u>	
	RECIRCULATING DOMESTIC HOT WATER (DHWR)	RD	ROOF DRAIN
	- SHUTOFF VALVE	•	EXISTING FIXTURE TO REMAIN
	- CLEANOUT PLUG		FIXTURE TO BE PROVIDED
FCO O	FLOOR CLEANOUT	•	FIXTURE TO BE REMOVED
	WALL CLEANOUT	EQPT	EQUIPMENT
	- STRAINER	ETR	EXISTING TO REMAIN
>	– PUMP	MECH	MECHANICAL
	- POMP	TYP.	TYPICAL
\	- WATER HAMMER ARRESTER (SIZE INDICATED)	VTR	VENT THROUGH ROOF
-	WATERTIANNINER ARRESTER (SIZE INDICATED)		POINT OF CONNECTION TO EXIST
\vdash	HOSE BIBB (HB) OR WALL HYDRANT (WH)		
	- GAS COCK, GAS STOP		
──	- BALANCING VALVE		

GENERAL PLUMBING NOTES:

- WHERE PIPING, FIXTURE, OR EQUIPMENT IS INDICATED TO BE PROVIDED, PROVIDE FIXTURE, PIPING, AND AL ASSOCIATED ACCESSORIES, INCLUDING SUPPLY FITTINGS, FAUCET, TRAP, SUPPORTS, HANGERS, INSULATION, ETC. EXTEND PIPING ACCORDING TO DRAWINGS AND AS NECESSARY TO CONNECT FIXTURES AND EQUIPMENT. SEE SCHEDULES AND SPECIFICATIONS
- COORDINATE INSTALLATION WITH ALL OTHER TRADES, INCLUDING OTHER PIPING, DUCTWORK, GRILLES, LIGHTS, ETC, AS WELL AS THE EXISTING STRUCTURE. CEILING SPACE IS VERY LIMITED AND INSTALLATION BE CAREFULLY COORDINATED. COORDINATE PIPING INSTALLATION IN CHASES WITH ALL OTHER CONTRACTORS.
- COORDINATE ALL FLOOR PENETRATIONS WITH THE GENERAL CONTRACTOR.
- INSTALL ALL MATERIALS AND EQUIPMENT ACCORDING TO MANUFACTURES INSTRUCTIONS AND RECOMMENDATIONS AND ACCORDING TO CODE.
- ALL PIPING, EQUIPMENT, AND ALL ACCESSORIES IN ALL AREAS, ARE TO BE INSTALLED TIGHT TO THE STRUCTURE TO ALLOW THE GREATEST FLOOR TO CEILING CLARENCE POSSIBLE. VERIFY EXACT ROUTING IN FIELD.
- PROVIDE FIRESTOPPING AT ALL PIPE PENETRATIONS THROUGH ALL FIRE RATED ASSEMBLIES. SEE ARCHITECTURAL DRAWINGS FOR FIRE RATINGS.
- LABEL ALL PIPING, VALVES, EQUIPMENT, SPECIALTIES, ETC. ACCORDING TO CODE AND TO
- INSULATE ALL PIPING ACCORDING TO NEW YORK STATE ENERGY CONSERVATION CONSTRUCTION
- PROVIDE ALL TESTING AND ADJUSTING ACCORDING TO CODE AND TO SPECIFICATIONS.
- ALL VALVES OR OTHER EQUIPMENT REQUIRING FUTURE SERVICE/MAINTENANCE ARE TO BE LOCATED IN ACCESSIBLE AREA. PROVIDE LOCKABLE ACCESS DOORS WHERE REQUIRED. COORDINATE WITH GENERAL CONTRACTOR.
- 11. ALL PLUMBING WORK MUST BE PERFORMED IN ACCORDANCE WITH ALL APPLICABLE CODES AND ALL AUTHORITIES HAVING JURISDICTION.
- 12. REFER TO STRUCTURAL DETAIL 3 ON S102 FOR TYPICAL OPENING REINFORCEMENT AT EXISTING CONCRETE JOIST AND DETAIL 3 ON S503 FOR TYPICAL REINFORCEMENT FOR OPENING IN EXISTING SLAB. COORDINATE PIPE PENETRATIONS WITH ALL OTHER TRADES PRIOR TO FLOOR CUTTING. AVOID CUTTING EXISTING CONCRETE JOISTS.

						PLUMBING FI	KTURE \$	SCHED	ULE					
TAG		FIXTURE	MATERIAL	TYPE	FINISH	OPERATOR/ FITTING	CARRIE R	DCW	DHW-140 DEG F	DHW-115 DEG F	WASTE	VENT	NOTES & ACCESSORIES	
LAV-1	DESCRIPTION	LAVATORY	VITREOUS CHINA	UNDERMOUNT	WHITE	PROVIDE LKB736C COMMERCIAL LAVOATORY DECK	NA	1/2"	NA	1/2"	1-1/4"	1-1/4"	PROVIDE QUATER TURN (BRASSCRAFT COMPRESSION) ANGLE STOPS, SINK SUPPLY HOSE CONNECTION, AND 1-1/4" x 1-1/4" P TRAP (MCGUIRE "MCT125 SERIES." PROVIDE ASSE	
LAV-1	MANUFACTURER	AMERICAN STANDARD		ADA COMPLAINT		MOEN GRAEDEN LAVATORY 84138SRN							1070 MIXING VALVE UNDER SINK. COORDINATE INSTALL WITH ELECTRICAL CONTRACTOR. PROVIDE ANY ADDITIONAL ACCESSORIES INCLUDING LOW VOLTAGE WIRING AND	
	DESCRIPTION	WATER CLOSET	VITREOUS CHINA	WALL MOUNT, FLUSH VALVE,	WHITE	FLUSH VALVE INSLUDED TOILET	WATTS ADJUS	1"	NA	NA	3"	2"	PROVIDE OPEN FRONT, ELONGATED WHITE TOILET SEAT. COORDIANTE INSTALL WITH ELECTRICAL CONTRACTOR.	
WC-1	MANUFACTURER	AMERICAN STANDARD		AFWALL MILLENIUM		SELECTRONIC 1.6/1.1 GPF							PROVIDE ANY ADDITONAL ACCESSORIES INCLDUNG LOW VOLTAGE WIREING AND TRANSFORMERS.	
UR-1	DESCRIPTION	URINAL	VITREOUS CHINA	WALL MOUNT, WASHDOWN, TOP SPUD	WHITE	SENSOR HARD WIRED, FLUSH VALVE	WATTS CARRIE R	1/2"	NA	NA	2"	1-1/2"	COORDINATE INSTALL WITH ELECTRICAL CONTRACTOR. PROVIDE ANY ADDITIONAL ACCESSORIES INCLUDING LOW VOLTAGE WIRING AND TRANSFORMERS.	
	MANUFACTURER	AMERICAN STANDARD	-	WASHBROOK TOP SPUD URINAL										
FD-1	DESCRIPTION	SHOWER	BRASS	SHOWER HEAD WITH ROUGHIN VALVE		SELECTED BY OWNER	NA	1/2"	NA	1/2"	2"	2"	SHOWER VALVE SELECTED BY OWNER. SHOWER TRIM ON	
1 0-1	MANUFACTURER	SELECTED BY OWNER											MAX. 2.0 GPM SHOWER HEAD.	
DF-1	DESCRIPTION	DRINKING FOUNTAIN	STAINLESS STEEL	WALL MOUNTED, BI-LEVEL, BOTTLE FILLER		HANDS-FREEBOTTLE FILLER SENSOR + FRONT & SIDE PUCH-BAR BUBBLERS	NA	1/2"	NA	NA	2"	2"	ELKAY LZSTL8WSSP, 115 V/60Hz ~ 270 W, FLA 5, FILTERED, LED FILTER STATUS & AUTO RESET, ENERGY SAVER MODE	
	MANUFACTURER	ELKAY	STAINLESS STEEL			1212SGH								
FCO	DESCRIPTION	FLOOR CLEANOUT	CAST IRON	SQUARE, S.S. TOP,NO HUB		NA	NA	NA	NA	NA	4"	NA		
1 00	MANUFACTURER	WATTS		CO-1200-S										
WCO	DESCRIPTION	WALL CLEANOUT	BRASS WALL WITH STAINLESS STEEL COVER								4"			
	MANUFACTURER	WATTS		CO-59										
NOTES:							'							



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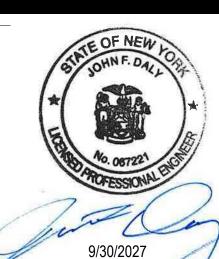
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Project: OFFICE **RENOVATIONS AT** 2376 SOUTH PARK **AVENUE**


Project Address: 2376 SOUTH PARK AVENUE BUFFALO, NY 14220

Drawing History: # Date Description

Date: 11/06/2025 Project Number: 25042

Sheet Title: SYMBOLS AND **LEGENDS**


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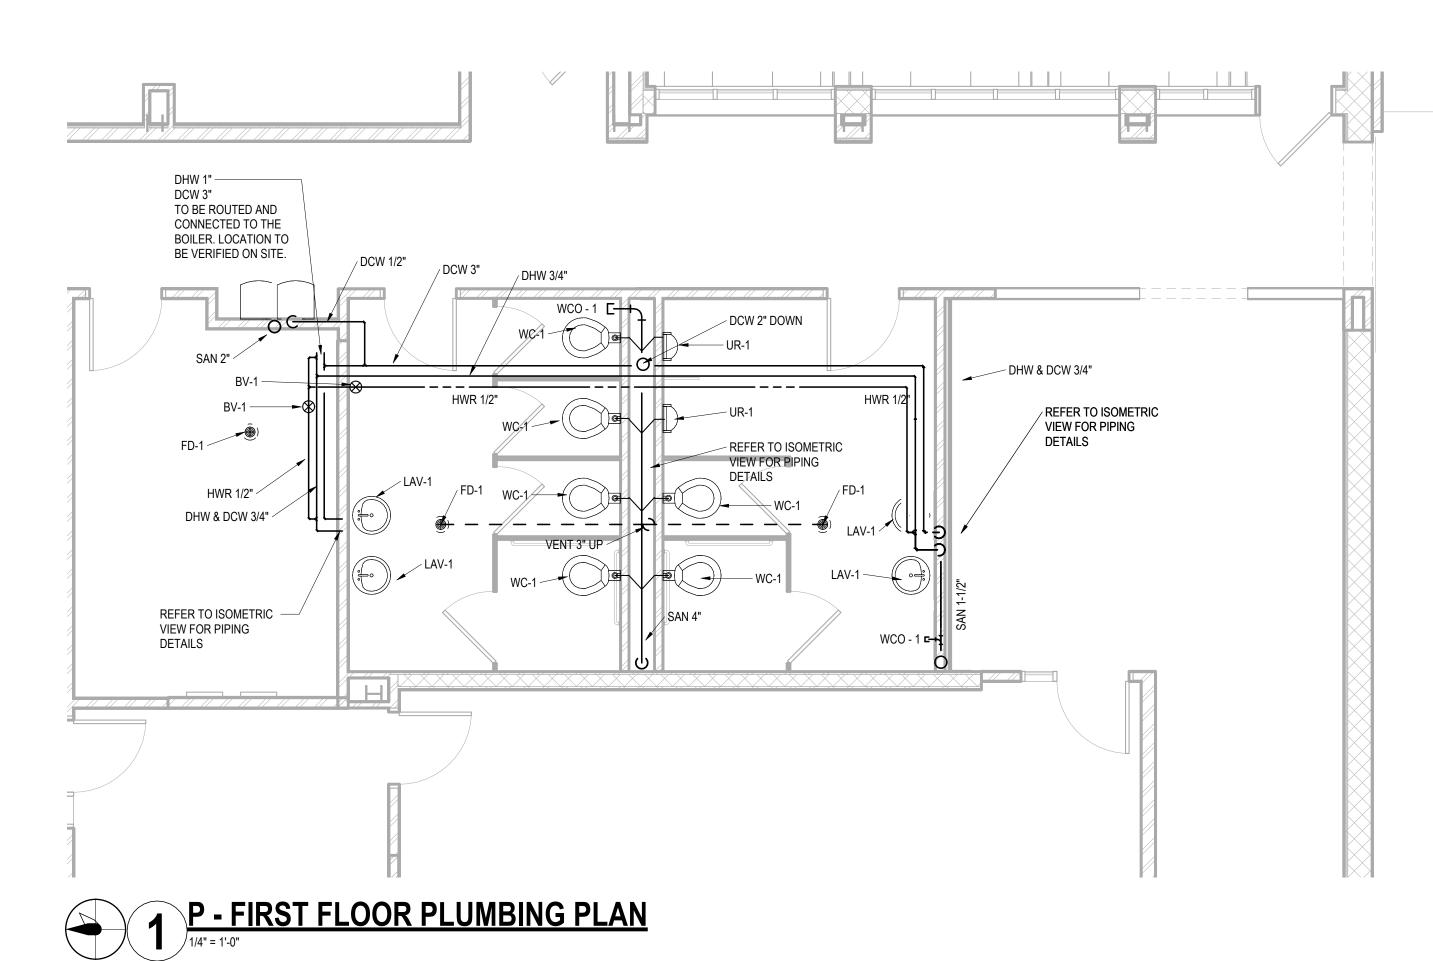
RENOVATIONS AT 2376 SOUTH PARK **AVENUE**

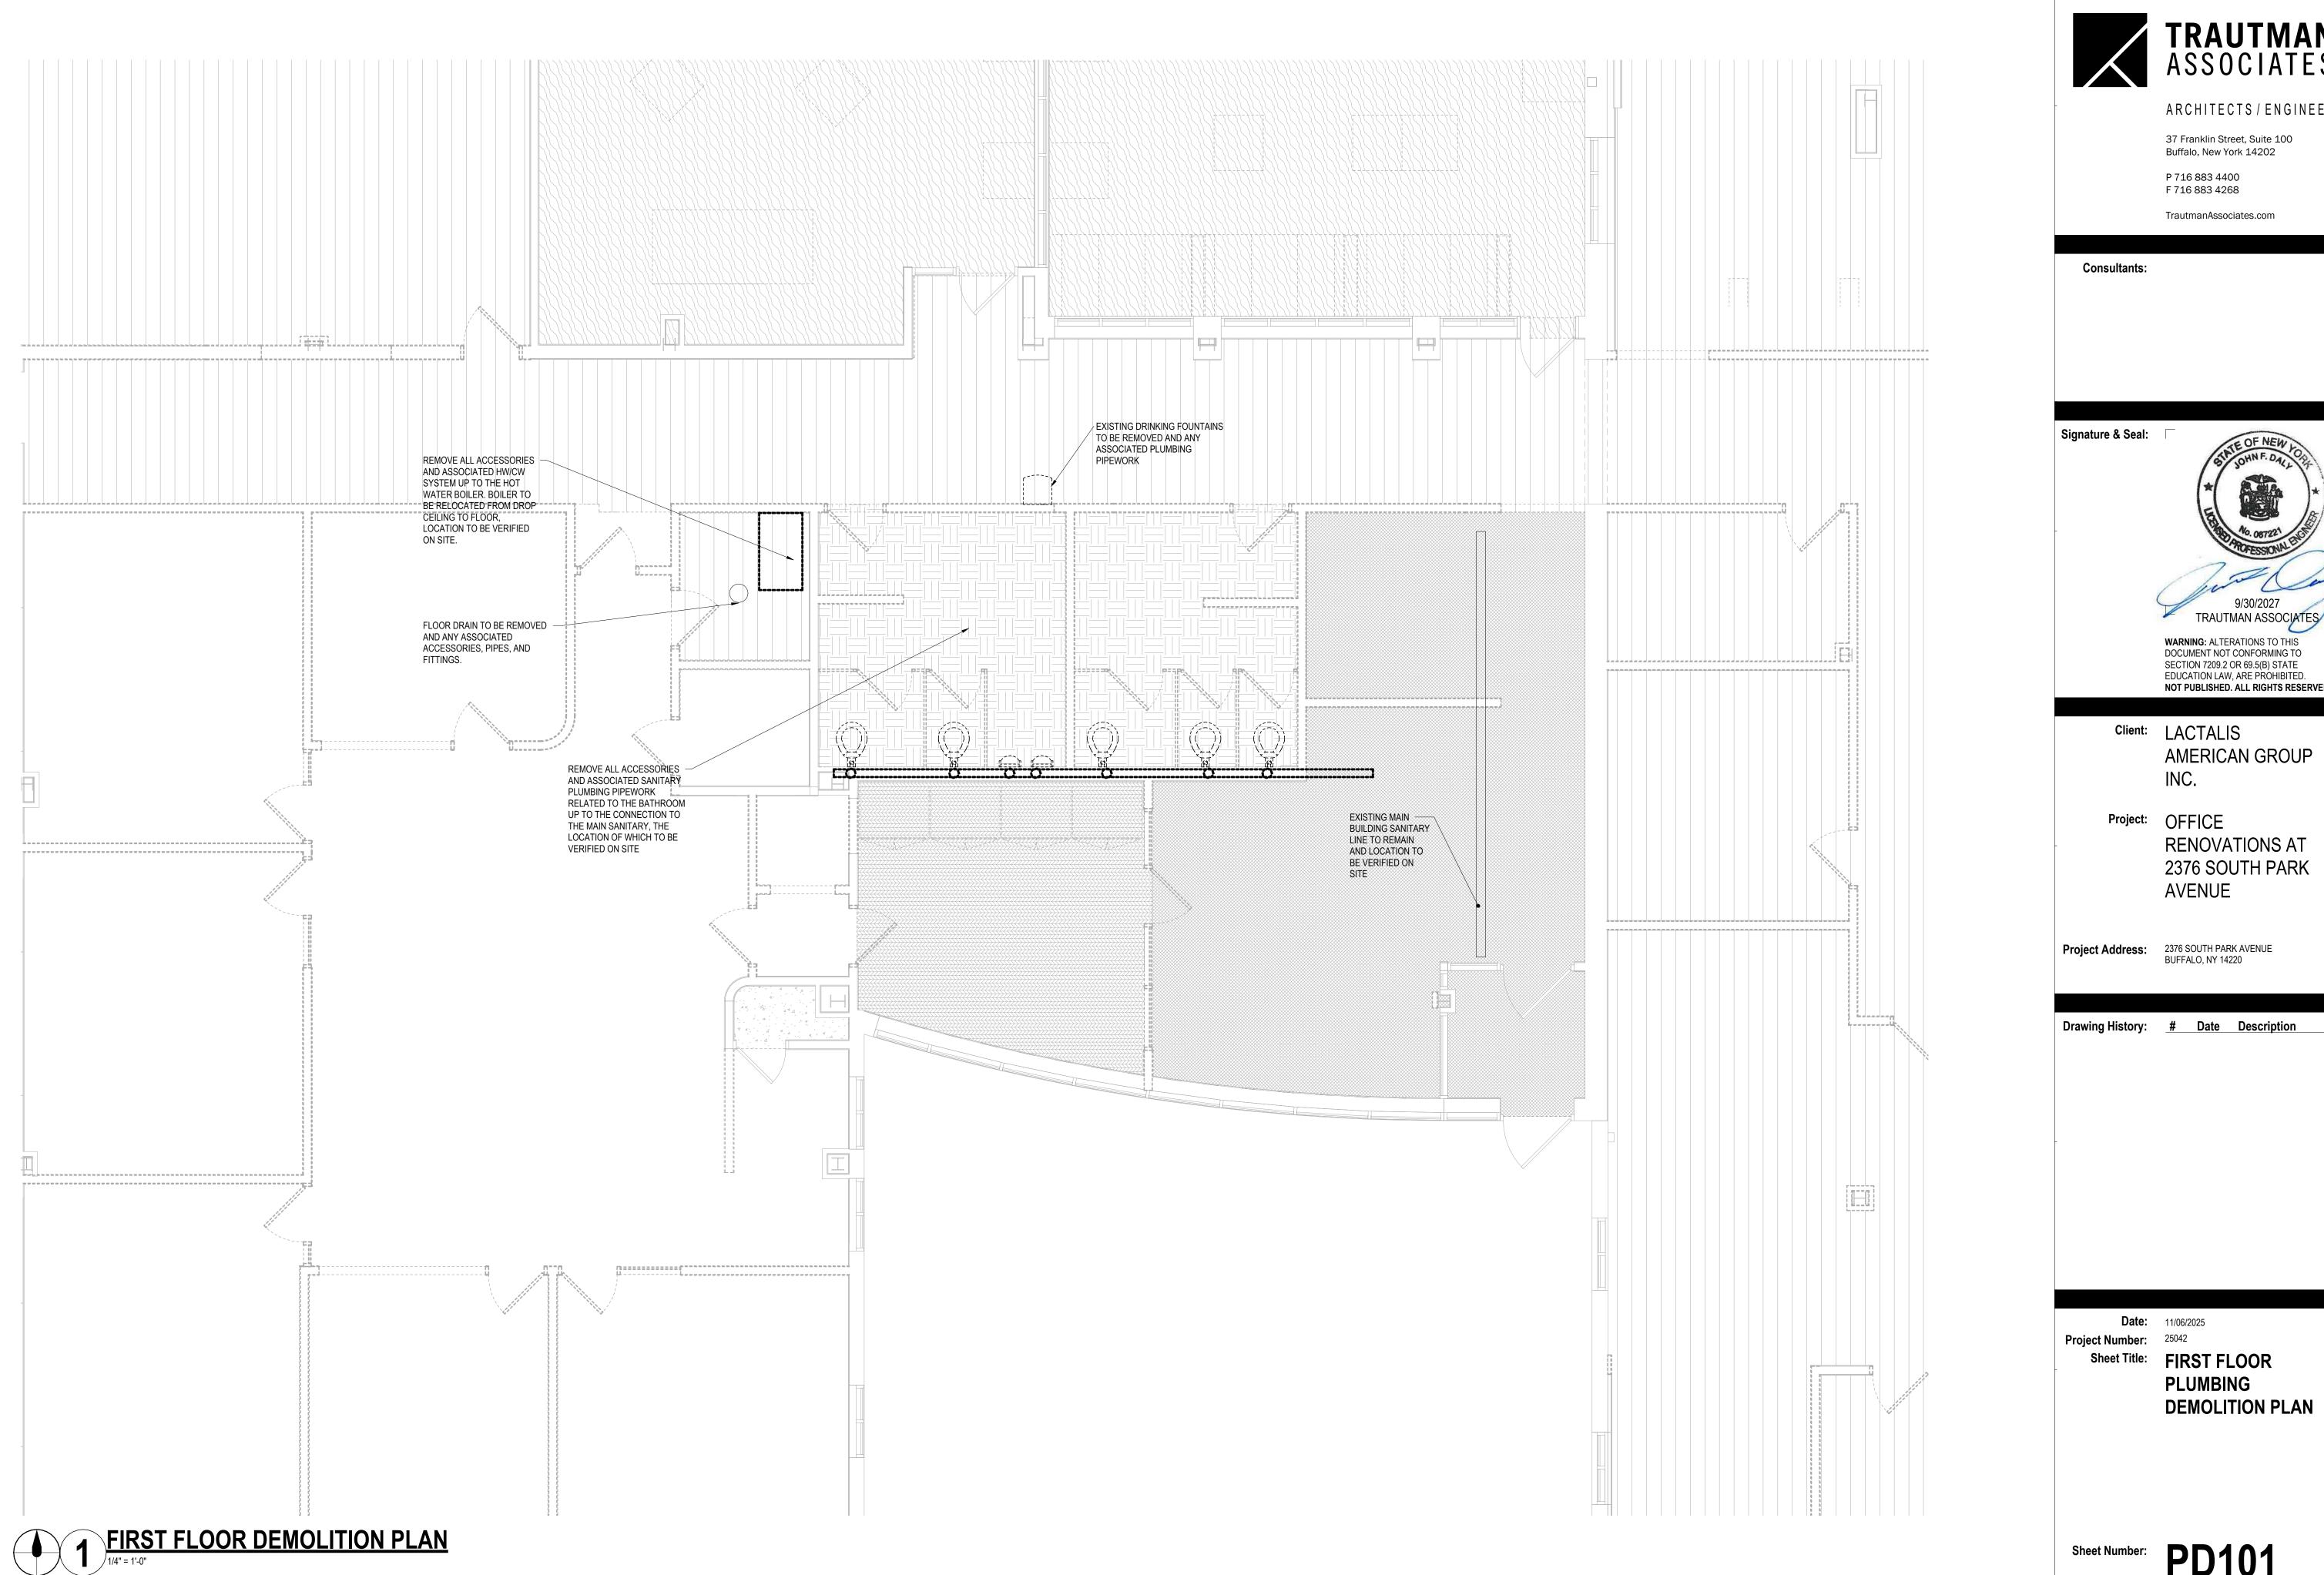
Drawing History: # Date Description

PLUMBING

DEMOLITION PLAN

Sheet Number: PD101

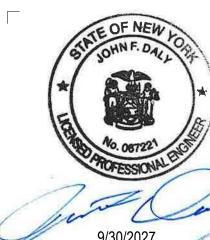

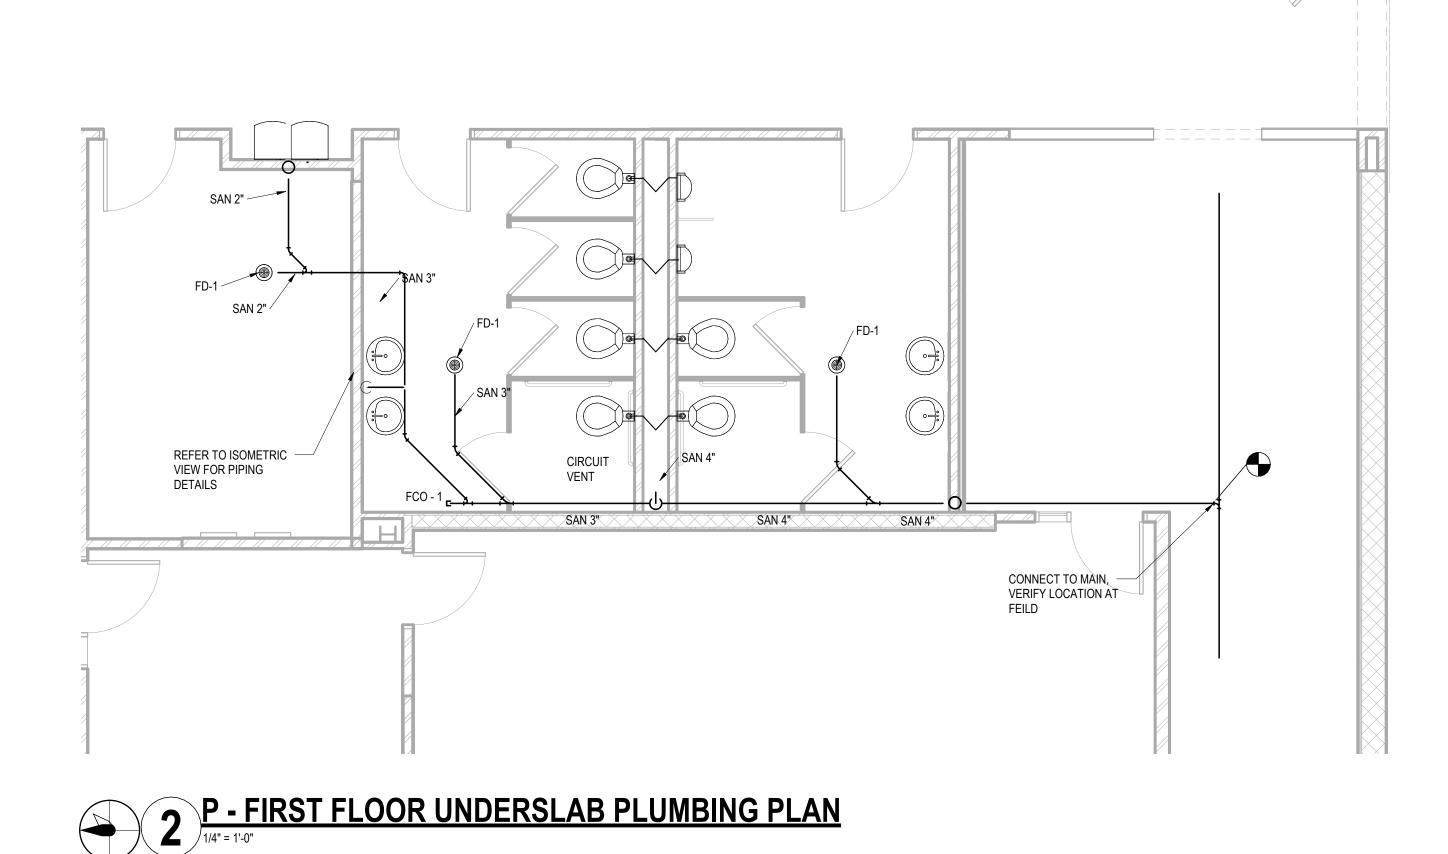

/ 2" DCW / TIE INTO FLOOR DRAIN VENT. / 1/2" DCW TO UR-1 1" DCW TO WC-1 K 2" VENT TIE INTO FLOOR P-TRAP (TYP.) SANITARY. √ 1/2" DHW TO LAV-1 3/4" DHW — / 1/2" DCW TO LAV-1 3" SAN -1/2" DHW TO LAV-1 1/2" DCW TO LAV-1 2" VENT / WC-1 W/ 3" P-TRAP (TYP.) LAV-1 W/ 1-1/4" P-TRAP (TYP.) — LAV-1 W/ 1-1/4" 1-1/2" SAN P-TRAP (TYP.) CONNECT TO MAIN, VERIFY LOCATION AT FEILD FCO - 1 \4" SAN [\] 4" SAN

ISOMETRIC VIEW OF BATHROOMS

1/8" = 1'-0"



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RENOVATIONS AT 2376 SOUTH PARK AVENUE

Project Address: 2376 SOUTH PARK AVENUE BUFFALO, NY 14220

Drawing History: # Date Description

Date: 11/06/2025 **Project Number:** 25042

pject Number: 25042
Sheet Title: FIRST FLOOR

PLUMBING PLAN

Sheet Number: P101

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