SOUTH PARK MIXED USE

DOFI PROPERTIES

2221 SOUTH PARK AVE BUFFALO, NY 14220 08/04/25 PERMIT SET

PROJECT #2508



SHEET NUMBER	SHEET NAME
GENERAL	
A-001	SYMBOLS, ABBREVIATIONS & GEN. NOTES
CODE REVIEW	
LS-01	LIFE SAFETY
CIVIL	
SP-101	SITE PLANS
SP-102	SITE PLANS
SP-103	SITE PLANS
SP-201	SITEWORK DETAILS
SP-202	SITEWORK SPECIFICATIONS
STRUCTURAL	
S-100	EIXSTING BASEMENT PLAN
S-101	EXISTING 1ST FLOOR FRAMING PLAN
S-102	EXISTING 2ND FLOOR FRAMING PLAN
S-103	EXISTING 3RD FLOOR FRAMING PLAN
S-104	EXISTING ROOF FRAMING PLAN
S-105	SPECIFICATIONS
S-106	TYPICAL DETAILS
S-107	TYPICAL DETAILS
S-108	SECTIONS AND DETAILS
ARCHITECTURAL D	
D-100	DEMO BASEMENT PLAN
D-101	FIRST FLOOR DEMOLITION PLAN
D-101	SECOND FLOOR DEMO PLAN
D-102	THIRD FLOOR DEMO PLAN
D-104	ROOF DEMO PLAN
D-200	DEMO EXTERIOR ELEVATIONS
D-201	DEMO EXTERIOR ELEVATION DEMO EXTERIOR ELEVATION
D-202	DEMO EXTERIOR ELEVATIONS
ARCHITECTURAL	DEMO EXTERNOR ELEVATIONS
A-100	BASEMENT PLAN
A-101	FIRST FLOOR PLAN
A-101	SECOND FLOOR PLAN
A-103	THIRD FLOOR PLAN
A-103	ROOF PLAN
A-104 A-200	EXTERIOR ELEVATIONS
A-200 A-201	EXTERIOR ELEVATIONS EXTERIOR ELEVATIONS
A-201 A-202	EXTERIOR ELEVATIONS EXTERIOR ELEVATION
A-250	BUILDING SECTIONS
A-251	BUILDING SECTION
A-300	VERTICAL CIRCULATION
A-400	BASEMENT REFLECTED CEILING PLAN
A-400 A-401	GROUND FLOOR REFLECTED CEILING PLAN
A-402	SECOND FLOOR REFLECTED CEILING PLAN
A-402 A-403	THRID FLOOR REFLECTED CEILING PLAN
A-403 A-501	INTERIOR DETAILS
A-600	FINISH SCHEDULE
A-600 A-601	FIRST FLOOR FINISH PLAN
A-00 I	SECOND FLOOR FINISH PLAN
ላ ደበኃ	OLOGIND I LOOK I INIOH FLAN
A-602	THIRD ELOOP EINICH DLAN
A-603	THIRD FLOOR FINISH PLAN
A-603 A-800	PARTITION SCHEDULE
A-603	

SHEET NUMBER	SHEET NAME	
MECHANICAL	OHEET NAME	
M-1	HVAC SCHEDULES, LEGENDS AND ABBREVIATIONS	
M-2	HVAC SCHEDULES HVAC SCHEDULES	
M-3	HVAC SCHEDULES	
M-4	HVAC SCHEDULES	
M-5	HVAC OUTSIDE AIR CALCULATIONS AND SEQUENCE OF OPERATIONS	
M-6	HVAC SPECIFICATIONS HVAC SPECIFICATIONS	
M-7	HVAC SPECIFICATIONS HVAC SPECIFICATIONS	
M-8	HVAC SPECIFICATIONS HVAC SPECIFICATIONS	
M-9	BASEMENT FLOOR PLAN - HVAC DUCTWORK	
M-10	FIRST FLOOR PLAN - HVAC DUCTWORK AND PIPING	
M-10	SECOND FLOOR PLAN - HVAC DUCTWORK AND PIPING	
M-12	THIRD FLOOR PLAN - HVAC DUCTWORK AND PIPING	
M-13	ROOF PLAN - HVAC DUCTWORK AND PIPING	
M-14	HVAC DETAILS	
M-15	HVAC DETAILS HVAC DETAILS	
PLUMBING		
P-1	PLUMBING LEGENDS AND SCHEDULES	
P-2	PLUMBING SCHEDULES CONTINUED & DETAILS	
P-3	PLUMBING DETAILS CONTINUED	
P-4	PLUMBING SANITARY SEWER BASEMENT PLAN	
P-5	PLUMBING SANITARY SEWER FIRST FLOOR PLAN	
P-6	PLUMBING SANITARY SEWER SECOND FLOOR PLAN	
P-7	PLUMBING SANITARY SEWER THIRD FLOOR PLAN	
P-8	PLUMBING SANITARY SEWER ROOF PLAN	
P-9	PLUMBING DOMESTIC WATER BASEMENT PLAN	
P-10	PLUMBING DOMESTIC WATER & NATURAL GAS FIRST FLOOR PLAN	
P-11	PLUMBING DOMESTIC WATER SECOND FLOOR PLAN	
P-12	PLUMBING DOMESTIC WATER THIRD FLOOR PLAN	
P-13	PLUMBING SPECIFICATIONS	
FIRE PROTECTION	T LOINDING OF LOIN TO ATTORNO	
FP-1	FIRE PROTECTION LEGENDS, SCHEDULES, & DETAILS	
FP-2	FIRE PROTECTION BASEMENT PLAN	
FP-3	FIRE PROTECTION FIRST FLOOR PLAN	
FP-4	FIRE PROTECTION SECOND FLOOR PLAN	
FP-5	FIRE PROTECTION THIRD FLOOR PLAN	
ELECTRICAL	<u>- 1</u>	
E-1	ELECTRICAL SCHEDULES & LEGENDS	
E-2	ELECTRICAL ONE-LINE DIAGRAM	
E-3	ELECTRICAL PANEL SCHEDULES	
E-4	ELECTRICAL DETAILS	
E-5	BASEMENT FLOOR PLAN - POWER AND SYSTEMS	
E-6	FIRST FLOOR PLAN - POWER AND SYSTEMS	
E-7	SECOND FLOOR PLAN - POWER AND SYSTEMS	-
E-8	THIRD FLOOR PLAN - POWER AND SYSTEMS	
E-9	ROOF PLAN POWER AND SYSTEMS	
E-10	BASEMENT FLOOR PLAN LIGHTING	
E-11	FIRST FLOOR PLAN LIGHTING	
E-12	SECOND FLOOR PLAN LIGHTING	
E-13	THIRD FLOOR PLAN LIGHTING	
	ELECTRICAL SPECIFICATIONS	
E-3 E-4 E-5 E-6 E-7 E-8 E-9 E-10 E-11 E-12	ELECTRICAL PANEL SCHEDULES ELECTRICAL DETAILS BASEMENT FLOOR PLAN - POWER AND SYSTEMS FIRST FLOOR PLAN - POWER AND SYSTEMS SECOND FLOOR PLAN - POWER AND SYSTEMS THIRD FLOOR PLAN - POWER AND SYSTEMS ROOF PLAN POWER AND SYSTEMS BASEMENT FLOOR PLAN LIGHTING FIRST FLOOR PLAN LIGHTING SECOND FLOOR PLAN LIGHTING THIRD FLOOR PLAN LIGHTING THIRD FLOOR PLAN LIGHTING BASEMENT, FIRST, SECOND, THIRD FLOOR PLANS FIRE ALARM	

<u>OWNER</u> **CIVIL ENGINEER** STRUCTURAL ENGINEER <u>ARCHITECT</u> MEP/FP ENGINEER CONSTRUCTION MANAGER

TREDO ENGINEERS 755 SENECA ST BUFFALO, NY 14210

SUITÉ #202 716.876.7147 tel www.tredoengineers.com **TREDO ENGINEERS**

755 SENECA ST BUFFALO, NY 14210 SUITÉ #202 716.876.7147 tel www.tredoengineers.com **DOFI PROPERTIES** 208 S. CAYUGA

BUFFALO, NY 14221 www.dofiproperties.com **CJS ARCHITECTS**

755 SENECA STREET BUFFALO, NY 14210 716.856.6448 tel www.cjsarchitects.com HAYES CONSTRUCTION

EBS ENGINEERING 656 GENESEE ST BUFFALO, NY 14211 2568 WALDEN AVE BUFFALO, NY 14225

716.768.0145 tel 716.836.9600 tel www.hayesbuild.com www.ebspe.com

ABBREVIATIONS REFERENCE SYMBOLS MATERIALS LEGEND ALL ABBREVIATIONS NOT NECESSARILY USED ALL MATERIALS NOT NECESSARILY USED ALL SYMBOLS NOT NECESSARILY USED A.F.F. ABOVE FINISHED FLOOR EXIST. **EXISTING** MAS. MASONRY RFG. ROOFING SIMILAR INDICATION ABSORB. ABSORBATIVE **EXPANSION** MASONRY OPENING ROOM DETAIL/ SECTION NUMBER R.F.S. A.D. ACCESS DOOR EXPANSION JOINT MATL. ROOM FINISH SCHEDULE MATERIAL WALL SECTION ACOUST. ROUGH OPENING ACOUSTICAL EXP. **EXPOSED** MAX. MAXIMUM R.O. SHEET NUMBER -A.C.T. ACOUSTICAL CEILING TILE EXT. **EXTERIOR** MECH. **MECHANICAL** RND. ROUND EXTERIOR INSULATION AND FINISH SYSTEM A.P. ACCESS PANEL E.I.F.S. MEMB. MEMBRANE RUB. RUBBER A.W.P. ACOUSTICAL WALL PANEL RUBBER TILE MTL. METAL FABRIC WALL COVERING ADH. ADHESIVE F.W.C. MWU MILLWORK UNIT RUBBLE STONE SIMILAR INDICATION R.O.B. ADJ. FACE BRICK ADJACENT F.B. MINIMUM RUN OF BANK POROUS FILL DETAIL/ SECTION NUMBER -ADJUST. ADJUSTABLE F.C.U. MISC. MISCELLANEOUS FAN COIL UNIT AGGR. AGGREGATE F.N.D. FEMININE NAPKIN DISPOSAL MTD. MOUNTED SNC SANITARY NAPKIN CABINET **BUILDING SECTION** MOV. A.C. AIR CONDITIONING F.R.P. FIBERGLASS REINFORCED POLYESTER MOVABLE SND SANITARY NAPKIN DISPOSER F.T.R. MULL. SCHED. SCHEDULE SHEET NUMBER FIN TUBE RADIATION MULLION ALIGN ALT. ALTERATION FINISH (ED) SEALANT NATURAL ALTN. ALTERNATE FINISH FLOOR STG. SEATING CONCRETE SECT. NOISE REDUCTION COEFFICIENT ALUM. ALUMINUM FIRE ALARM SECTION APPD. APPROVED FIRE ALARM CONTOL PANEL N.I.C. F.A.C.P. NOT IN CONTRACT SHAMPOO BOWL DETAIL/ SECTION NUMBER ____1/ A101 APPROX. **APPROXIMATE** F.E.C. FIRE EXTINGUISHER CABINET N.T.S. NOT TO SCALE SHTG. SHEATHING **DETAIL SECTION** ARCH. **ARCHITECTURAL** FIRE HOSE CABINET NOM. NOMINAL SHEET ASB. ASBESTOS FIRE PROOFING NUMBER SHEET VINYL C.M.U. SHEET NUMBER A.A.C. ASBESTOS ABATEMENT CONTRACTOR FLOOR SHELF, SHELVING ASPH. FLOOR DRAIN ON CENTER ASPHALT F.D. SHOWER OPNG. AUTO. AUTOMATIC FOOT **OPENING** SIM. SIMILAR AVG. **AVERAGE** FTG. FOOTING OPP. OPPOSITE S.D. SOAP DISPENSER S.C. FDTN. FOUNDATION O.H. OPPOSITE HAND SOLID CORE SPKR. BSMT. BASEMENT OUTSIDE DIAMETER SPEAKER **ELEVATION NUMBER** FURRING BRG. BEARING OVERHEAD SPEC. SPECIFICATION GALLON BTWN. BETWEEN SQUARE **EXTERIOR ELEVATION** BIT. GALV. GALVANIZED PAINT (ED) S.F. **BITUMINOUS** SQUARE FOOT SHEET NUMBER STAINLESS STEEL BLK. S.S. BLOCK GALVANIZED IRON BLKG. BLOCKING GAUGE, GAGE PNL. PANEL STAND PIPE GENERAL CONTRACT (OR) PTD PAPER TOWEL DISPENSER STD. STANDARD BD. BOARD PTR PAPER TOWEL RECEPTOR BTM. BOTTOM STL. STEEL GLASS P.BD. BRK. BRICK GRAB BAR PARTICLE BOARD STONE **ELEVATION NUMBER** G.F.I. GROUND FAULT INTERRUPTER BRICK COURSE STOR. PTN. PARTITION STORAGE BLDG. GRN. PVMT. PAVEMENT STORM DRAIN BUILDING GRANITE INTERIOR ELEVATION B.U.R. **BUILT-UP ROOFING GYPSUM** PERF. PERFORATED STR. STRUCTURAL STRUCTURAL SHEET NUMBER GYPSUM WALL BOARD PLAS. SGT STRUCTURAL GLAZED TILE B.O. G.W.B. BY OWNER PLASTER PLAS.LAM. PLASTIC LAMINATE SUSP. SUSPENDED CAB. CABINET HDNR. HARDENER PLATE SW. SWITCH CPT. PLATE GLASS HARDWARE PL.GL. SW.BD. CARPET HDW. SWITCH BOARD PLBG. C.I. CAST IRON HDWD. HARDWOOD PLUMBING SYM. SYMMETRICAL ROUGH LUMBER SIMILAR INDICATION C.I.P. CAST IN PLACE HTR. HEATER P.C. PLUMBING CONTRACTOR PLAN OR DETAIL NUMBER CW. CASEWORK HTG. HEATING PLYWD. PLYWOOD TKBD. TACKBOARD LARGE SCALE BLOWUP OF C.B. CATCH BASIN HEATING CONTRACTOR **TELEPHONE** TEL. PLAN OR DETAIL CLG. HEATING, VENTILATING & POLISHED PLATE GLASS TEMP. **TEMPORARY** SHEET NUMBER CEILING TER. CEM. CEMENT AIR CONDITIONING POLISHED PLATE TERRAZZO BLOCKING C.M.T. TEXT. CERAMIC MOSAIC TILE TEXTURE HEIGHT TEMPERED GLASS C.M.T.B. CERAMIC MOSAIC TILE BASE HIGH PERFORMANCE COATINGS PPWG POLISHED PLATE THK. THICK (NESS) HPC CER. CERAMIC HIGH PRESSURE PLASTIC WIRE GLASS THRESHOLD PARTITION TYPE DESIGNATION -C.T. TO BE DETERMINED CERAMIC TILE LAMINATE POLYETHYLENE TBD CERAMIC TILE BASE C.T.B. TLT. HOLLOW CORE POLY RESIN TILE TOILET **PARTITION TYPE** P.V.C. CHBD. CHALK BOARD HOLLOW METAL POLYVINYL CHLORIDE TOILET PAPER HOLDER FINISHED WOOD T&G C.O. HORIZ. CLEAN OUT HORIZONTAL PCF POUNDS PER CUBIC FOOT TONGUE & GROOVE CLR. CLO. PSF T.O.G. TOP OF GRATE CLEAR H.B. HOSE BIB POUNDS PER SQUARE FOOT T.O.S. CLOSET H.CAB. HOSE CABINET POUNDS PER SQUARE INCH TOP OF STEEL COL. T.O.W. TOP OF WALL COLUMN HOT PLATE H.PL. PORCELAIN TILE C.W. COLD WATER HOT WATER PCP PRECAST CONCRETE PANEL TOWEL BAR H.W. PLYWOOD CONC. CONCRETE PRE-FAB. PREFABRICATED TYPICAL HOUR CONCRETE MASONRY UNIT C.M.U. H.S. HOSPITAL STOP PREFINISHED CONT. PMLD. CONTINUOUS PREMOLDED UNDER COUNTER DOOR SYMBOL C.J. C.G. **CONTROL JOINT** PSC PRE-STRESSED CONCRETE UCL UNDER COUNTER LIGHT CORNER GUARD INSULATED METAL PROJ. PROJECTION UNDERWRITERS LABORATORIES DOOR NUMBER CORR. CORRIDOR INSULATION OR INSULATED INSUL. PROPERTY LINE UNGND. UNDERGROUND RIGID INSULATION C.M.P. CORRIGATED METAL PANEL PUSH PLATE UNIT VENTILATOR INTERIOR DOOR TYPE CRS. COURSES INVERT U.N.O. UNLESS NOTED OTHERWISE **HW SET** ISOLATION QTY. QUANTITY UPHOLSTERY UPH. DEM. DEMOLISH / DEMOLITION QUARRY TILE DOOR NUMBER DETAIL JANITOR'S CLOSET V.B. **VAPOR BARRIER** WINDOW/ LOUVER SYMBOL BATT INSULATION DIAG. RAD. DIAGONAL JOINT **RADIUS** VERIFY IN FIELD VIF VERTICAL DIA. R.W.L. RAIN WATER LEADER VERT. DIAMETER WINDOW / LOUVER NUMBER DIFF. DIFFUSER LAMINATE RECPT. RECEPTACLE, ELECTRIC VESTIBULE DIM. LAV. REC. V.C.T. VINYL COMPOSITION TILE DIMENSION LAVATORY RECESS (ED) DISP. LH LEFT HAND R.C.P. V.W.C. VINYL WALL COVERING DISPENSER REFLECTED CEILING PLAN REF. GYPSUM DRYWALL DR. DOOR LGT. LENGTH REFRIGERATOR **ROOM NAME** LIGHT REG. WSCT. WAINSCOT DBL. DOUBLE REGISTER LIGHT PANEL REINF REINFORCE (D) (ING) (MENT) WC WATER CLOSET DOWN DN. **ROOM NAME** 101 R.C.P. REQD. D.S. DOWNSPOUT LIGHT WEIGHT REINFORCED CONCRETE PIPE W.H. WATER HEATER AND NUMBER **ROOM NUMBER** DWG. D.F. LINEAR FEET 150 SF DRAWING REQUIRED WEIGHT LTL. RES. W.W.F. DRINKING FOUNTAIN LINTEL RESILIENT WELDED WIRE FABRIC ALUMINUM SQUARE FOOTAGE D.I.P. DUCTILE IRON PIPE LVR. LOUVER R.B. RESILIENT BASE WITH LONG RETURN W/O WITHOUT EACH R.A. EA. RETURN AIR WD. WOOD E.W. M.D.H. MAGNETIC DOOR HOLDER WOOD BASE EACH WAY REV. REVISION WB CATEGORY / NOTE # INDICATOR (A1) ELEC. ELECTRIC M.H. MANHOLE RIGHT HAND **KEYNOTE SYMBOLS** POLYCARBONATE E.C. **ELECTRIC CONTRACTOR** MFGR. R.O.W. RIGHT OF WAY XFE EXISTING FIRE EXTINGUSIHER MANUFACTURER ELEV. **ELEVATION** MARB. RVT. CABINET MARBLE RIVET EQ. R.D. **ROOF DRAIN EQUAL** MARBLE TILE RF.H. MKRBD. ROOF HATCH EQUIP. **EQUIPMENT** MARKER BOARD **EQUIPMENT BY OWNER** ROOF VENT E.B.O. EXHAUST FAN LEVEL DESCRIPTION -LEVEL ELEVATION PLAN SYMBOLS LEVEL ELEVATION ALL SYMBOLS NOT NECESSARILY USED NEW COLUMN GRID INDICATOR -**EXISTING WALL TO REMAIN COLUMN GRID BUBBLE** =======**EXISTING WALL TO BE REMOVED** PLAN OR DETAIL NUMBER SHEET NUMBER 1/A101 **MATCH LINE NEW CONSTRUCTION - REFER TO WALL TYPES** MATCHLINE **EXISTING DOOR TO BE REMOVED** REVISION NUMBER (SHEET SPECIFIC) REVISION CLOUDED AREA OF REVISION

MATERIAL / OBJECT INDICATOR (55)


EQUIPMENT TAG

NEW DOOR - SEE DOOR SCHEDULE FOR ADDITIONAL INFORMATION



BUFFALO | ROCHESTER www.cjsarchitects.com



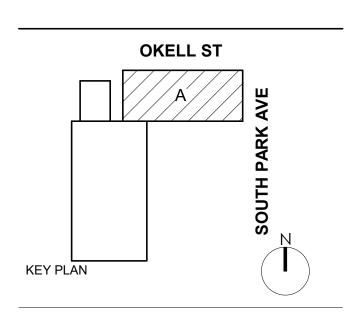

DOFI PROPERTIES

SOUTH PARK MIXED USE

2221 SOUTH PARK AVE BUFFALO, NY 14220

REV.#	DESCRIPTION	DATE	


JOB NO.	2508
SCALE	1/4" = 1'-0'
ISSUE DATE	08/04/25
DRAWN BY	NJM
CHECKED BY	RES
THIS IS A SINGLE SHEET OF A COHESIVE SET OF CONSTRUCTION DOCUMENTS (INCLUDING DRAWINGS AND SPECIFICATIONS)	

THIS IS A SINGLE SHEET OF A COHESIVE SET OF CONSTRUCTION DOCUMENTS (INCLUDING DRAWINGS AND SPECIFICATIONS). INTERPRETATION OF THE INFORMATION AS PRESENTED SHOULD BE BASED ON THE ENTIRE SET OF DOCUMENTS.

DRAWING TITLE


SYMBOLS, ABBREVIATIONS & GEN. NOTES

A-001

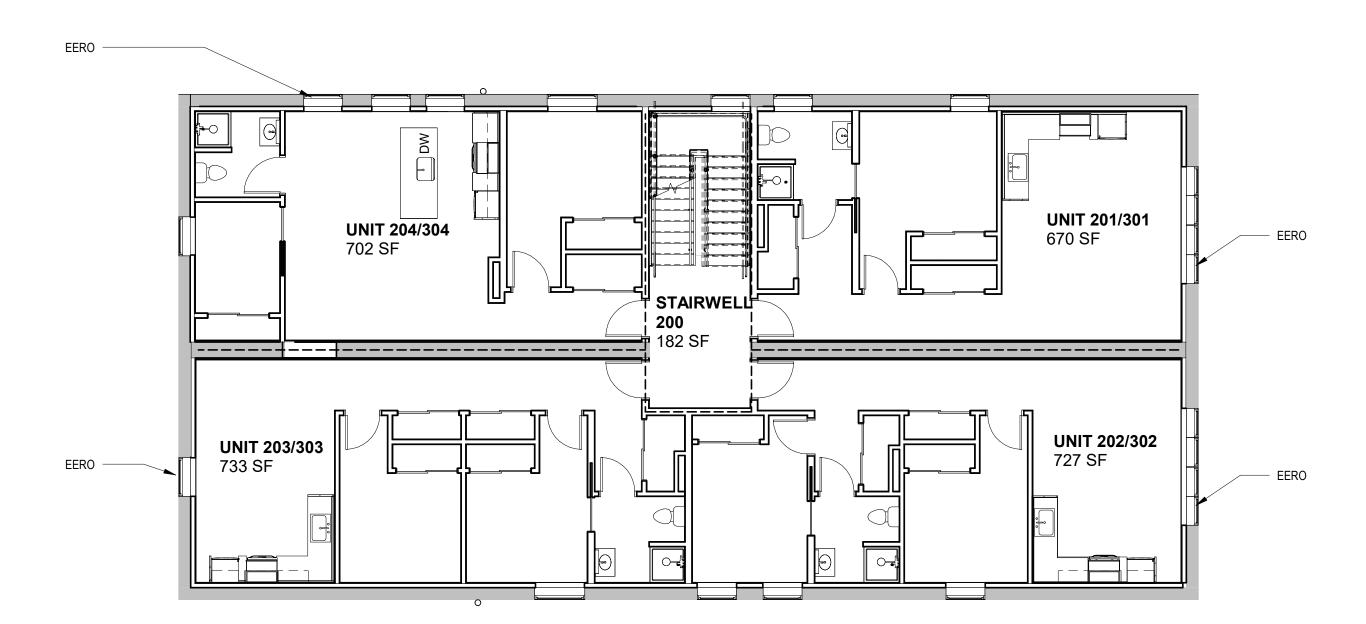

2 SECOND AND THIRD FLOOR PLAN LS-01 1/8" = 1'-0"

LS-01 1/8" = 1'-0"

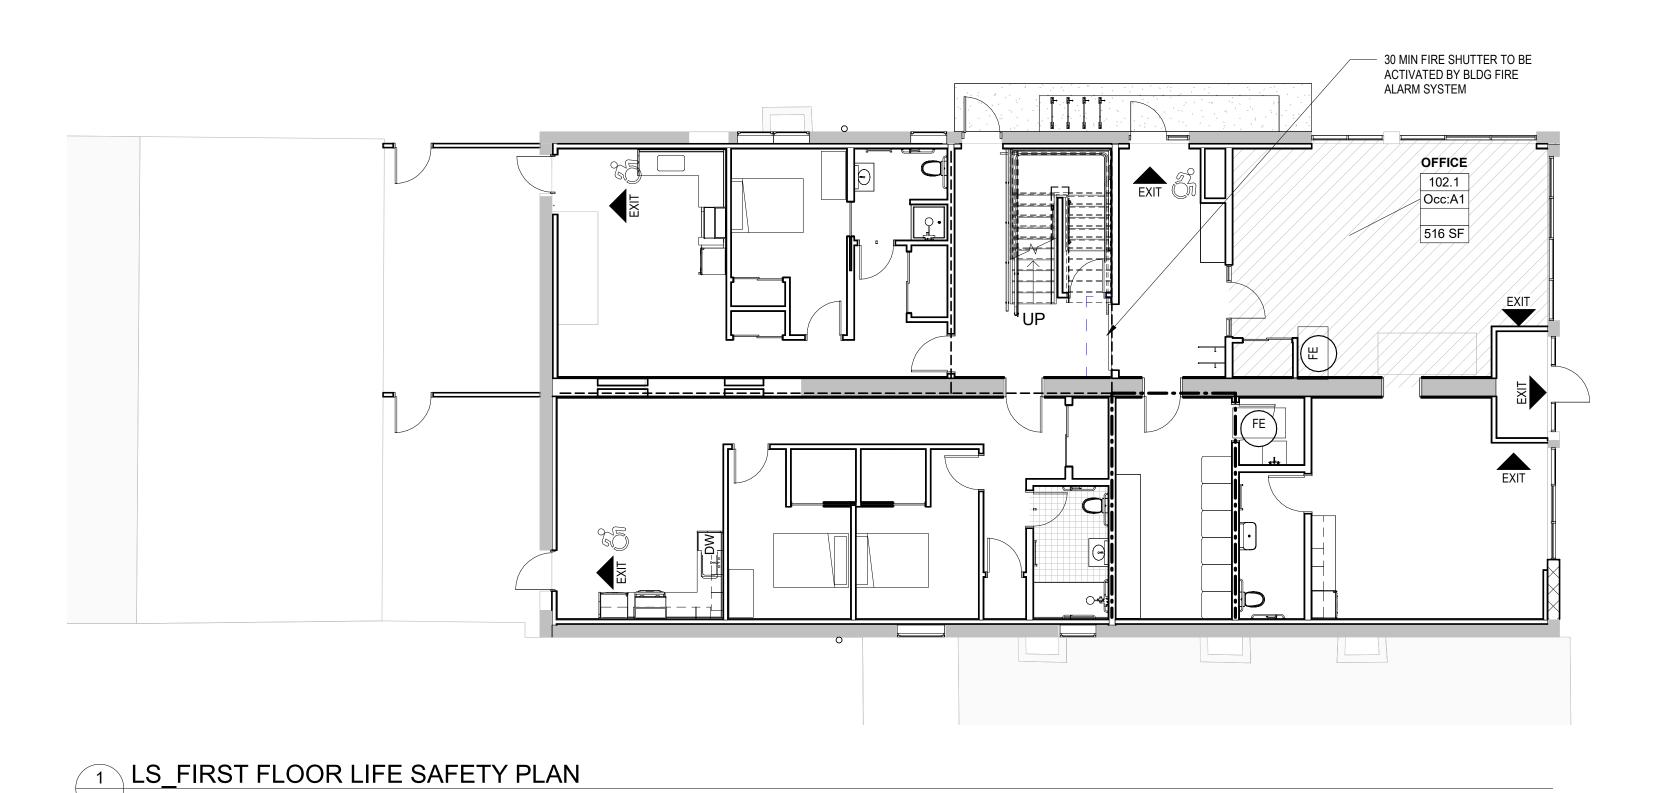

ALL SYMBOLS NOT NECESSARILY USED

_____ ___ 1/2-HR RATED PARTITION - MIN 50 STC RATING @ COORIDOR/RES UNITS

TRAVEL DISTANCE

— — — MIN. 50 STC RATED DEMISING WALL

EXIT O

ADA ACCESSIBLE ENTRANCE

CODE REVIEW LEGEND

— • — • — 1-HR RATED PARTITION

EXIT LOCATION

ADA ACCESSIBLE RESTROOM

CABINET

SEMI-RECESSED FIRE EXTINGUISHER

CODE REVIEW NOTES

PROJECT CLASSIFICATION:

EXISTING BUILDING - ALTERATION LEVEL 3 MIXED USE - NON-SEPARATED OCCUPANCY CLASSIFICATION: R-2 (MORE RESTRICTIVE) B (OFFICE SPACE) - BUSINESS USE

(BCNYS 304.1) R-2 - APARTMENT HOUSE (BCNYS 310.1)

CONSTRUCTION TYPE CLASSIFICATION: IIIB

BUILDING HEIGHTS AND AREAS: R-2 (MOST RESTRICTIVE)

ALLOWABLE <u>ACTUAL</u>

3 STORIES/37'

(BCNYS 708.3)

EXCEPTION 2

+/- 3,214 SF

AREA **FIRE RATING FOR:**

DWELLING UNIT SEPARATION: 1/2 HR

HEIGHT

NON-SEPARATED OCC.: B/R2/A2 = 0 HR (BCNYS 508.3.2)

(EBCNYS TABLE 805.3.1.1(2) STAIR & ELEVATOR ENCLOSURES: 3 STORIES - 1/2 HOUR

5 STORIES/75'

48,000 SF

CORRIDORS: .5 HRS - R2 OCC. W/ SPRINKLERS (BCNYS TABLE 1017.1) BUILDING ELEMENTS (FIRE RATINGS): (BCNYS TABLE 601)

CONSTRUCTION TYPE: STRUCTURAL FRAME INT. BEARING WALLS EXT. BEARING WALLS EXT. NON BEARING WALLS EXIST. TO REMAIN PER EXISTING BUILDING CODE

SECTION 912.6 INT. NON BEARING WALLS FLOOR CONSTRUCTION ROOF CONSTRUCTION

OCCUPANCY LOAD: (BCNYS TABLE 1004.1.1)

> 0 - NOT OCCUPIABLE DUE TO HEAD HEIGHT < 7' R2 = 2,168 SF/ 200 SF PER OCC. = 11 OCC. B = 1,039 SF/ 150 SF PER OCC. = 7 OCC.

TOTAL OCCUPANTS = 18 -2ND & 3RD FLOOR: 16 PER FLOOR - 3,214 SF / 200 SF PER OCC. - R-2

EGRESS REQUIREMENTS (BCNYS TABLE 1061.1)

EXITS: BASEMENT - 1 EXITS REQUIRED FIRST FLOOR - 2 EXITS REQUIRED 2ND & 3RD FLOOR - 1 EXITS REQUIRED*

-BASEMENT:

-FIRST FLOOR:

* PER TABLE 805.3.1.1(2) OF THE EXISTING BUILDING CODE OF NYS ONLY 1 EXIT IS REQUIRED PERMITTED THE FOLLOWING(3 STORY BUILDING WITH SPRINKLERS):

MAXIMUM OF (4) DWELLING UNITS & 3,500 SF PER FLOOR EXIT ACCESS TRAVEL DISTANCE OF 75' OR LESS MINIMUM OF (1) EERO PER FLOOR ((1) PER UNIT PROVIDED) 1/2 HOUR RATED SHAFT AND EXIT ENCLOSURES INTERIOR FINISHES PER 803 & 804 OF THE BCNYS 1/2 HOUR RATED INCIDENTAL USE AREAS ELEC BRANCH CIRCUITS MEETING NFPA 70 REQ'S MANUAL FIRE ALARM SYSTEM SMOKE ALARMS WITHIN DWELLING UNITS PER 907 OF THE BCNYS

ELEC SUPERVISED QUICK RESPONSE WET PIPE SPRINKLER

SYSTEM REF. PLANS FOR BUILDING AND TENANT EXIT LOCATIONS

TRAVEL DISTANCE: <300' IN OCC. B - SPRINKLERED BLDG

<250' IN OCC. R2 - SPRINKLERED BLDG MAX COMMON PATH OF EGRESS: R2 - 125' PER 1006.3.3

EGRESS WIDTH: (BCNYS TABLE 1005.1)

STAIRS - EXISTING TO REMAIN

OTHER COMPONENTS - 0.15" PER OCC. -NOT LESS THAN 44" TO BE PROVIDED @ CORRIDORS AND 34" AT DOORS (BCNYS 1017.2)

FIRE PROTECTION:

SPRINKLER SYSTEM: PROVIDED - NFPA 13

STANDPIPES: NOT REQ'D, NOT PROVIDED

FIRE ALARM SYSTEM: PROVIDED BASEMENT/1ST FLOOR BUSINESS - NONE REQ'D R2 OCC (1ST, 2ND, 3RD FLOORS) - MANUAL SYSTEM PER BCNYS 907.2.9

FIRE EXTINGUISHERS: TO BE PROVIDED (FCNYS 906) BASEMENT/1ST FLOOR - LIGHT HAZARD, EXTINGUISHERS TO BE LOCATED AS SHOWN ON PLANS IN COMMON SPACES, LOCATIONS WITHIN TENANT SPACES TBD BASED ON FINAL TENANT LAYOUTS.

R-2 - LIGHT HAZARD, 1A EXTINGUISHERS TO BE PROVIDED IN EA RESIDENTIAL UNIT KITCHEN.

ADA REQUIREMENTS:

FIRST FLOOR UNITS TO BE TYPE 'B' UNITS RESIDENTIAL UNITS:

> FLOORS 2 & 3 - NOT ACCESSIBLE (NO ELEVATOR ACCESS), NO ADA REQUIREMENTS

ENERGY CODE:

ERIE COUNTY - ZONE 5A

BUILDING ENVELOPE REQUIREMENTS: MASS WALLS ABOVE GRADE - R13.3ci ROOF (INSUL. ABOVE ROOF DECK) - R30ci

FENESTRATION: U-FACTOR: FIXED: 0.38 OPERABLE: 0.45 ENTRANCE DOORS: 0.77


SHGC: PF<0.2: 0.38


> ORIGINAL DOCUMENT PRODUCED IN COLOR - DO NOT REPRODUCE IN BLACK & WHITE, DO NOT UTILIZE

FOR CONSTRUCTION PURPOSES IF REPRODUCED IN BLACK & WHITE.



BUFFALO | ROCHESTER www.cjsarchitects.com

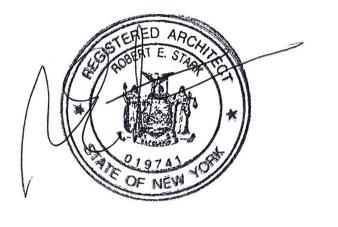

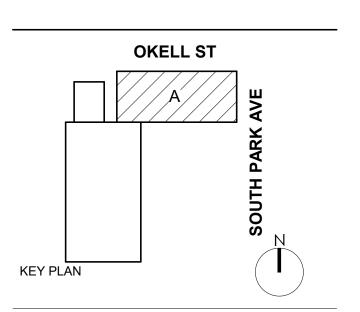

DOFI PROPERTIES

SOUTH PARK MIXED USE

2221 SOUTH PARK AVE BUFFALO, NY 14220

DESCRIPTION DATE

JOB NO. 2508 SCALE As indicated ISSUE DATE 08/04/25 JC DRAWN BY CHECKED BY RES

> THIS IS A SINGLE SHEET OF A COHESIVE SET OF CONSTRUCTION DOCUMENTS (INCLUDING DRAWINGS AND SPECIFICATIONS). INTERPRETATION OF THE INFORMATION AS PRESENTED SHOULD BE BASED ON THE ENTIRE SET OF DOCUMENTS.

DRAWING TITLE

LIFE SAFETY

LS-01


DEMO PLAN LEGEND ALL SYMBOLS NOT NECESSARILY USED **EXISTING WALL TO REMAIN** EXISTING WALL TO BE REMOVED **NEW CONSTRUCTION - REFER TO WALL TYPES** EXISTING DOOR TO BE REMOVED NEW DOOR - SEE DOOR SCHEDULE FOR ADDITIONAL INFORMATION

KEYNOTES - DEMOLITION

- D1 DEMO EXISTING STAIRCOORD. REMOVAL W/ OTHER CONSTRUCTION ACTIVITIES AND TEMP. VERT CIRCULATION NEEDS
- 2 REMOVE EXISTING WINDOW WELL AND INFILL OPENING
- REMOVE EXISTING DOOR AND INFILL OPENING
- D4 DEMO EXISTING GWB, POLY VAPOR BARRIER, INSULATION, AND ANY WATER DAMAGED STUDS AT
- EXISTING EXTERIOR WALL FURRING. EXISTING STUDS IN GOOD CONDITOIN ARE TO REMAIN. INFILL STUD FRAMING/FURRING WHERE NEEDED TO FACILITATE NEW INSULATION AND DRYWALL INSTALL.
- REMOVE ALL EXISTING PLUMBING FIXTURES REFER TO GENERAL NOTES FOR ADDITIONAL MEP
- D6 REMOVE GWB, WALL FURRING AND INSULATION COMPLETELY TO INTERIOR PARTITION
- D7 REMOVE EXISTING WINDOW ASSEMBLY AND MECHANICAL UNIT DOWN TO MASONRY OPENING

D9 DEMO EXISTING DOOR AND SAWCUT ENLARGED OPENING - COORD. W/ STRUC. ON LINTEL

- REQUIREMENTS
- D10 DEMO EXISTING INFILL AND PREP OPENING FOR NEW STOREFRONT ASSEMBLY- COORD. EXTENTS W/
- D11 DEMO INFILL AND PREP OPENING FOR NEW WINDOW ASSEMBLY COORD. EXTENTS WITH PLANS
- D12 SAWCUT NEW OPENING D13 SAWCUT MASONRY OPENING AND PREP FOR NEW DOOR ASSEMBLY
 - D14 DEMO EXISTING STOREFRONT AND PREP FOR NEW ASSEMBLY
 - D15 DEMO EXISTING PENTHOUSE DOWN TO DECK AND PREP OPENING FOR INFILL
 - D16 DEMO EXISTING ROOF DECK DOWN TO RAFTERS AND PREP FOR NEW ROOF ASSEMBLY D17 DEMO EXISTING SCUPPER AND PREP FOR NEW
 - D19 DEMO EXISTING DOOR AND PREP FOR NEW DOOR ASSEMBLY
- D20 DEMO EXISTING FLOOR FINISH DOWN TO SUBFLOOR
- D21 CUT PENTRATION IN EXISTING FLOOR FOR NEW STAIRWELL PROVIDE ALL NECESSARY SHORING + COORD. W/ STRUC. DWGS
- D22 CUT EXISTING FLOOR/ROOF FOR NEW CHASE PENETRATION. ALL EXISTING STRUCTURAL MEMBERS
- TO REMAIN IN PLACE, COORDINATE WITH ARCHITECT IF CONFLICT ARISES.
- D23 CUT EXISTING ROOF AND RAFTER FOR NEW ROOF HATCH. ALL STRUCTURAL MEMBERS TO BE BRACED AND BLOCKED OFF- COOR. W/ STRUCT DWGS
- D25 COORD. REMOVAL OF WALL W/ NEW ROOF FRAMING INSTALL. REF. TO STRUCT. DWGS
- D26 REMOVE EXISTING ROOFING IN ITS ENTIRETY INCLUDING ALL FLASHINGS, COPINGS ETC. COORD. W/
- HAZARDOUS MATERIALS REPORT FOR ANY REGULATED BUILDING MATERIALS, CONTRACT W/ LICENSED ABATEMENT CONTRACTOR FOR REMOVAL OF SUCH ITEMS

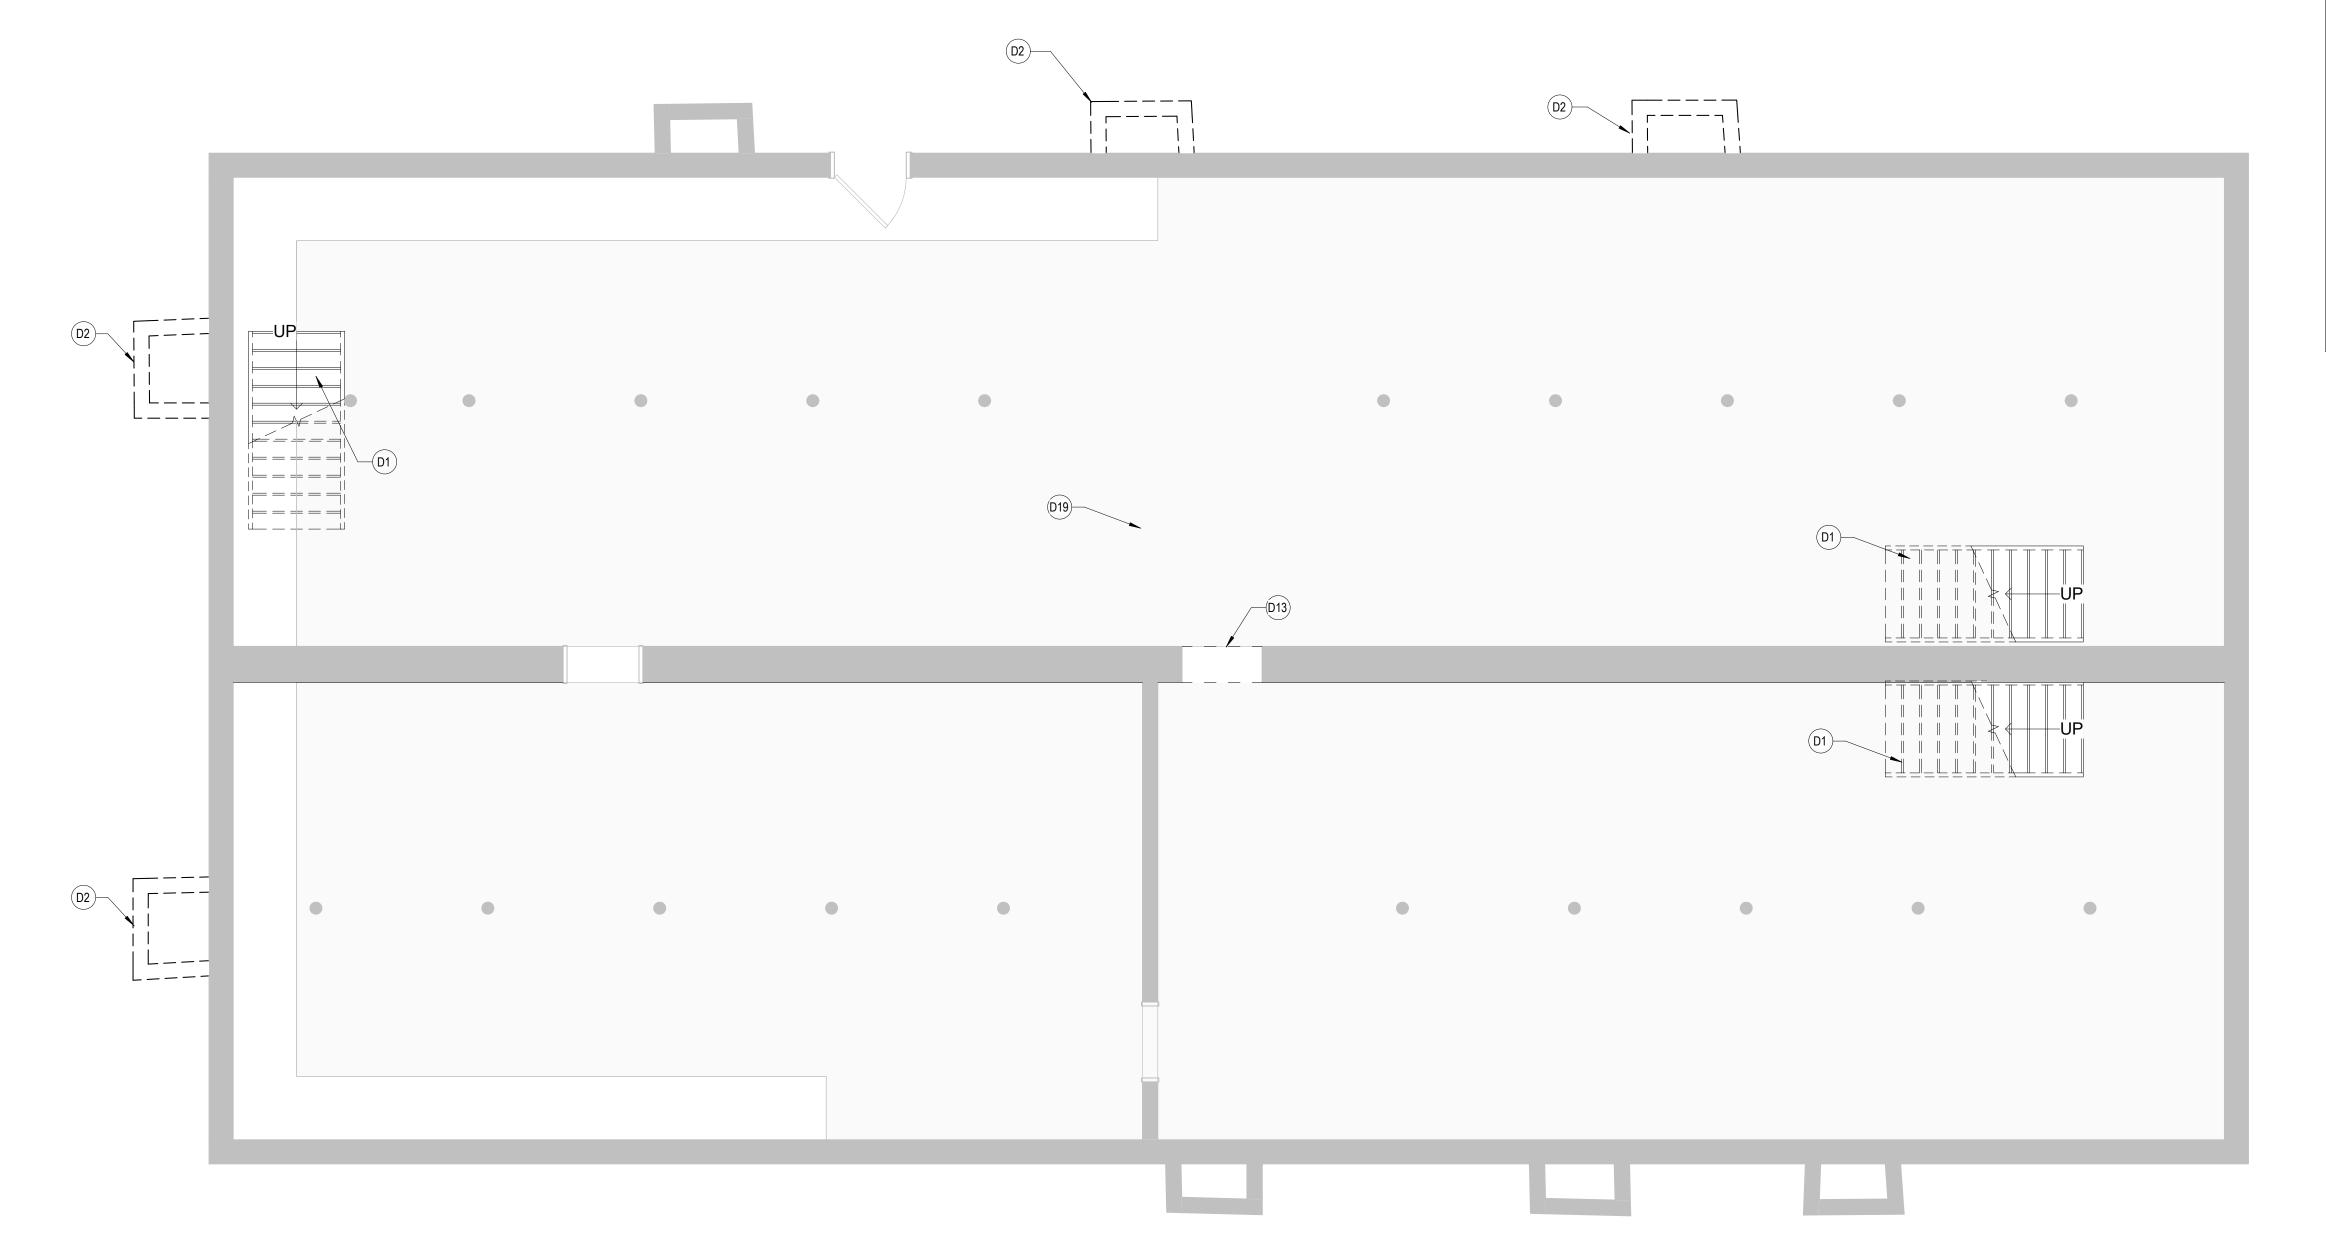

BASEMENT FLOOR PLAN D-100 1/4" = 1'-0"

GENERAL DEMOLITION NOTES

- REFERENCE A001 FOR GENERAL NOTES.
- REFER TO MEP DWG'S TO COORDINATE DEMOLITION WORK REQUIRED FOR NEW PENETRATIONS REQUIRED BY NEW UTILITY WORK.
- THE CONTRACT DOCUMENTS ARE COMPLIMENTARY TO EACH OTHER. WHAT IS REQUIRED FOR ONE DRAWING SHALL BE AS BINDING AS IF REQUIRED FOR ALL. DEMOLITION IS NOT NECESSARILY LIMITED TO WHAT IS SHOWN ON DRAWINGS. THE INTENT IS TO INDICATE THE GENERAL SCOPE OF DEMOLITION REQUIRED
- TO COMPLETE THE WORK IN ACCORDANCE WITH THE CONTRACT DRAWINGS. THE CONTRACTOR SHALL NOT ENCUMBER AREAS OUTSIDE OF CONTRACT
- LIMIT LINES WITH DEBRIS OR MATERIALS. THE CONTRACTOR SHALL MAINTAIN THE AREA IN A SAFE MANNER TO ENSURE
- THE SAFETY OF STAFF AND CONSTRUCTION PERSONNEL AND NOT ALLOW INTERRUPTION OF TRAFFIC FLOW. THE CONTRACTOR SHALL NOT ALLOW DEBRIS TO ACCUMULATE. ALL DEBRIS
- SHALL BE REMOVED FROM THE AREA AT THE END OF EACH DAY. ALL COMBUSTIBLE MATERIALS / DEBRIS SHALL BE IMMEDIATELY REMOVED FROM THE AREA. ALL DEBRIS REMOVAL SHALL BE PERFORMED IN ACCORDANCE WITH BUILDING OWNER REQUIREMENTS AND PROCEDURES.
- THE CONTRACTOR SHALL REMOVE AND LEGALLY DISPOSE OF ALL DEBRIS. THE CONTRACTOR SHALL COORDINATE WITH THE BUILDING OWNER / MANAGER & TENANT, AREAS TO BE USED FOR STAGING, MATERIAL DELIVERY, DEBRIS REMOVAL, ETC. PRIOR TO START OF DEMOLITION.
- THE CONTRACTOR SHALL VERIFY ALL CONDITIONS AND DIMENSIONS IN FIELD AND BRING ANY DISCREPANCIES TO THE ATTENTION OF THE ARCHITECT AND OWNER, PRIOR TO THE BID.
- SHOULD HAZARDOUS MATERIALS BE ENCOUNTERED, THE CONTRACTOR SHALL STOP WORK, SEAL THE AREA, AND REPORT CONDITION TO THE OWNER AND THE ARCHITECT AND DO NO WORK UNTIL THE CONDITION IS CORRECTED. HAZARDOUS MATERIALS INCLUDE BUT ARE NOT LIMITED TO: MOLD, ASBESTOS, PIPE COVERING (INSULATION), VINYL ASBESTOS TILE, AND LEAD BASE PAINT.
- REMOVE FLOOR FINISHES WHERE NOTED. REMOVE ALL EXISTING IRREGULAR MATERIALS WHICH CAUSE RISES OR DEPRESSIONS IN FLOORING SURFACE, SUCH AS FASTENERS, OUTLET CORES, COVER PLATES, RESILIENT FLOOR COVERINGS, CARPET, CARPET PAD, FLASH
- PATCH CONCRETE FILL, PLYWOOD, ETC.. PATCH AND/OR REPLACE ANY SURFACE THAT IS DAMAGED DURING THE DEMOLITION PHASE, OR DAMAGED WALLS AND COLUMNS THAT ARE TO
- AT COMPLETION OF DEMOLITION WORK, THE CONSTRUCTION AREAS SHALL BE LEFT IN "BROOM CLEAN" CONDITION. ALL DEBRIS AND MISCELLANEOUS
- MATERIAL SHALL BE REMOVED. COORDINATE ALL DEMOLITION WORK W/ HAZARDOUS MATERIAL REPORT. ALL DEMOLITION DEBRIS SHALL BECOME THE PROPERTY OF THE CONTRACTOR UNLESS SPECIFICALLY NOTED TO BE SALVAGED, WHEREIN IT REMAINS THE


PROPERTY OF THE OWNER. THE OWNER RESERVES THE RIGHT TO REQUEST

- ITEMS BE SALVAGED DURING THE DURATION OF THE WORK OF THIS PROJECT. THE CONTRACTOR SHALL PROVIDE BARRIER PARTITION CONSTRUCTION TO CONTAIN DUST, MAINTAIN BUILDING SECURITY AND WEATHER TIGHTNESS. SEAL PARTITIONS AT FLOOR, ADJACENT WALLS AND TO DECK ABOVE. PROVIDE
- NECESSARY EGRESS DOORS AND HARDWARE PER EGRESS REQUIREMENTS. COORDINATE SIZE AND LOCATION OF FLOOR REMOVALS WITH NEW WORK. FOR ALL ITEMS CALLED OUT TO BE DEMOLISHED PROVIDE COMPLETE DEMOLITION SCOPE REMOVING ALL ASSOCIATED ATTACHMENTS AND
- ADHESIVES COMPLETE. PREPARE SURFACES TO RECEIVE NEW CONSTRUCTION.
- REFERENCE D104 FOR ROOF INFORMATION.
- REMOVE ALL EXISTING CEILING TILES UNLESS OTHERWISE NOTED. IT IS THE INTENT OF THESE DEMO DRAWINGS FOR ALL MECHANICAL. ELECTRICAL, PLUMBING, AND FIRE PROTECTION (MEPFP) EQUIPMENT, PIPING, CONDUIT, WIRING, FIXTURES, ETC. TO BE REMOVED ON FLOORS 1-3. ITEMS IN
- THE BASEMENT SHALL BE REMOVED AS COORDINATED WITH THE FINAL MEPFP DRAWINGS AND ITEMS INDICATED TO BE EXISTING TO REMAIN. REFER TO PHASE ONE DEMO SET (7/21/25) DWGS FOR PREVIOUSLY REMOVED
- REMOVE ALL ABANDONED VENTS, LIGHTING, CONDUIT ETC. ON EXTERIOR FACADES. V.I.F.



BUFFALO | ROCHESTER www.cjsarchitects.com



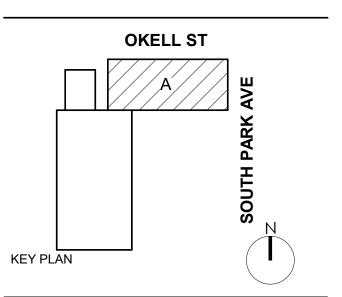

DOFI PROPERTIES

SOUTH PARK MIXED USE

2221 SOUTH PARK AVE BUFFALO, NY 14220

DATE

DESCRIPTION

JOB NO.	2508
SCALE	1/4" = 1'-0'
ISSUE DATE	08/04/25
DRAWN BY	Gad
CHECKED BY	JMC


THIS IS A SINGLE SHEET OF A COHESIVE SET OF CONSTRUCTION DOCUMENTS (INCLUDING DRAWINGS AND SPECIFICATIONS). INTERPRETATION OF THE INFORMATION AS PRESENTED SHOULD BE BASED ON THE ENTIRE SET OF DOCUMENTS.

DRAWING TITLE

REV.#

DEMO BASEMENT **PLAN**

D-100

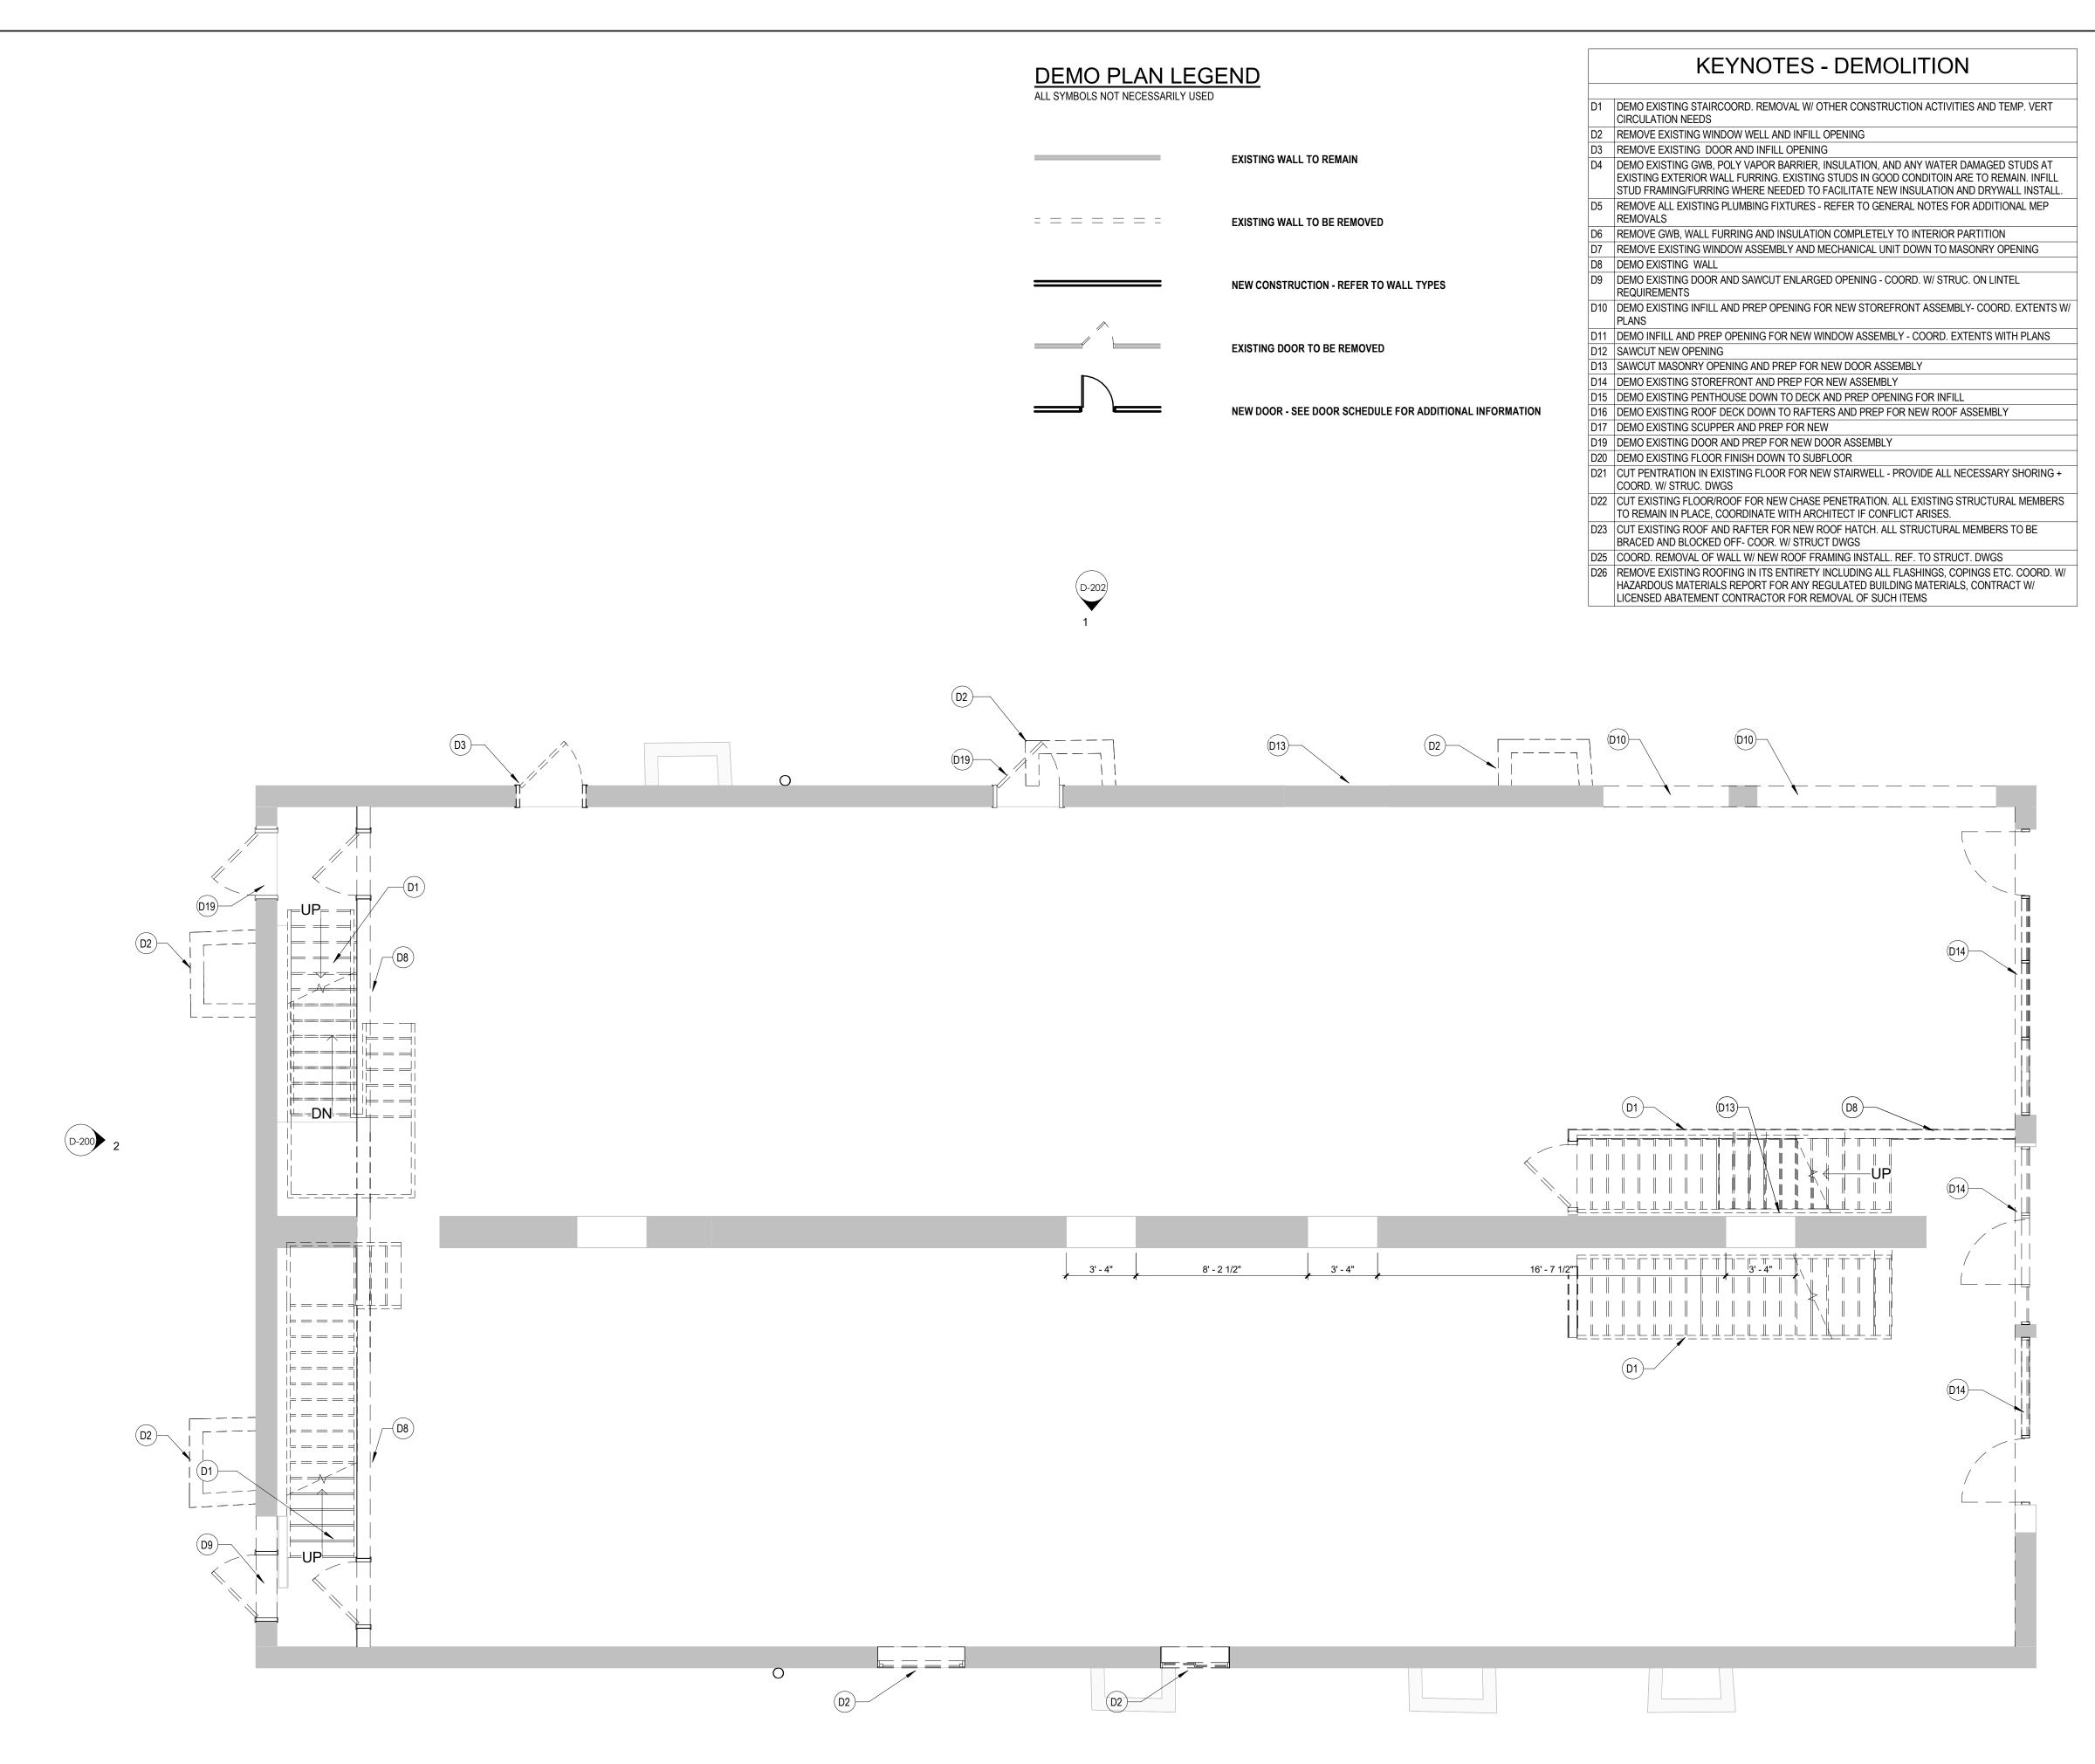

GENERAL DEMOLITION NOTES

- REFERENCE A001 FOR GENERAL NOTES.
- REFER TO MEP DWG'S TO COORDINATE DEMOLITION WORK REQUIRED FOR NEW PENETRATIONS REQUIRED BY NEW UTILITY WORK.
- THE CONTRACT DOCUMENTS ARE COMPLIMENTARY TO EACH OTHER. WHAT IS REQUIRED FOR ONE DRAWING SHALL BE AS BINDING AS IF REQUIRED FOR ALL. DEMOLITION IS NOT NECESSARILY LIMITED TO WHAT IS SHOWN ON DRAWINGS.
- THE INTENT IS TO INDICATE THE GENERAL SCOPE OF DEMOLITION REQUIRED TO COMPLETE THE WORK IN ACCORDANCE WITH THE CONTRACT DRAWINGS. THE CONTRACTOR SHALL NOT ENCUMBER AREAS OUTSIDE OF CONTRACT
- LIMIT LINES WITH DEBRIS OR MATERIALS. THE CONTRACTOR SHALL MAINTAIN THE AREA IN A SAFE MANNER TO ENSURE THE SAFETY OF STAFF AND CONSTRUCTION PERSONNEL AND NOT ALLOW
- INTERRUPTION OF TRAFFIC FLOW. THE CONTRACTOR SHALL NOT ALLOW DEBRIS TO ACCUMULATE. ALL DEBRIS SHALL BE REMOVED FROM THE AREA AT THE END OF EACH DAY. ALL COMBUSTIBLE MATERIALS / DEBRIS SHALL BE IMMEDIATELY REMOVED FROM THE AREA. ALL DEBRIS REMOVAL SHALL BE PERFORMED IN ACCORDANCE WITH BUILDING OWNER REQUIREMENTS AND PROCEDURES.
- THE CONTRACTOR SHALL REMOVE AND LEGALLY DISPOSE OF ALL DEBRIS. THE CONTRACTOR SHALL COORDINATE WITH THE BUILDING OWNER / MANAGER & TENANT, AREAS TO BE USED FOR STAGING, MATERIAL DELIVERY, DEBRIS
- REMOVAL, ETC. PRIOR TO START OF DEMOLITION. THE CONTRACTOR SHALL VERIFY ALL CONDITIONS AND DIMENSIONS IN FIELD AND BRING ANY DISCREPANCIES TO THE ATTENTION OF THE ARCHITECT AND OWNER, PRIOR TO THE BID.
- SHOULD HAZARDOUS MATERIALS BE ENCOUNTERED, THE CONTRACTOR SHALL STOP WORK, SEAL THE AREA, AND REPORT CONDITION TO THE OWNER AND THE ARCHITECT AND DO NO WORK UNTIL THE CONDITION IS CORRECTED. HAZARDOUS MATERIALS INCLUDE BUT ARE NOT LIMITED TO: MOLD, ASBESTOS, PIPE COVERING (INSULATION), VINYL ASBESTOS TILE, AND LEAD BASE PAINT. REMOVE FLOOR FINISHES WHERE NOTED.
- REMOVE ALL EXISTING IRREGULAR MATERIALS WHICH CAUSE RISES OR DEPRESSIONS IN FLOORING SURFACE, SUCH AS FASTENERS, OUTLET CORES, COVER PLATES, RESILIENT FLOOR COVERINGS, CARPET, CARPET PAD, FLASH PATCH CONCRETE FILL, PLYWOOD, ETC..
- PATCH AND/OR REPLACE ANY SURFACE THAT IS DAMAGED DURING THE DEMOLITION PHASE, OR DAMAGED WALLS AND COLUMNS THAT ARE TO
- AT COMPLETION OF DEMOLITION WORK, THE CONSTRUCTION AREAS SHALL BE
- LEFT IN "BROOM CLEAN" CONDITION. ALL DEBRIS AND MISCELLANEOUS MATERIAL SHALL BE REMOVED. COORDINATE ALL DEMOLITION WORK W/ HAZARDOUS MATERIAL REPORT. ALL DEMOLITION DEBRIS SHALL BECOME THE PROPERTY OF THE CONTRACTOR UNLESS SPECIFICALLY NOTED TO BE SALVAGED, WHEREIN IT REMAINS THE
- PROPERTY OF THE OWNER. THE OWNER RESERVES THE RIGHT TO REQUEST ITEMS BE SALVAGED DURING THE DURATION OF THE WORK OF THIS PROJECT. THE CONTRACTOR SHALL PROVIDE BARRIER PARTITION CONSTRUCTION TO CONTAIN DUST, MAINTAIN BUILDING SECURITY AND WEATHER TIGHTNESS.
- SEAL PARTITIONS AT FLOOR, ADJACENT WALLS AND TO DECK ABOVE. PROVIDE NECESSARY EGRESS DOORS AND HARDWARE PER EGRESS REQUIREMENTS. COORDINATE SIZE AND LOCATION OF FLOOR REMOVALS WITH NEW WORK. FOR ALL ITEMS CALLED OUT TO BE DEMOLISHED PROVIDE COMPLETE DEMOLITION SCOPE REMOVING ALL ASSOCIATED ATTACHMENTS AND
- ADHESIVES COMPLETE. PREPARE SURFACES TO RECEIVE NEW CONSTRUCTION. REFERENCE D104 FOR ROOF INFORMATION.

FACADES. V.I.F.


1 (D-200)


- REMOVE ALL EXISTING CEILING TILES UNLESS OTHERWISE NOTED. IT IS THE INTENT OF THESE DEMO DRAWINGS FOR ALL MECHANICAL. ELECTRICAL, PLUMBING, AND FIRE PROTECTION (MEPFP) EQUIPMENT, PIPING, CONDUIT, WIRING, FIXTURES, ETC. TO BE REMOVED ON FLOORS 1-3. ITEMS IN THE BASEMENT SHALL BE REMOVED AS COORDINATED WITH THE FINAL MEPFP
- DRAWINGS AND ITEMS INDICATED TO BE EXISTING TO REMAIN. REFER TO PHASE ONE DEMO SET (7/21/25) DWGS FOR PREVIOUSLY REMOVED

REMOVE ALL ABANDONED VENTS, LIGHTING, CONDUIT ETC. ON EXTERIOR



BUFFALO | ROCHESTER www.cjsarchitects.com

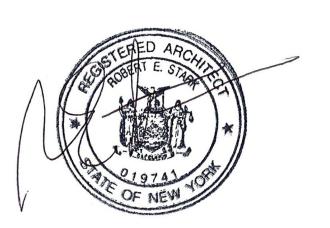

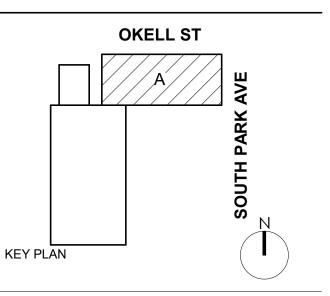

DOFI PROPERTIES

SOUTH PARK MIXED USE

2221 SOUTH PARK AVE BUFFALO, NY 14220

REV.# DESCRIPTION

JOB NO.	2508
SCALE	1/4" = 1'-0"
SSUE DATE	08/04/25
DRAWN BY	Gac
CHECKED BY	JMC


THIS IS A SINGLE SHEET OF A COHESIVE SET OF CONSTRUCTION DOCUMENTS (INCLUDING DRAWINGS AND SPECIFICATIONS) INTERPRETATION OF THE INFORMATION AS PRESENTED SHOULD BE BASED ON THE ENTIRE SET OF DOCUMENTS.

DRAWING TITLE

FIRST FLOOR **DEMOLITION** PLAN

D-101

1 FIRST FLOOR PLAN D-101 1/4" = 1'-0"

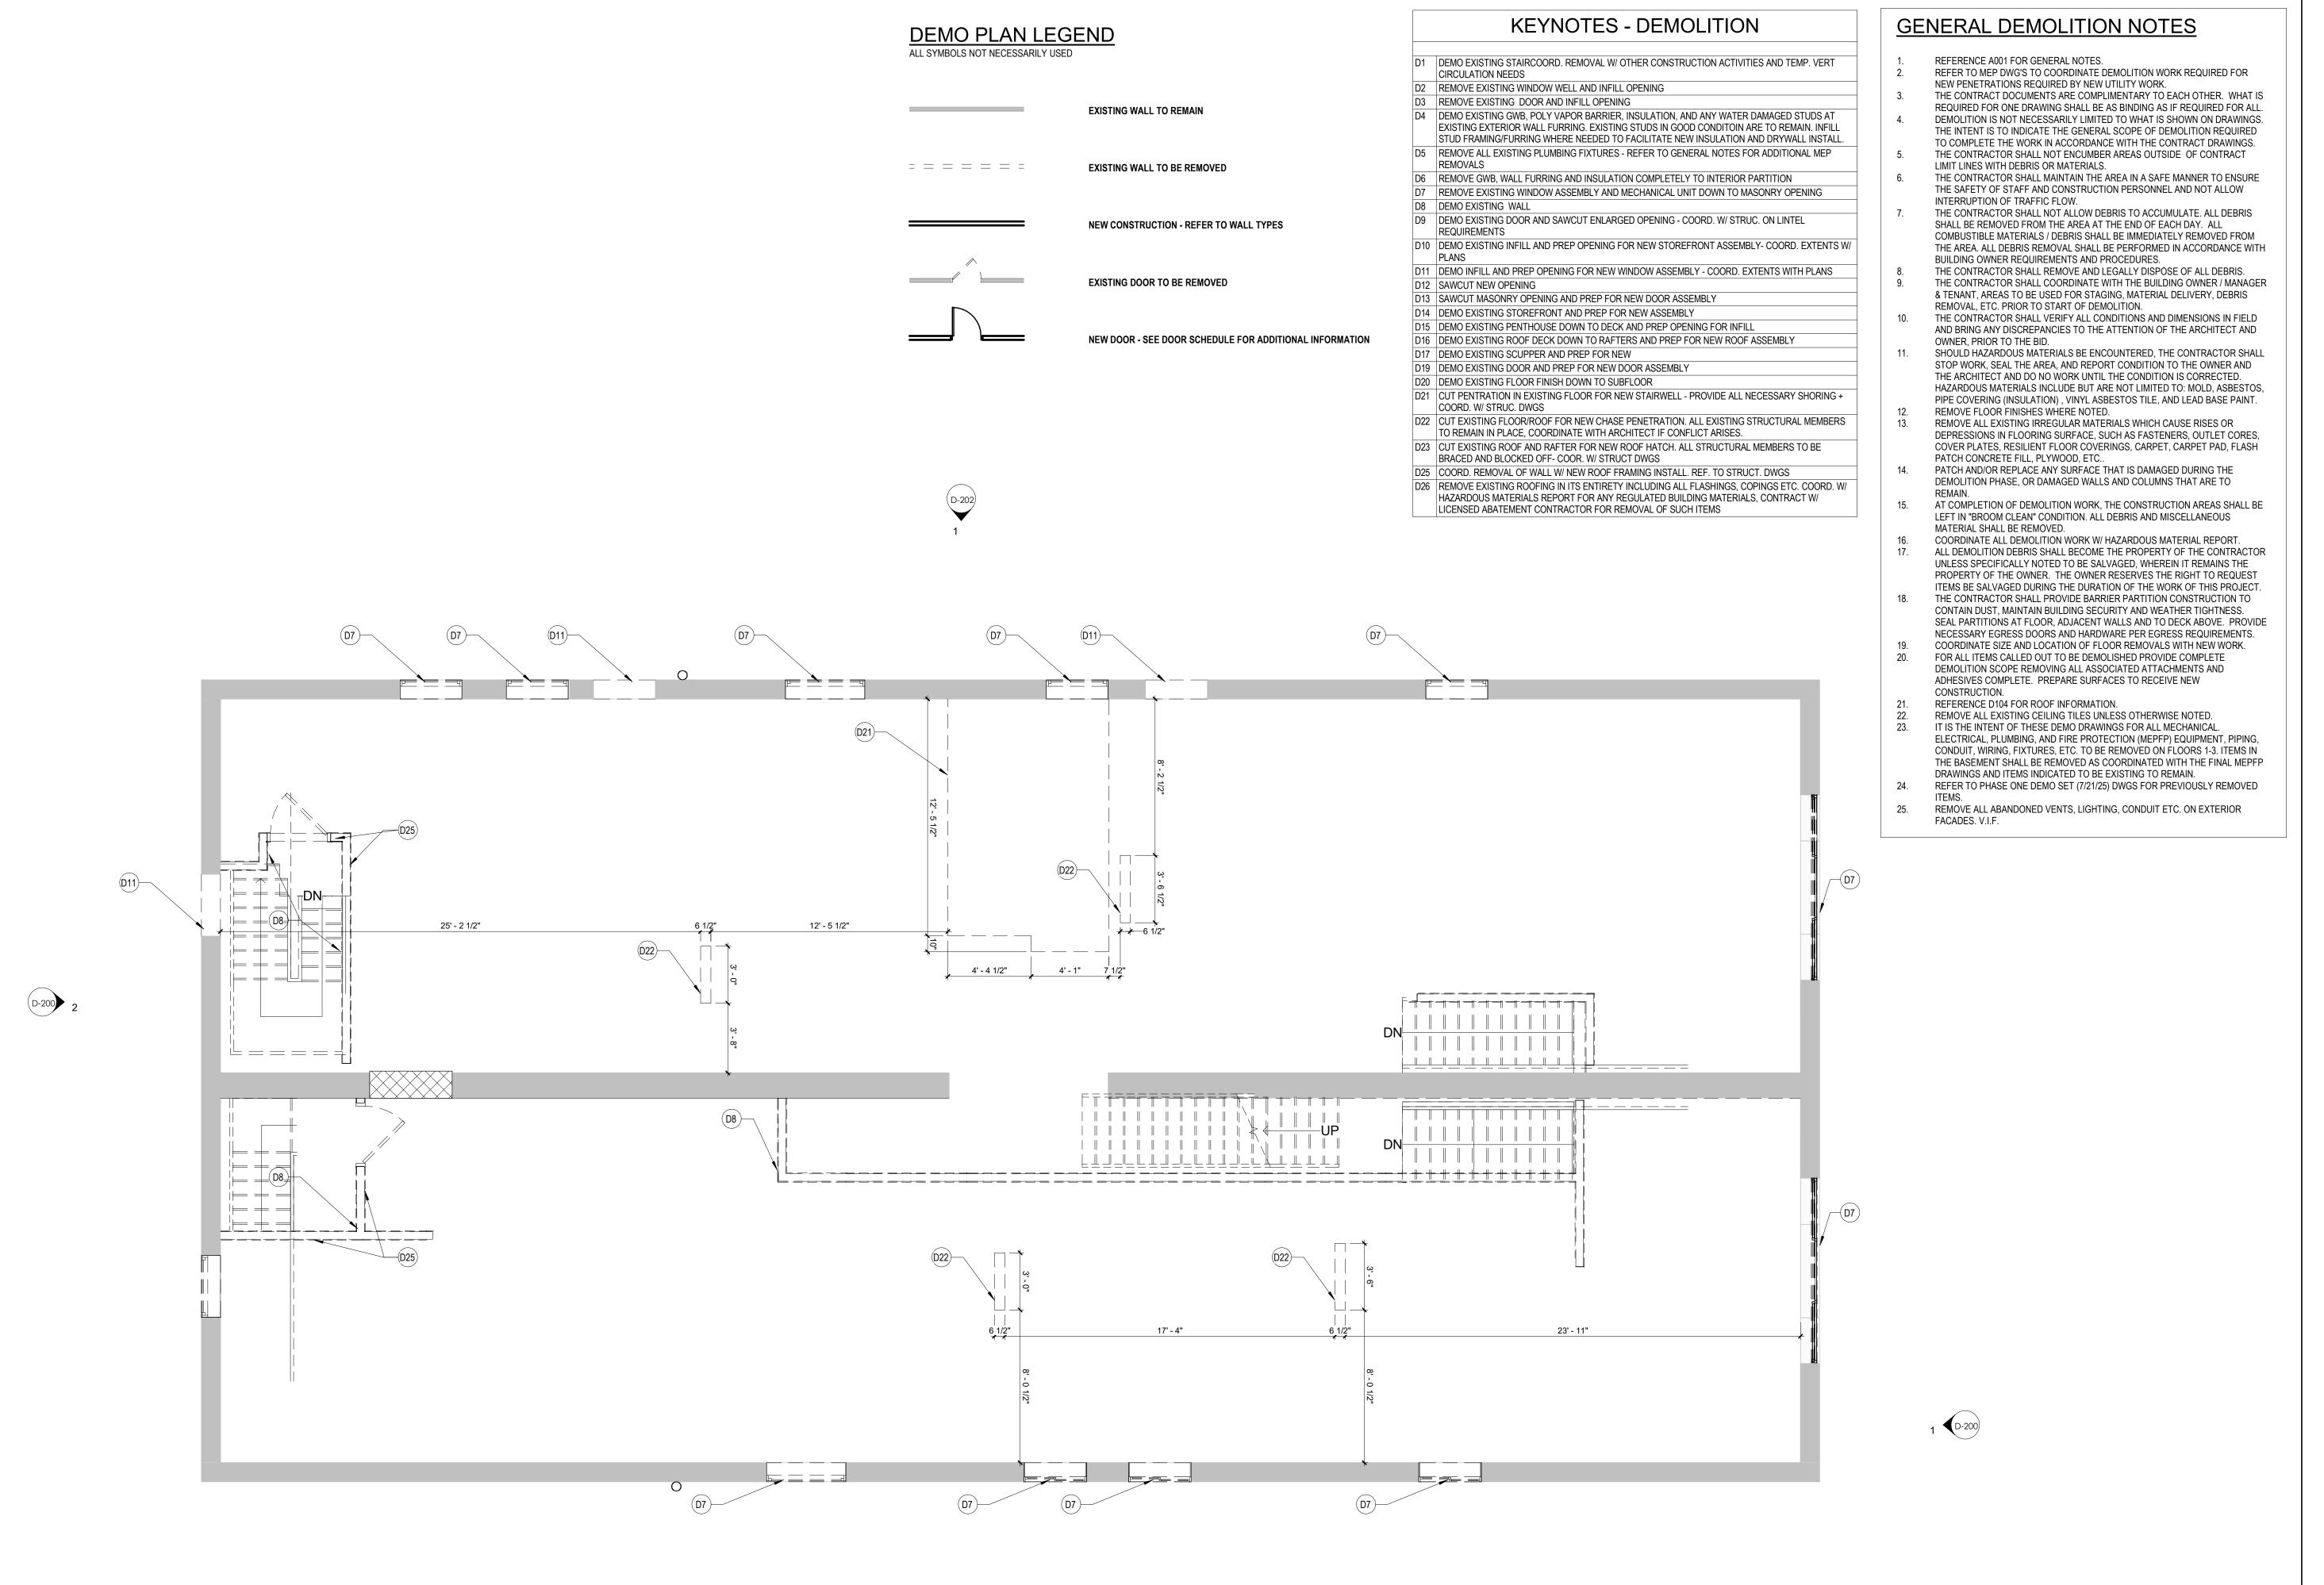

SOUTH PARK MIXED USE

OKELL ST

ARCHITECTS

BUFFALO | ROCHESTER

www.cjsarchitects.com

2221 SOUTH PARK AVE BUFFALO, NY 14220

REV. # DESCRIPTION DATE

JOB NO.	250
SCALE	1/4" = 1'-
ISSUE DATE	08/04/2
DRAWN BY	Ga
CHECKED BY	JM

THIS IS A SINGLE SHEET OF A COHESIVE SET OF CONSTRUCTION DOCUMENTS (INCLUDING DRAWINGS AND SPECIFICATIONS). INTERPRETATION OF THE INFORMATION AS PRESENTED SHOULD BE BASED ON THE ENTIRE SET OF DOCUMENTS.


DRAWING TITLE

SECOND FLOOR PLAN


D-102 1/4" = 1'-0"

SECOND FLOOR DEMO PLAN

D-102

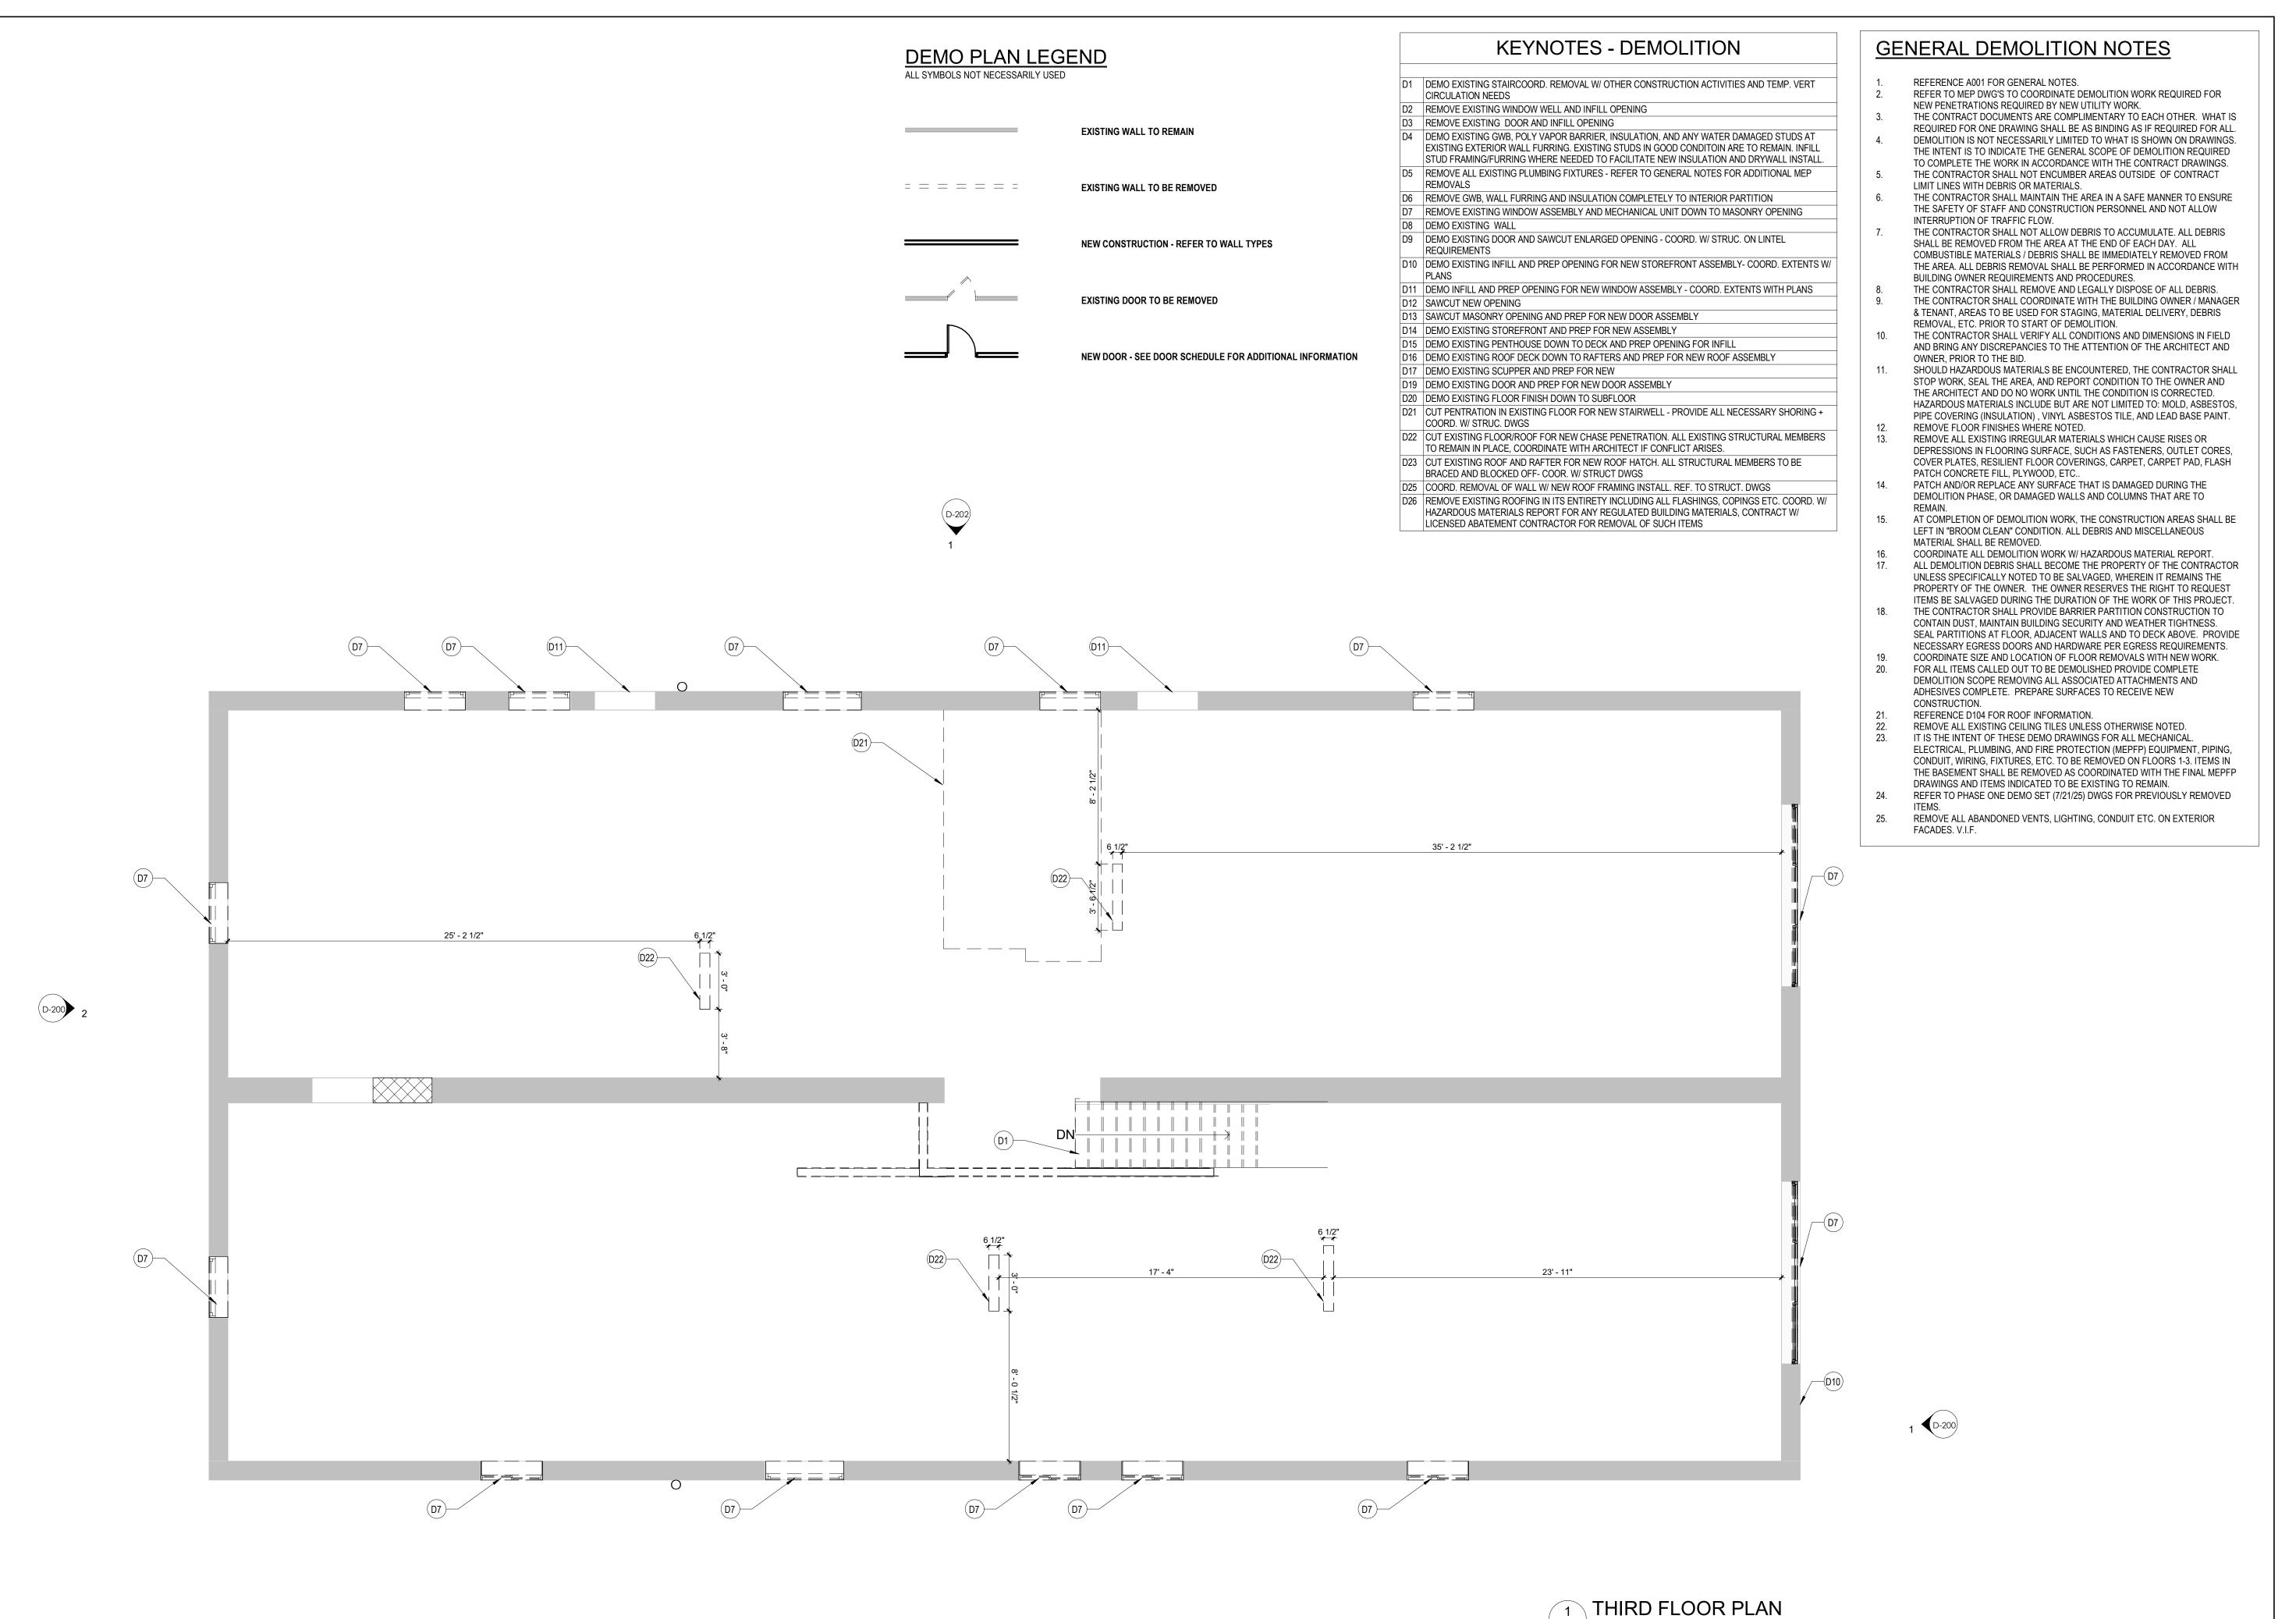

D-103/ 1/4" = 1'-0"

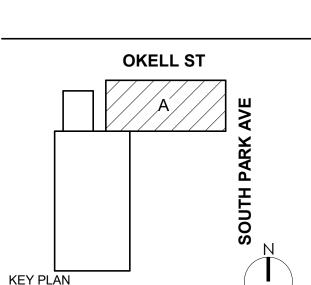

ARCHITECTS

BUFFALO | ROCHESTER

www.cjsarchitects.com

DOFI PROPERTIES

SOUTH PARK MIXED USE

2221 SOUTH PARK AVE BUFFALO, NY 14220

EV.#	DESCRIPTION	DATE

JOB NO.	2508
SCALE	1/4" = 1'-0"
ISSUE DATE	08/04/25
DRAWN BY	Gac
CHECKED BY	JMC
THIS IS A SINICIE SHEET OF A COHESINE	

THIS IS A SINGLE SHEET OF A COHESIVE SET OF CONSTRUCTION DOCUMENTS CLUDING DRAWINGS AND SPECIFICATIONS). INTERPRETATION OF THE INFORMATION AS PRESENTED SHOULD BE BASED ON THE ENTIRE SET OF DOCUMENTS.

DRAWING TITLE

THIRD FLOOR DEMO PLAN

D-103

DEMO PLAN LEGEND = = = = = =

D-200 2

KEYNOTES - DEMOLITION

- D1 DEMO EXISTING STAIRCOORD. REMOVAL W/ OTHER CONSTRUCTION ACTIVITIES AND TEMP. VERT
- CIRCULATION NEEDS 2 REMOVE EXISTING WINDOW WELL AND INFILL OPENING
- REMOVE EXISTING DOOR AND INFILL OPENING
- D4 DEMO EXISTING GWB, POLY VAPOR BARRIER, INSULATION, AND ANY WATER DAMAGED STUDS AT EXISTING EXTERIOR WALL FURRING. EXISTING STUDS IN GOOD CONDITOIN ARE TO REMAIN. INFILL STUD FRAMING/FURRING WHERE NEEDED TO FACILITATE NEW INSULATION AND DRYWALL INSTALL.
- D5 REMOVE ALL EXISTING PLUMBING FIXTURES REFER TO GENERAL NOTES FOR ADDITIONAL MEP
- D6 REMOVE GWB, WALL FURRING AND INSULATION COMPLETELY TO INTERIOR PARTITION
- D7 REMOVE EXISTING WINDOW ASSEMBLY AND MECHANICAL UNIT DOWN TO MASONRY OPENING
- D9 DEMO EXISTING DOOR AND SAWCUT ENLARGED OPENING COORD. W/ STRUC. ON LINTEL REQUIREMENTS
- D10 DEMO EXISTING INFILL AND PREP OPENING FOR NEW STOREFRONT ASSEMBLY- COORD. EXTENTS W/
- D11 DEMO INFILL AND PREP OPENING FOR NEW WINDOW ASSEMBLY COORD. EXTENTS WITH PLANS D12 SAWCUT NEW OPENING

35' - 2 1/2"

D8 DEMO EXISTING WALL

- D13 SAWCUT MASONRY OPENING AND PREP FOR NEW DOOR ASSEMBLY
- D14 DEMO EXISTING STOREFRONT AND PREP FOR NEW ASSEMBLY D15 DEMO EXISTING PENTHOUSE DOWN TO DECK AND PREP OPENING FOR INFILL
- D16 DEMO EXISTING ROOF DECK DOWN TO RAFTERS AND PREP FOR NEW ROOF ASSEMBLY
- D17 DEMO EXISTING SCUPPER AND PREP FOR NEW D19 DEMO EXISTING DOOR AND PREP FOR NEW DOOR ASSEMBLY
- D20 DEMO EXISTING FLOOR FINISH DOWN TO SUBFLOOR
- D21 CUT PENTRATION IN EXISTING FLOOR FOR NEW STAIRWELL PROVIDE ALL NECESSARY SHORING + COORD. W/ STRUC. DWGS
- D22 CUT EXISTING FLOOR/ROOF FOR NEW CHASE PENETRATION. ALL EXISTING STRUCTURAL MEMBERS
- TO REMAIN IN PLACE, COORDINATE WITH ARCHITECT IF CONFLICT ARISES. D23 CUT EXISTING ROOF AND RAFTER FOR NEW ROOF HATCH. ALL STRUCTURAL MEMBERS TO BE
- BRACED AND BLOCKED OFF- COOR. W/ STRUCT DWGS
- D25 COORD. REMOVAL OF WALL W/ NEW ROOF FRAMING INSTALL. REF. TO STRUCT. DWGS
- HAZARDOUS MATERIALS REPORT FOR ANY REGULATED BUILDING MATERIALS, CONTRACT W/
- D26 REMOVE EXISTING ROOFING IN ITS ENTIRETY INCLUDING ALL FLASHINGS, COPINGS ETC. COORD. W/ LICENSED ABATEMENT CONTRACTOR FOR REMOVAL OF SUCH ITEMS

GENERAL DEMOLITION NOTES

- REFERENCE A001 FOR GENERAL NOTES.
- REFER TO MEP DWG'S TO COORDINATE DEMOLITION WORK REQUIRED FOR NEW PENETRATIONS REQUIRED BY NEW UTILITY WORK.
- REQUIRED FOR ONE DRAWING SHALL BE AS BINDING AS IF REQUIRED FOR ALL. DEMOLITION IS NOT NECESSARILY LIMITED TO WHAT IS SHOWN ON DRAWINGS. THE INTENT IS TO INDICATE THE GENERAL SCOPE OF DEMOLITION REQUIRED
- TO COMPLETE THE WORK IN ACCORDANCE WITH THE CONTRACT DRAWINGS. THE CONTRACTOR SHALL NOT ENCUMBER AREAS OUTSIDE OF CONTRACT


THE CONTRACT DOCUMENTS ARE COMPLIMENTARY TO EACH OTHER. WHAT IS

- LIMIT LINES WITH DEBRIS OR MATERIALS. THE CONTRACTOR SHALL MAINTAIN THE AREA IN A SAFE MANNER TO ENSURE THE SAFETY OF STAFF AND CONSTRUCTION PERSONNEL AND NOT ALLOW
- INTERRUPTION OF TRAFFIC FLOW. THE CONTRACTOR SHALL NOT ALLOW DEBRIS TO ACCUMULATE. ALL DEBRIS SHALL BE REMOVED FROM THE AREA AT THE END OF EACH DAY. ALL COMBUSTIBLE MATERIALS / DEBRIS SHALL BE IMMEDIATELY REMOVED FROM THE AREA. ALL DEBRIS REMOVAL SHALL BE PERFORMED IN ACCORDANCE WITH BUILDING OWNER REQUIREMENTS AND PROCEDURES.
- THE CONTRACTOR SHALL REMOVE AND LEGALLY DISPOSE OF ALL DEBRIS. THE CONTRACTOR SHALL COORDINATE WITH THE BUILDING OWNER / MANAGER & TENANT, AREAS TO BE USED FOR STAGING, MATERIAL DELIVERY, DEBRIS REMOVAL, ETC. PRIOR TO START OF DEMOLITION.
- THE CONTRACTOR SHALL VERIFY ALL CONDITIONS AND DIMENSIONS IN FIELD AND BRING ANY DISCREPANCIES TO THE ATTENTION OF THE ARCHITECT AND OWNER, PRIOR TO THE BID.
- SHOULD HAZARDOUS MATERIALS BE ENCOUNTERED, THE CONTRACTOR SHALL STOP WORK, SEAL THE AREA, AND REPORT CONDITION TO THE OWNER AND THE ARCHITECT AND DO NO WORK UNTIL THE CONDITION IS CORRECTED. HAZARDOUS MATERIALS INCLUDE BUT ARE NOT LIMITED TO: MOLD, ASBESTOS, PIPE COVERING (INSULATION), VINYL ASBESTOS TILE, AND LEAD BASE PAINT. REMOVE FLOOR FINISHES WHERE NOTED.
- REMOVE ALL EXISTING IRREGULAR MATERIALS WHICH CAUSE RISES OR DEPRESSIONS IN FLOORING SURFACE, SUCH AS FASTENERS, OUTLET CORES, COVER PLATES, RESILIENT FLOOR COVERINGS, CARPET, CARPET PAD, FLASH PATCH CONCRETE FILL, PLYWOOD, ETC..
- PATCH AND/OR REPLACE ANY SURFACE THAT IS DAMAGED DURING THE DEMOLITION PHASE, OR DAMAGED WALLS AND COLUMNS THAT ARE TO
- AT COMPLETION OF DEMOLITION WORK, THE CONSTRUCTION AREAS SHALL BE LEFT IN "BROOM CLEAN" CONDITION. ALL DEBRIS AND MISCELLANEOUS
- MATERIAL SHALL BE REMOVED. COORDINATE ALL DEMOLITION WORK W/ HAZARDOUS MATERIAL REPORT. ALL DEMOLITION DEBRIS SHALL BECOME THE PROPERTY OF THE CONTRACTOR UNLESS SPECIFICALLY NOTED TO BE SALVAGED, WHEREIN IT REMAINS THE PROPERTY OF THE OWNER. THE OWNER RESERVES THE RIGHT TO REQUEST
- ITEMS BE SALVAGED DURING THE DURATION OF THE WORK OF THIS PROJECT. THE CONTRACTOR SHALL PROVIDE BARRIER PARTITION CONSTRUCTION TO CONTAIN DUST, MAINTAIN BUILDING SECURITY AND WEATHER TIGHTNESS. SEAL PARTITIONS AT FLOOR, ADJACENT WALLS AND TO DECK ABOVE. PROVIDE NECESSARY EGRESS DOORS AND HARDWARE PER EGRESS REQUIREMENTS.
- COORDINATE SIZE AND LOCATION OF FLOOR REMOVALS WITH NEW WORK. FOR ALL ITEMS CALLED OUT TO BE DEMOLISHED PROVIDE COMPLETE DEMOLITION SCOPE REMOVING ALL ASSOCIATED ATTACHMENTS AND ADHESIVES COMPLETE. PREPARE SURFACES TO RECEIVE NEW
- CONSTRUCTION. REFERENCE D104 FOR ROOF INFORMATION. REMOVE ALL EXISTING CEILING TILES UNLESS OTHERWISE NOTED.

FACADES. V.I.F.

- IT IS THE INTENT OF THESE DEMO DRAWINGS FOR ALL MECHANICAL. ELECTRICAL, PLUMBING, AND FIRE PROTECTION (MEPFP) EQUIPMENT, PIPING, CONDUIT, WIRING, FIXTURES, ETC. TO BE REMOVED ON FLOORS 1-3. ITEMS IN THE BASEMENT SHALL BE REMOVED AS COORDINATED WITH THE FINAL MEPFP
- DRAWINGS AND ITEMS INDICATED TO BE EXISTING TO REMAIN. REFER TO PHASE ONE DEMO SET (7/21/25) DWGS FOR PREVIOUSLY REMOVED

REMOVE ALL ABANDONED VENTS, LIGHTING, CONDUIT ETC. ON EXTERIOR

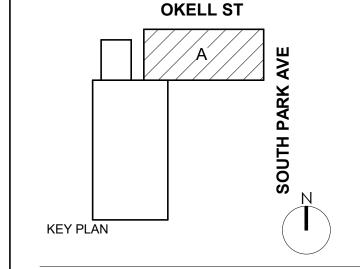

ARCHITECTS

BUFFALO | ROCHESTER

www.cjsarchitects.com

DOFI PROPERTIES

SOUTH PARK MIXED USE

2221 SOUTH PARK AVE BUFFALO, NY 14220

REV.#	DESCRIPTION	DATE

JOB NO.	250
SCALE	1/4" = 1'-
ISSUE DATE	08/04/2
DRAWN BY	Ga
CHECKED BY	JM

THIS IS A SINGLE SHEET OF A COHESIVE SET OF CONSTRUCTION DOCUMENTS (INCLUDING DRAWINGS AND SPECIFICATIONS) INTERPRETATION OF THE INFORMATION AS PRESENTED SHOULD BE BASED ON THE ENTIRE SET OF DOCUMENTS.

DRAWING TITLE

ROOF DEMO **PLAN**

D-104



(D22)— 4' - 0" 40' - 11 1/2"

5' - 2 1/2" 6 1/2"

EXISTING WALL TO REMAIN


EXISTING WALL TO BE REMOVED

EXISTING DOOR TO BE REMOVED


NEW CONSTRUCTION - REFER TO WALL TYPES


NEW DOOR - SEE DOOR SCHEDULE FOR ADDITIONAL INFORMATION

1 ROOF PLAN

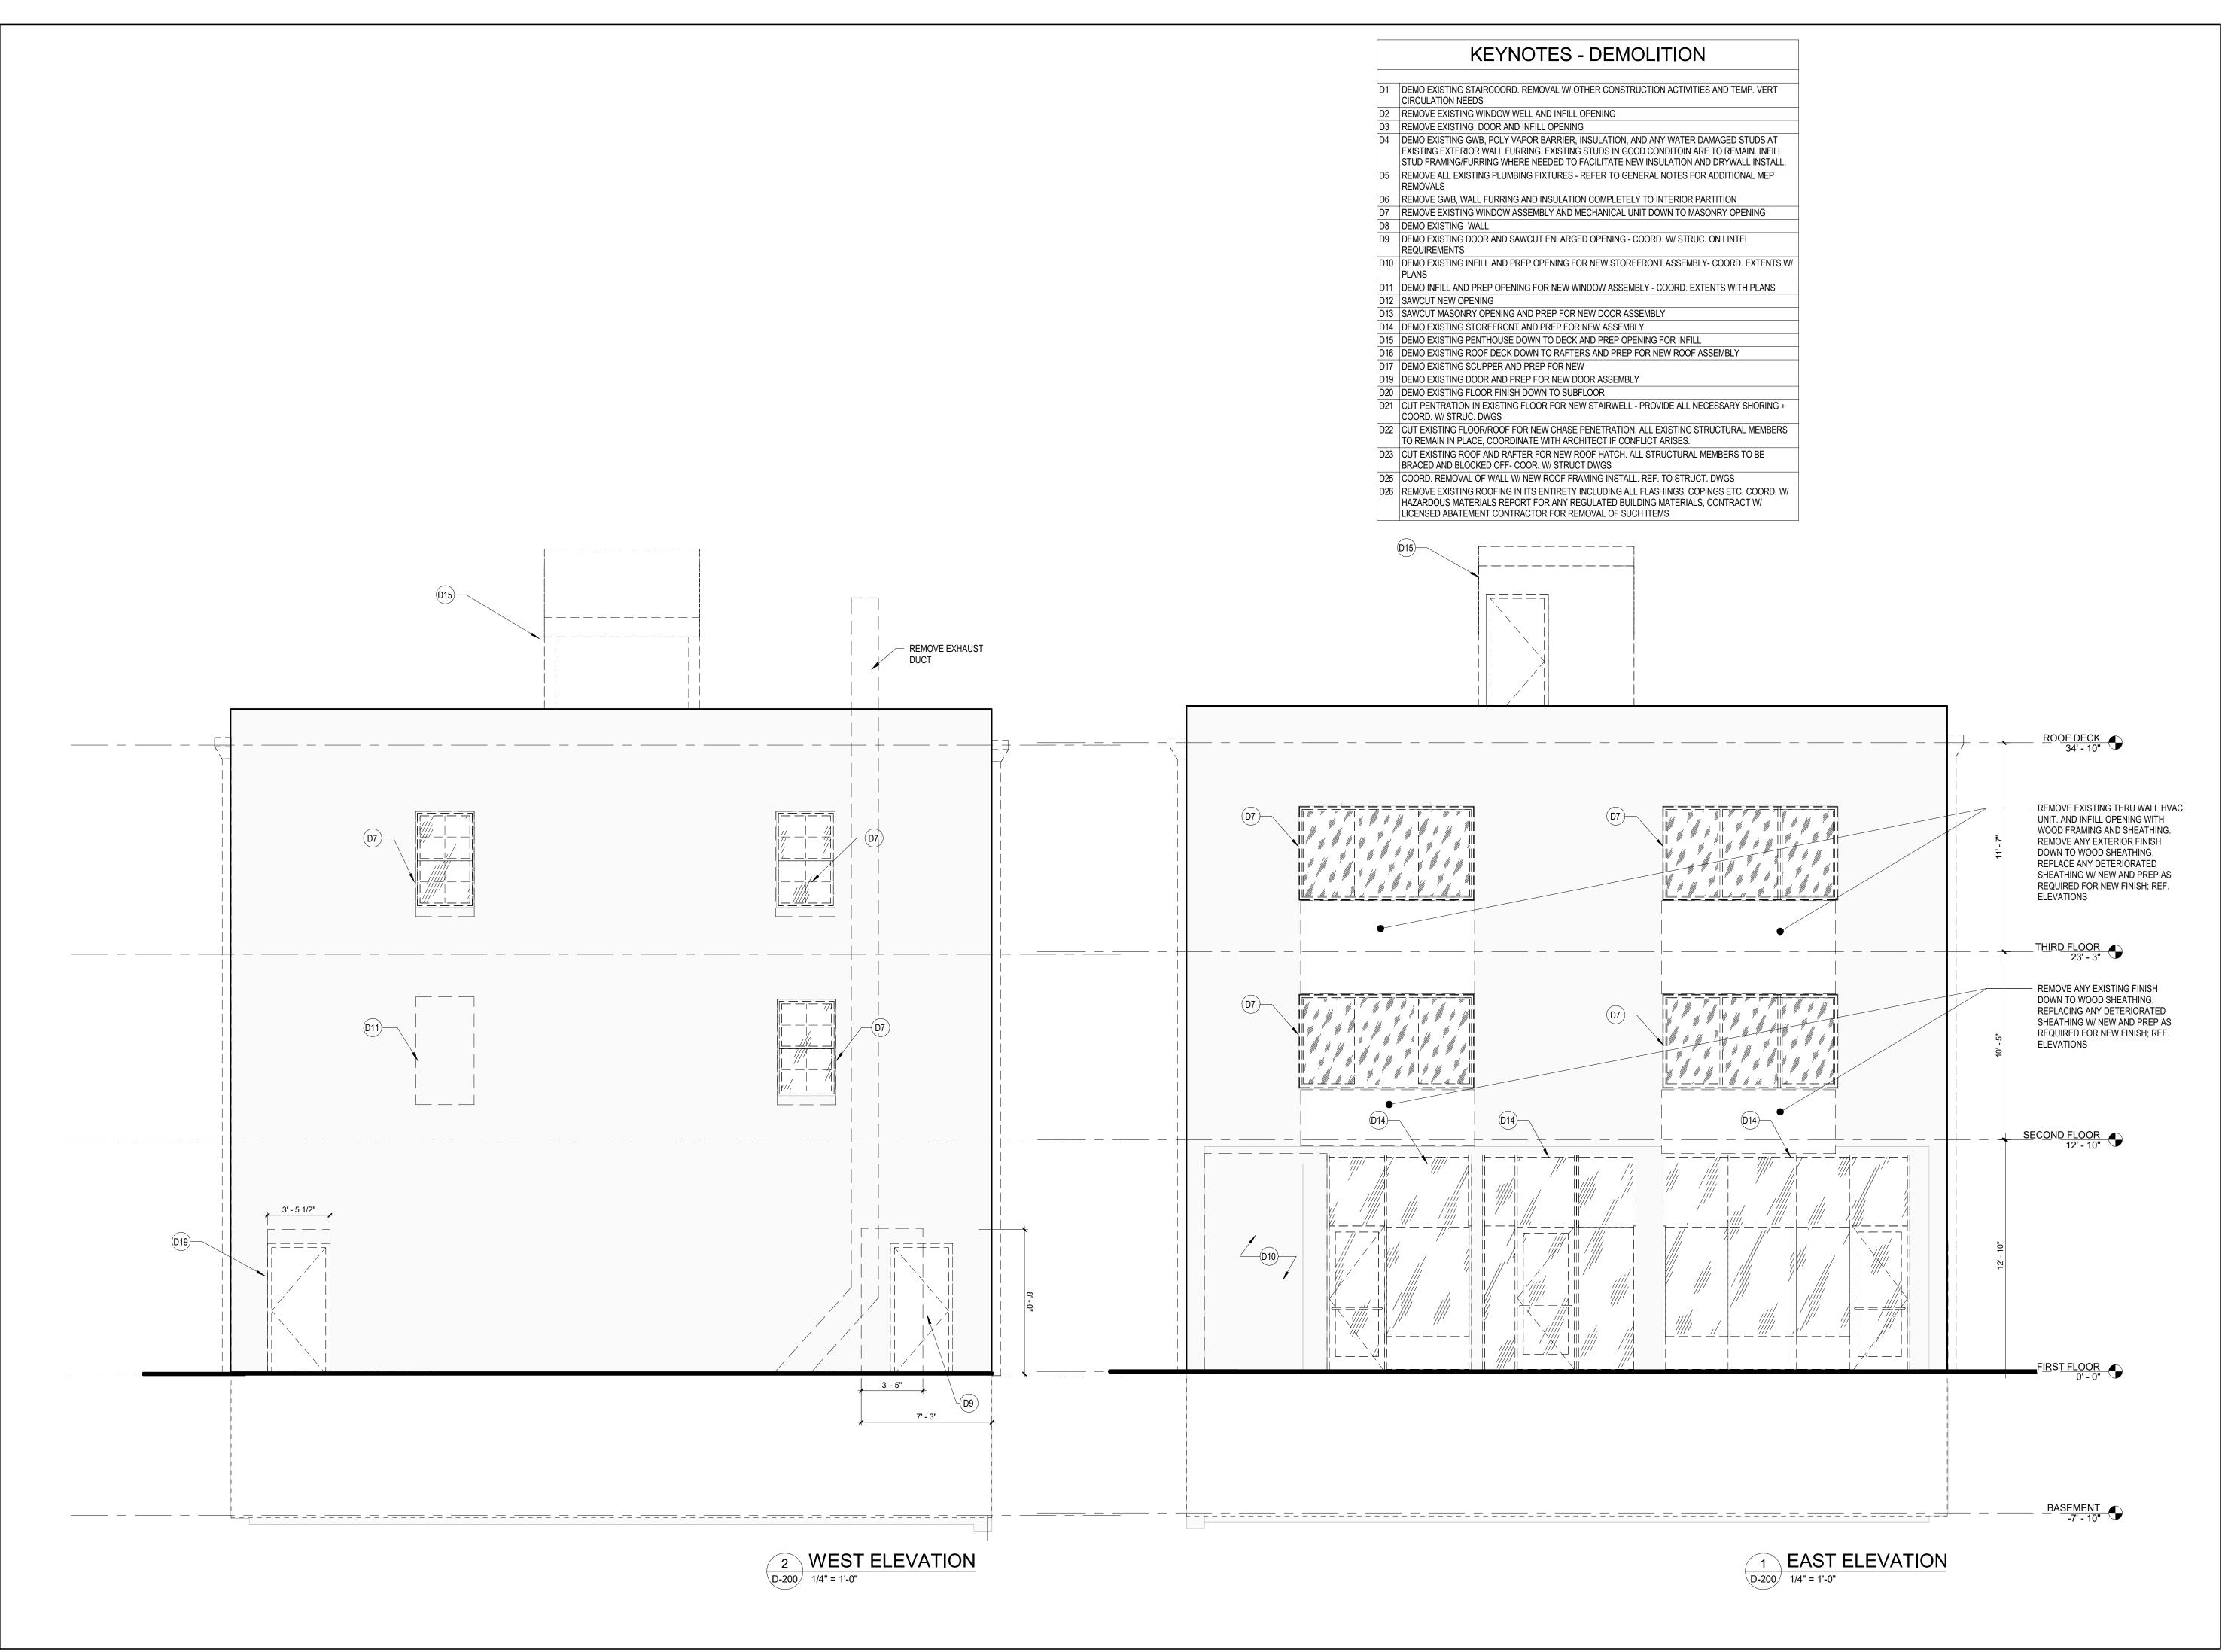



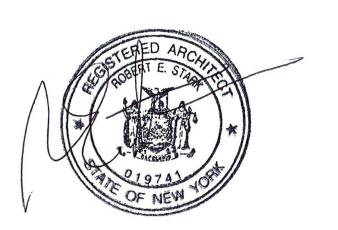

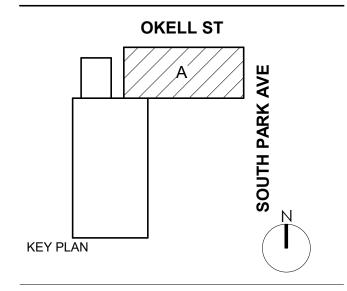

SOUTH PARK MIXED USE

2221 SOUTH PARK AVE BUFFALO, NY 14220

REV.#	DESCRIPTION	DATE

JOB NO.	2508
SCALE	1/4" = 1'-0"
ISSUE DATE	08/04/25
DRAWN BY	Gac
CHECKED BY	JMC
THIS IS A SINGLE SHEET OF A COHESIVE	

THIS IS A SINGLE SHEET OF A COHESIVE SET OF CONSTRUCTION DOCUMENTS (INCLUDING DRAWINGS AND SPECIFICATIONS). INTERPRETATION OF THE INFORMATION AS PRESENTED SHOULD BE BASED ON THE ENTIRE SET OF DOCUMENTS.

DRAWING TITLE

DEMO EXTERIOR ELEVATIONS

D-200

DEDMIT SE

KEYNOTES - DEMOLITION D1 DEMO EXISTING STAIRCOORD. REMOVAL W/ OTHER CONSTRUCTION ACTIVITIES AND TEMP. VERT CIRCULATION NEEDS REMOVE EXISTING WINDOW WELL AND INFILL OPENING REMOVE EXISTING DOOR AND INFILL OPENING D4 DEMO EXISTING GWB, POLY VAPOR BARRIER, INSULATION, AND ANY WATER DAMAGED STUDS AT EXISTING EXTERIOR WALL FURRING. EXISTING STUDS IN GOOD CONDITOIN ARE TO REMAIN. INFILL STUD FRAMING/FURRING WHERE NEEDED TO FACILITATE NEW INSULATION AND DRYWALL INSTALL. D5 REMOVE ALL EXISTING PLUMBING FIXTURES - REFER TO GENERAL NOTES FOR ADDITIONAL MEP D6 REMOVE GWB, WALL FURRING AND INSULATION COMPLETELY TO INTERIOR PARTITION D7 REMOVE EXISTING WINDOW ASSEMBLY AND MECHANICAL UNIT DOWN TO MASONRY OPENING D8 DEMO EXISTING WALL D9 DEMO EXISTING DOOR AND SAWCUT ENLARGED OPENING - COORD. W/ STRUC. ON LINTEL REQUIREMENTS D10 DEMO EXISTING INFILL AND PREP OPENING FOR NEW STOREFRONT ASSEMBLY- COORD. EXTENTS W/ D11 DEMO INFILL AND PREP OPENING FOR NEW WINDOW ASSEMBLY - COORD. EXTENTS WITH PLANS D12 SAWCUT NEW OPENING D13 SAWCUT MASONRY OPENING AND PREP FOR NEW DOOR ASSEMBLY D14 DEMO EXISTING STOREFRONT AND PREP FOR NEW ASSEMBLY D15 DEMO EXISTING PENTHOUSE DOWN TO DECK AND PREP OPENING FOR INFILL D16 DEMO EXISTING ROOF DECK DOWN TO RAFTERS AND PREP FOR NEW ROOF ASSEMBLY D17 DEMO EXISTING SCUPPER AND PREP FOR NEW D19 DEMO EXISTING DOOR AND PREP FOR NEW DOOR ASSEMBLY D20 DEMO EXISTING FLOOR FINISH DOWN TO SUBFLOOR D21 CUT PENTRATION IN EXISTING FLOOR FOR NEW STAIRWELL - PROVIDE ALL NECESSARY SHORING + COORD. W/ STRUC. DWGS TO REMAIN IN PLACE, COORDINATE WITH ARCHITECT IF CONFLICT ARISES. D23 CUT EXISTING ROOF AND RAFTER FOR NEW ROOF HATCH. ALL STRUCTURAL MEMBERS TO BE BRACED AND BLOCKED OFF- COOR. W/ STRUCT DWGS D25 COORD. REMOVAL OF WALL W/ NEW ROOF FRAMING INSTALL. REF. TO STRUCT. DWGS D26 REMOVE EXISTING ROOFING IN ITS ENTIRETY INCLUDING ALL FLASHINGS, COPINGS ETC. COORD. W/ HAZARDOUS MATERIALS REPORT FOR ANY REGULATED BUILDING MATERIALS. CONTRACT W/ LICENSED ABATEMENT CONTRACTOR FOR REMOVAL OF SUCH ITEMS

ROOF DECK 34' - 10"

THIRD FLOOR 23' - 3"

- D22 CUT EXISTING FLOOR/ROOF FOR NEW CHASE PENETRATION. ALL EXISTING STRUCTURAL MEMBERS


GENERAL DEMOLITION NOTES

- REFERENCE A001 FOR GENERAL NOTES.
- REFER TO MEP DWG'S TO COORDINATE DEMOLITION WORK REQUIRED FOR NEW PENETRATIONS REQUIRED BY NEW UTILITY WORK.
- THE CONTRACT DOCUMENTS ARE COMPLIMENTARY TO EACH OTHER. WHAT IS REQUIRED FOR ONE DRAWING SHALL BE AS BINDING AS IF REQUIRED FOR ALL. DEMOLITION IS NOT NECESSARILY LIMITED TO WHAT IS SHOWN ON DRAWINGS.
- THE INTENT IS TO INDICATE THE GENERAL SCOPE OF DEMOLITION REQUIRED TO COMPLETE THE WORK IN ACCORDANCE WITH THE CONTRACT DRAWINGS.
- THE CONTRACTOR SHALL NOT ENCUMBER AREAS OUTSIDE OF CONTRACT LIMIT LINES WITH DEBRIS OR MATERIALS.
- THE CONTRACTOR SHALL MAINTAIN THE AREA IN A SAFE MANNER TO ENSURE THE SAFETY OF STAFF AND CONSTRUCTION PERSONNEL AND NOT ALLOW INTERRUPTION OF TRAFFIC FLOW.
- THE CONTRACTOR SHALL NOT ALLOW DEBRIS TO ACCUMULATE. ALL DEBRIS SHALL BE REMOVED FROM THE AREA AT THE END OF EACH DAY. ALL COMBUSTIBLE MATERIALS / DEBRIS SHALL BE IMMEDIATELY REMOVED FROM THE AREA. ALL DEBRIS REMOVAL SHALL BE PERFORMED IN ACCORDANCE WITH BUILDING OWNER REQUIREMENTS AND PROCEDURES.
- THE CONTRACTOR SHALL REMOVE AND LEGALLY DISPOSE OF ALL DEBRIS. THE CONTRACTOR SHALL COORDINATE WITH THE BUILDING OWNER / MANAGER & TENANT, AREAS TO BE USED FOR STAGING, MATERIAL DELIVERY, DEBRIS
- REMOVAL, ETC. PRIOR TO START OF DEMOLITION. THE CONTRACTOR SHALL VERIFY ALL CONDITIONS AND DIMENSIONS IN FIELD AND BRING ANY DISCREPANCIES TO THE ATTENTION OF THE ARCHITECT AND OWNER, PRIOR TO THE BID.
- SHOULD HAZARDOUS MATERIALS BE ENCOUNTERED, THE CONTRACTOR SHALL STOP WORK, SEAL THE AREA, AND REPORT CONDITION TO THE OWNER AND THE ARCHITECT AND DO NO WORK UNTIL THE CONDITION IS CORRECTED. HAZARDOUS MATERIALS INCLUDE BUT ARE NOT LIMITED TO: MOLD, ASBESTOS, PIPE COVERING (INSULATION), VINYL ASBESTOS TILE, AND LEAD BASE PAINT. REMOVE FLOOR FINISHES WHERE NOTED.
- REMOVE ALL EXISTING IRREGULAR MATERIALS WHICH CAUSE RISES OR DEPRESSIONS IN FLOORING SURFACE, SUCH AS FASTENERS, OUTLET CORES. COVER PLATES, RESILIENT FLOOR COVERINGS, CARPET, CARPET PAD, FLASH PATCH CONCRETE FILL, PLYWOOD, ETC..
- PATCH AND/OR REPLACE ANY SURFACE THAT IS DAMAGED DURING THE DEMOLITION PHASE, OR DAMAGED WALLS AND COLUMNS THAT ARE TO
- AT COMPLETION OF DEMOLITION WORK, THE CONSTRUCTION AREAS SHALL BE LEFT IN "BROOM CLEAN" CONDITION. ALL DEBRIS AND MISCELLANEOUS
- MATERIAL SHALL BE REMOVED. COORDINATE ALL DEMOLITION WORK W/ HAZARDOUS MATERIAL REPORT. ALL DEMOLITION DEBRIS SHALL BECOME THE PROPERTY OF THE CONTRACTOR UNLESS SPECIFICALLY NOTED TO BE SALVAGED, WHEREIN IT REMAINS THE PROPERTY OF THE OWNER. THE OWNER RESERVES THE RIGHT TO REQUEST
- ITEMS BE SALVAGED DURING THE DURATION OF THE WORK OF THIS PROJECT. THE CONTRACTOR SHALL PROVIDE BARRIER PARTITION CONSTRUCTION TO CONTAIN DUST, MAINTAIN BUILDING SECURITY AND WEATHER TIGHTNESS. SEAL PARTITIONS AT FLOOR, ADJACENT WALLS AND TO DECK ABOVE. PROVIDE NECESSARY EGRESS DOORS AND HARDWARE PER EGRESS REQUIREMENTS.
- COORDINATE SIZE AND LOCATION OF FLOOR REMOVALS WITH NEW WORK. FOR ALL ITEMS CALLED OUT TO BE DEMOLISHED PROVIDE COMPLETE DEMOLITION SCOPE REMOVING ALL ASSOCIATED ATTACHMENTS AND ADHESIVES COMPLETE. PREPARE SURFACES TO RECEIVE NEW
- CONSTRUCTION. REFERENCE D104 FOR ROOF INFORMATION. REMOVE ALL EXISTING CEILING TILES UNLESS OTHERWISE NOTED. IT IS THE INTENT OF THESE DEMO DRAWINGS FOR ALL MECHANICAL. ELECTRICAL, PLUMBING, AND FIRE PROTECTION (MEPFP) EQUIPMENT, PIPING, CONDUIT, WIRING, FIXTURES, ETC. TO BE REMOVED ON FLOORS 1-3. ITEMS IN
- THE BASEMENT SHALL BE REMOVED AS COORDINATED WITH THE FINAL MEPFP DRAWINGS AND ITEMS INDICATED TO BE EXISTING TO REMAIN. REFER TO PHASE ONE DEMO SET (7/21/25) DWGS FOR PREVIOUSLY REMOVED
- REMOVE ALL ABANDONED VENTS, LIGHTING, CONDUIT ETC. ON EXTERIOR FACADES. V.I.F.



BUFFALO | ROCHESTER www.cjsarchitects.com



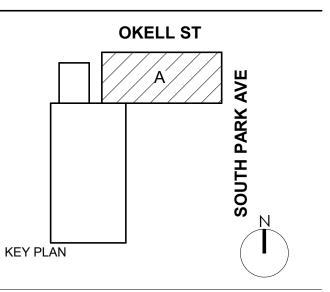

DOFI PROPERTIES

SOUTH PARK MIXED USE

2221 SOUTH PARK AVE BUFFALO, NY 14220

DESCRIPTION

Ī	JOB NO.	250
	SCALE	1/4" = 1'-0
	ISSUE DATE	08/04/2
	DRAWN BY	Ga
	CHECKED BY	JMO


THIS IS A SINGLE SHEET OF A COHESIVE SET OF CONSTRUCTION DOCUMENTS (INCLUDING DRAWINGS AND SPECIFICATIONS) INTERPRETATION OF THE INFORMATION AS PRESENTED SHOULD BE BASED ON THE ENTIRE SET OF DOCUMENTS.

DRAWING TITLE

DEMO EXTERIOR **ELEVATION**

D-201



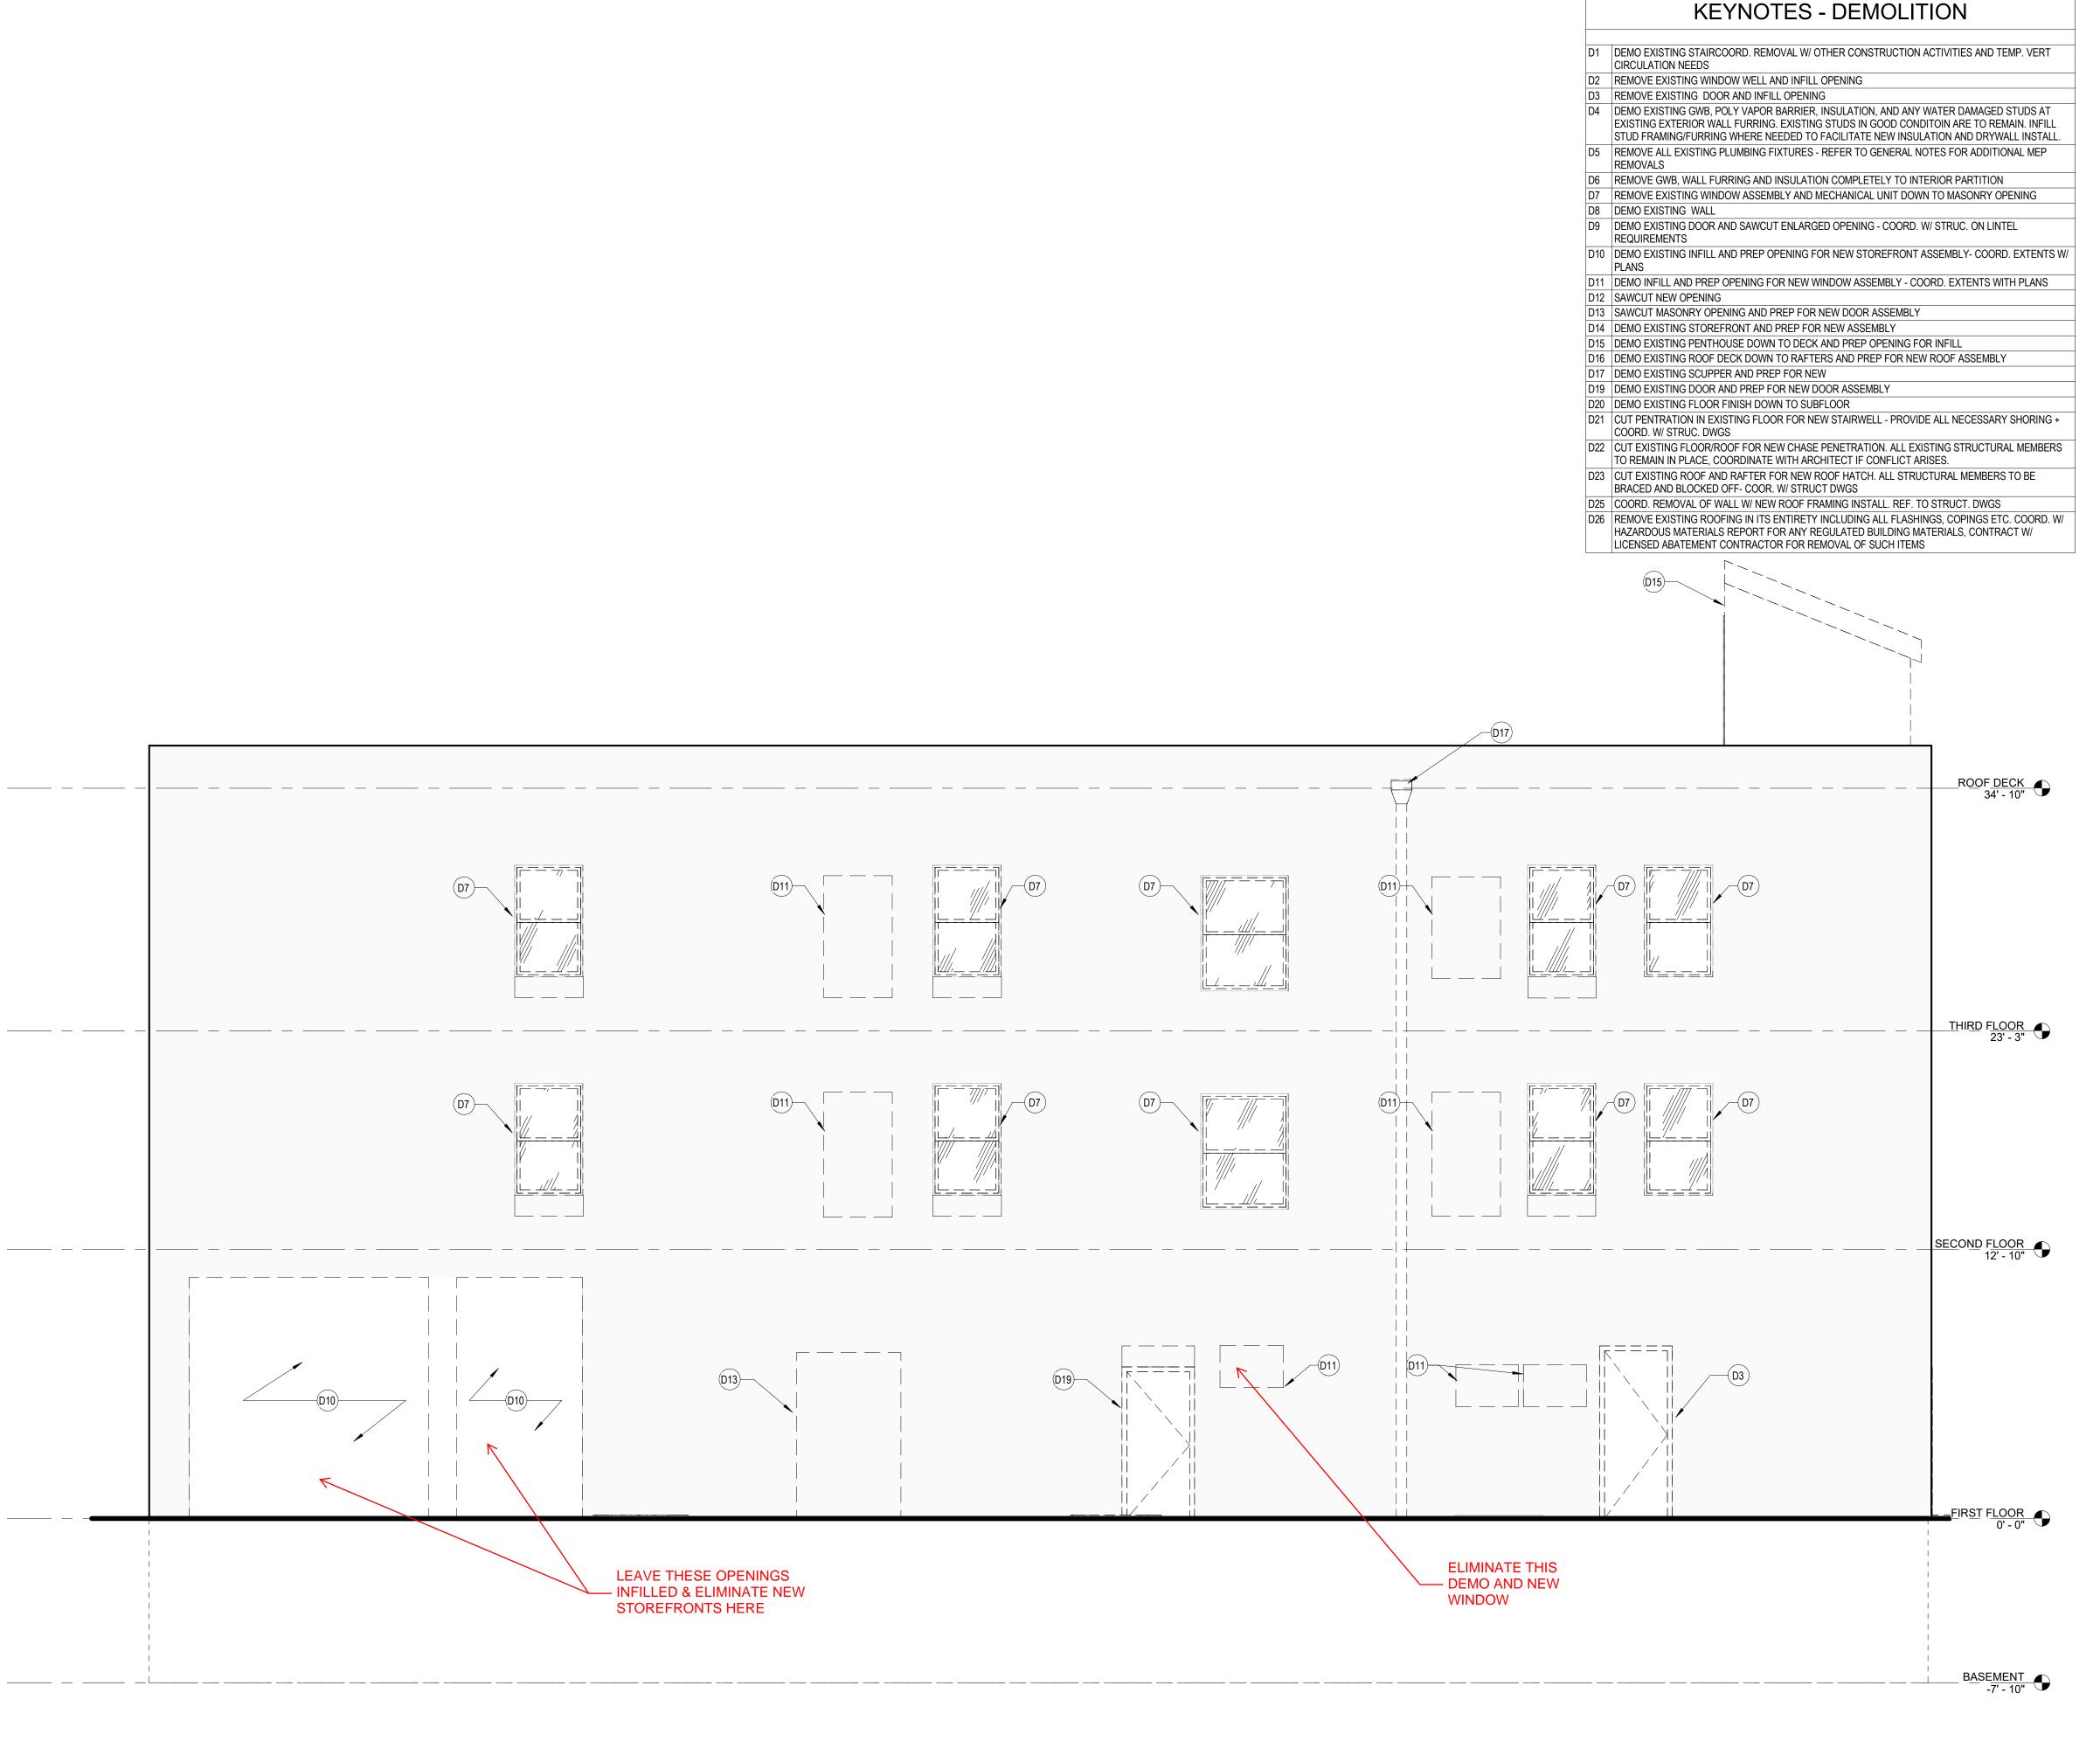

GENERAL DEMOLITION NOTES

- REFERENCE A001 FOR GENERAL NOTES.

 OF THE PROPERTY OF THE
- REFER TO MEP DWG'S TO COORDINATE DEMOLITION WORK REQUIRED FOR NEW PENETRATIONS REQUIRED BY NEW UTILITY WORK.
- THE CONTRACT DOCUMENTS ARE COMPLIMENTARY TO EACH OTHER. WHAT IS REQUIRED FOR ONE DRAWING SHALL BE AS BINDING AS IF REQUIRED FOR ALL.
- 4. DEMOLITION IS NOT NECESSARILY LIMITED TO WHAT IS SHOWN ON DRAWINGS.
 THE INTENT IS TO INDICATE THE GENERAL SCOPE OF DEMOLITION REQUIRED
 TO COMPLETE THE WORK IN ACCORDANCE WITH THE CONTRACT DRAWINGS.
- 5. THE CONTRACTOR SHALL NOT ENCUMBER AREAS OUTSIDE OF CONTRACT LIMIT LINES WITH DEBRIS OR MATERIALS.
- 6. THE CONTRACTOR SHALL MAINTAIN THE AREA IN A SAFE MANNER TO ENSURE THE SAFETY OF STAFF AND CONSTRUCTION PERSONNEL AND NOT ALLOW

BUILDING OWNER REQUIREMENTS AND PROCEDURES.

- INTERRUPTION OF TRAFFIC FLOW.
 THE CONTRACTOR SHALL NOT ALLOW DEBRIS TO ACCUMULATE. ALL DEBRIS
 SHALL BE REMOVED FROM THE AREA AT THE END OF EACH DAY. ALL
 COMBUSTIBLE MATERIALS / DEBRIS SHALL BE IMMEDIATELY REMOVED FROM
 THE AREA. ALL DEBRIS REMOVAL SHALL BE PERFORMED IN ACCORDANCE WITH
- THE CONTRACTOR SHALL REMOVE AND LEGALLY DISPOSE OF ALL DEBRIS.
 THE CONTRACTOR SHALL COORDINATE WITH THE BUILDING OWNER / MANAGER
 & TENANT, AREAS TO BE USED FOR STAGING, MATERIAL DELIVERY, DEBRIS
- REMOVAL, ETC. PRIOR TO START OF DEMOLITION.
 THE CONTRACTOR SHALL VERIFY ALL CONDITIONS AND DIMENSIONS IN FIELD AND BRING ANY DISCREPANCIES TO THE ATTENTION OF THE ARCHITECT AND OWNER, PRIOR TO THE BID.
- 11. SHOULD HAZARDOUS MATERIALS BE ENCOUNTERED, THE CONTRACTOR SHALL STOP WORK, SEAL THE AREA, AND REPORT CONDITION TO THE OWNER AND THE ARCHITECT AND DO NO WORK UNTIL THE CONDITION IS CORRECTED. HAZARDOUS MATERIALS INCLUDE BUT ARE NOT LIMITED TO: MOLD, ASBESTOS, PIPE COVERING (INSULATION), VINYL ASBESTOS TILE, AND LEAD BASE PAINT.
- REMOVE FLOOR FINISHES WHERE NOTED.
 REMOVE ALL EXISTING IRREGULAR MATERIALS WHICH CAUSE RISES OR DEPRESSIONS IN FLOORING SURFACE, SUCH AS FASTENERS, OUTLET CORES, COVER PLATES, RESILIENT FLOOR COVERINGS, CARPET, CARPET PAD, FLASH PATCH CONCRETE FILL, PLYWOOD, ETC..
- 14. PATCH AND/OR REPLACE ANY SURFACE THAT IS DAMAGED DURING THE DEMOLITION PHASE, OR DAMAGED WALLS AND COLUMNS THAT ARE TO DEMAIN
- AT COMPLETION OF DEMOLITION WORK, THE CONSTRUCTION AREAS SHALL BE LEFT IN "BROOM CLEAN" CONDITION. ALL DEBRIS AND MISCELLANEOUS MATERIAL SHALL BE REMOVED.
- 16. COORDINATE ALL DEMOLITION WORK W/ HAZARDOUS MATERIAL REPORT.
 17. ALL DEMOLITION DEBRIS SHALL BECOME THE PROPERTY OF THE CONTRACTOR UNLESS SPECIFICALLY NOTED TO BE SALVAGED, WHEREIN IT REMAINS THE PROPERTY OF THE OWNER. THE OWNER RESERVES THE RIGHT TO REQUEST ITEMS BE SALVAGED DURING THE DURATION OF THE WORK OF THIS PROJECT.
 18. THE CONTRACTOR SHALL PROVIDE BARRIER PARTITION CONSTRUCTION TO
- CONTAIN DUST, MAINTAIN BUILDING SECURITY AND WEATHER TIGHTNESS.
 SEAL PARTITIONS AT FLOOR, ADJACENT WALLS AND TO DECK ABOVE. PROVIDE
 NECESSARY EGRESS DOORS AND HARDWARE PER EGRESS REQUIREMENTS.
 COORDINATE SIZE AND LOCATION OF FLOOR REMOVALS WITH NEW WORK.
- 20. FOR ALL ITEMS CALLED OUT TO BE DEMOLISHED PROVIDE COMPLETE DEMOLITION SCOPE REMOVING ALL ASSOCIATED ATTACHMENTS AND ADHESIVES COMPLETE. PREPARE SURFACES TO RECEIVE NEW CONSTRUCTION.
 21. REFERENCE D104 FOR ROOF INFORMATION.
- 22. REMOVE ALL EXISTING CEILING TILES UNLESS OTHERWISE NOTED.
 23. IT IS THE INTENT OF THESE DEMO DRAWINGS FOR ALL MECHANICAL.
 ELECTRICAL, PLUMBING, AND FIRE PROTECTION (MEPFP) EQUIPMENT, PIPING,
 CONDUIT, WIRING, FIXTURES, ETC. TO BE REMOVED ON FLOORS 1-3. ITEMS IN
 THE BASEMENT SHALL BE REMOVED AS COORDINATED WITH THE FINAL MEPFP
 DRAWINGS AND ITEMS INDICATED TO BE EXISTING TO REMAIN.
- 24. REFER TO PHASE ONE DEMO SET (7/21/25) DWGS FOR PREVIOUSLY REMOVED ITEMS.
 25. REMOVE ALL ABANDONED VENTS, LIGHTING, CONDUIT ETC. ON EXTERIOR


1 NORTH ELEVATION


D-202 1/4" = 1'-0"

FACADES. V.I.F.



BUFFALO | ROCHESTER www.cjsarchitects.com

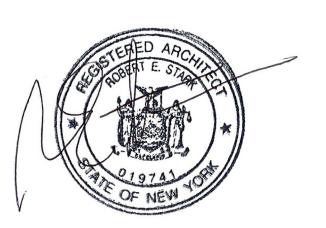

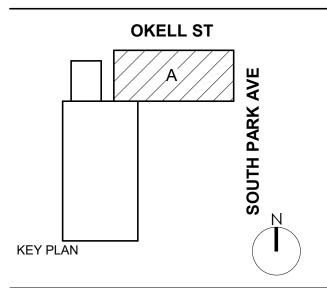

DOFI PROPERTIES

SOUTH PARK MIXED USE

2221 SOUTH PARK AVE BUFFALO, NY 14220

′ .#	DESCRIPTION	DATE


2508	JOB NO.
1/4" = 1'-0"	SCALE
08/04/25	ISSUE DATE
Gac	DRAWN BY
JMC	CHECKED BY
	THIS IS A SINGLE SHEET OF A COHESIVE

THIS IS A SINGLE SHEET OF A COHESIVE SET OF CONSTRUCTION DOCUMENTS (INCLUDING DRAWINGS AND SPECIFICATIONS) INTERPRETATION OF THE INFORMATION AS PRESENTED SHOULD BE BASED ON THE ENTIRE SET OF DOCUMENTS.

DRAWING TITLE

DEMO EXTERIOR ELEVATIONS

D-202

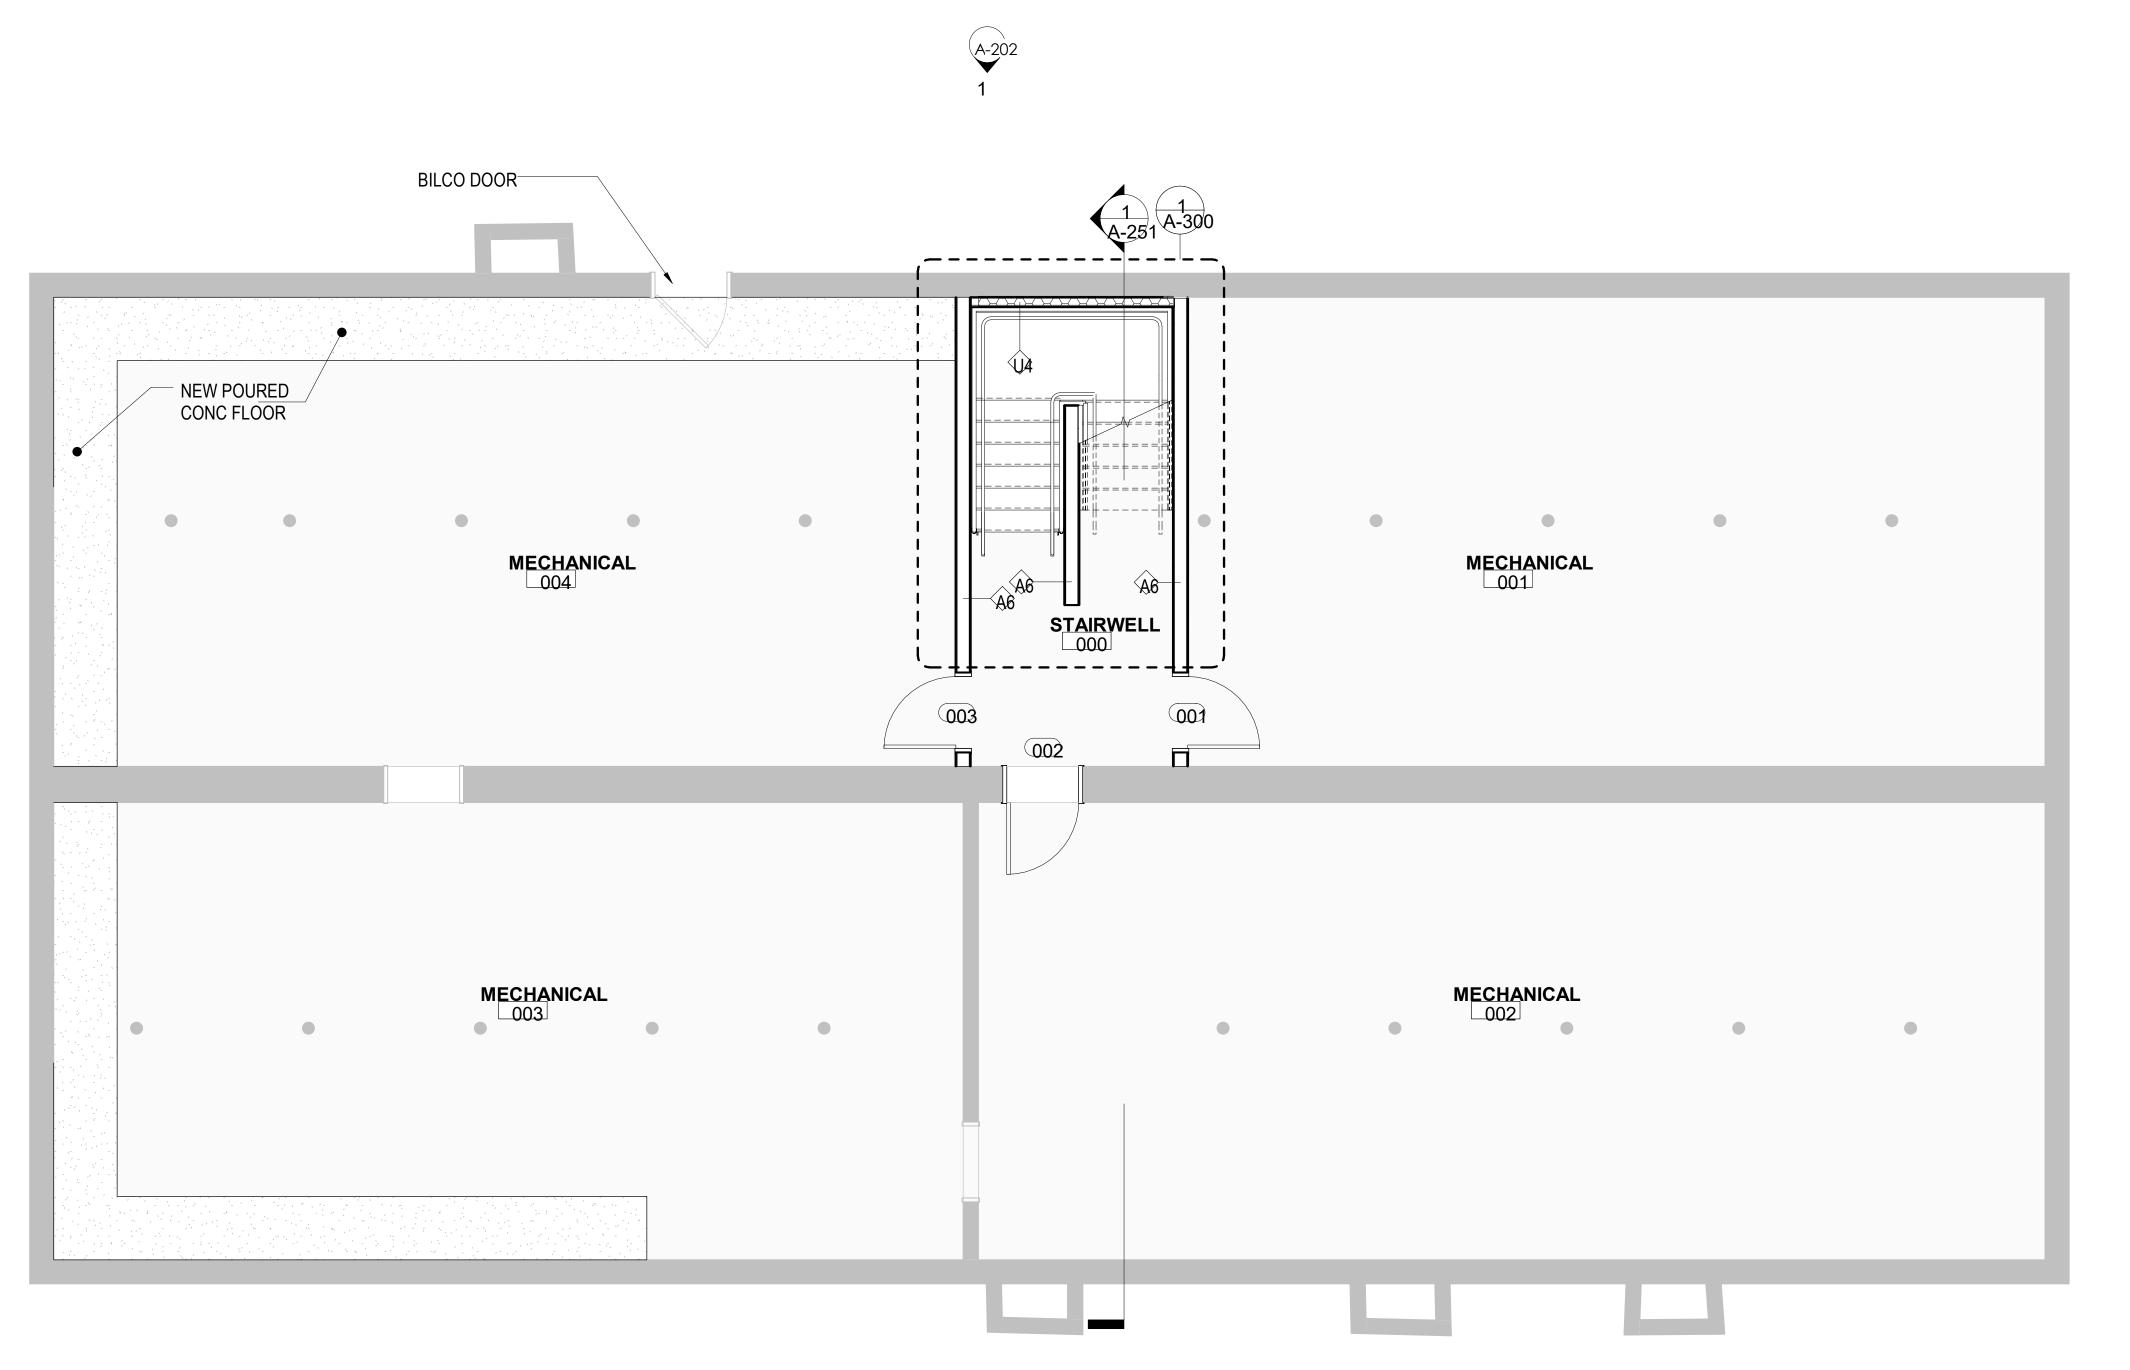

A-200 2

GENERAL PLAN NOTES

- 1. REFERENCE SHEET A-001 MATERIAL LEGEND, SYMBOL LEGEND AN ABBREVIATIONS USED.
- 2. REFERENCE STRUCTURAL DRAWINGS FOR UNIT MASONRY, STEEL, ETC. INFORMATION.
- 3. REFERENCE ROOM FINISH SCHEDULE, FLOOR PATTERN PLANS & R ARCHITECTS CEILING PLANS FOR FINISH INFORMATION.
- 4. REFER TO U.L. FIRE RESISTANCE DIRECTORY FOR DETA LS ON FIR WALLS, COLUMNS ENCLOSURES, FLOOR/CEILING ASSEMBLIES & CEILING ASSEMBLIES
- ASSEMBLIES.

 ALL SUB-CONTRACTORS SHALL VERIFY THAT CONDITIONS PRESENT Miwww.cjsarchitects.com STANDARD INDUSTRY ACCEPTED CRITERIA FOR ACCEPTING/PERFORMING WORK OF THEIR TRADE. IF CONDITIONS PRESENT WILL NOT FACILITATE PERFORMANCE OF THEIR WORK IN AN ACCEPTABLE FASHION, SAID CONTRACTOR SHALL BRING THE DEFICIENCIES TO THE ATTENTION OF THE CM OR GC. IF WORK PROCEEDS WITHOUT CORRECTING DEFICIENT EXISTING CONDITIONS, ANY COSTS ASSOCIATED WITH REMOVAL & REINSTALLATION OF SAID WORK WILL BE THE
- RESPONSIBILITY OF THE SUB-CONTRACTOR.

 6. BATH ROUGH OPENINGS SHALL NOT INTERRUPT UL DES GN OF FIRE RATED
- FLOOR, WALL, AND CEILING ASSEMBLIES.

 7. UNLESS NOTED OTHERWISE, ALL WALLS SHALL BE CONTINUOUS TO THE UNDERSIDE OF FLOOR DECK, FIRE RATED CEILING ASSEMBLY, OR FIRE RATED
- CEILING/ROOF ASSEMBLY ABOVE.
 PROVIDE DRAFTSTOPPING AT THE TOP OF ALL CONCEALED WALL CAVITIES.
 DRAFTSTOPPING SHALL BE OF AN BCNYS APPROVED MATERIAL AND SHALL,
 PREVENT THE PASSAGE OF SMOKE FROM THE WALL CAVITY INTO ANY ADJACENT CEILING/FLOOR OR CEILING/ROOF CAVITIES.
- 9. PROVIDE SOLID WOOD BLOCKING AS REINFORCING FOR ALL WALL HUNG ITEMS, INCLUDING BUT NOT LIMITED TO; HANDRAILS, GRAB BARS, FUTURE GRAB BARS, CABINETS, ELEC. PANELS, FIXTURES AND ACCESSORIES.
- 10. MOISTURE RESISTANT GYPSUM WALL BOARD SHALL BE PROVIDED AT ALL WET AREAS (TOILETS, KITCHENS, MOP SINKS, ETC.)
- 11. ALL STRUCTURE., MECH., ELEC., PLUMB. AND FIRE PROTECTION ELEMENTS SHOWN ARE FOR REFERENCE ONLY. CONTRACTOR SHALL REFER TO OTHER SECTIONS OF THE DOCUMENTS AS APPROPRIATE FOR OTHER TRADES. WHERE DISCREPANCIES EXIST BETWEEN ARCH. DRAWINGS AND OTHER TRADES CONTRACTOR SHALL NOTIFY GC OR CM & ARCHITECT PRIOR TO PERFORMING ANY WORK RELATED TO SAID DISCREPANCY.
- 12. CORD.. MECH COVERS, GRILLES, ETC. WITH MECH. DWG'S. COLORS TO BE
 SELECTED BY ARCHITECT FROM MANUFACTURER'S FULL RANGE, INCLUDING OKELI
 PREMIUM FINISHES/COLORS.
- 3. DOORS LOCATED IN CLOSETS OR PARTITIONS TO BE CENTERED WITHIN WALL A
 UNLESS OTHERWISE NOTED.
- 14. CUSTOM PAINT ELECTRICAL PANEL BOXES IN RESIDENTIAL UNITS MATCH ADJACENT WALL COLOR.
 15. ALIGN FINISHED FACE OF WALLS WHERE DIFFERENT WALL TYPES ABUT EACH
- OTHER.

 16. GENERAL FLOOR PLAN NOTES APPLY TO ALL FLOOR PLANS OF THIS PROJECT
- 17. ALL DIMENSIONS ARE FINISH DIMENSIONS FACE TO FACE OF FINISHES UNLESS OTHERWISE NOTED.

 KEY PLAN
- 18. ALL DIMENSIONS, MATERIAL INDICATIONS AND NOTES SHOWN ON ONE DRAWING SHALL APPLY TO ALL OTHER SIMILAR DRAWINGS UNLESS OTHERWISE NOTED
- VERIFY ALL DIMENSIONED CONDITIONS IN THE FIELD PRIOR TO SHOP DOFI PROPERTIES SUBMITTAL/FABRICATION/CONSTRUCTION. WHEN DIMENSIONS AND/OR CONDITIONS AS INDICATED ON THE DRAWINGS CONFLICT WITH ACTUAL,

CONTACT THE ARCHITECT IN WRITING FOR CLARIFICATION.

SOUTH PARI MIXED USE 2221 SOUTH PARK AVE BUFFALO, NY 14220

7.# DESCRIPTION DATE

 JOB NO.
 2508

 SCALE
 1/4" = 1'-0'

 ISSUE DATE
 08/04/25

 DRAWN BY
 Gac

 CHECKED BY
 JMC


THIS IS A SINGLE SHEET OF A COHESIVE SET OF CONSTRUCTION DOCUMENTS (INCLUDING DRAWINGS AND SPECIFICATIO INTERPRETATION OF THE INFORMATION AS PRESENTED SHOULD BE BASED ON DRAWING TITLETIRE SET OF DOCUMENTS.

BASEMENT PI

A-100



1 (A-200

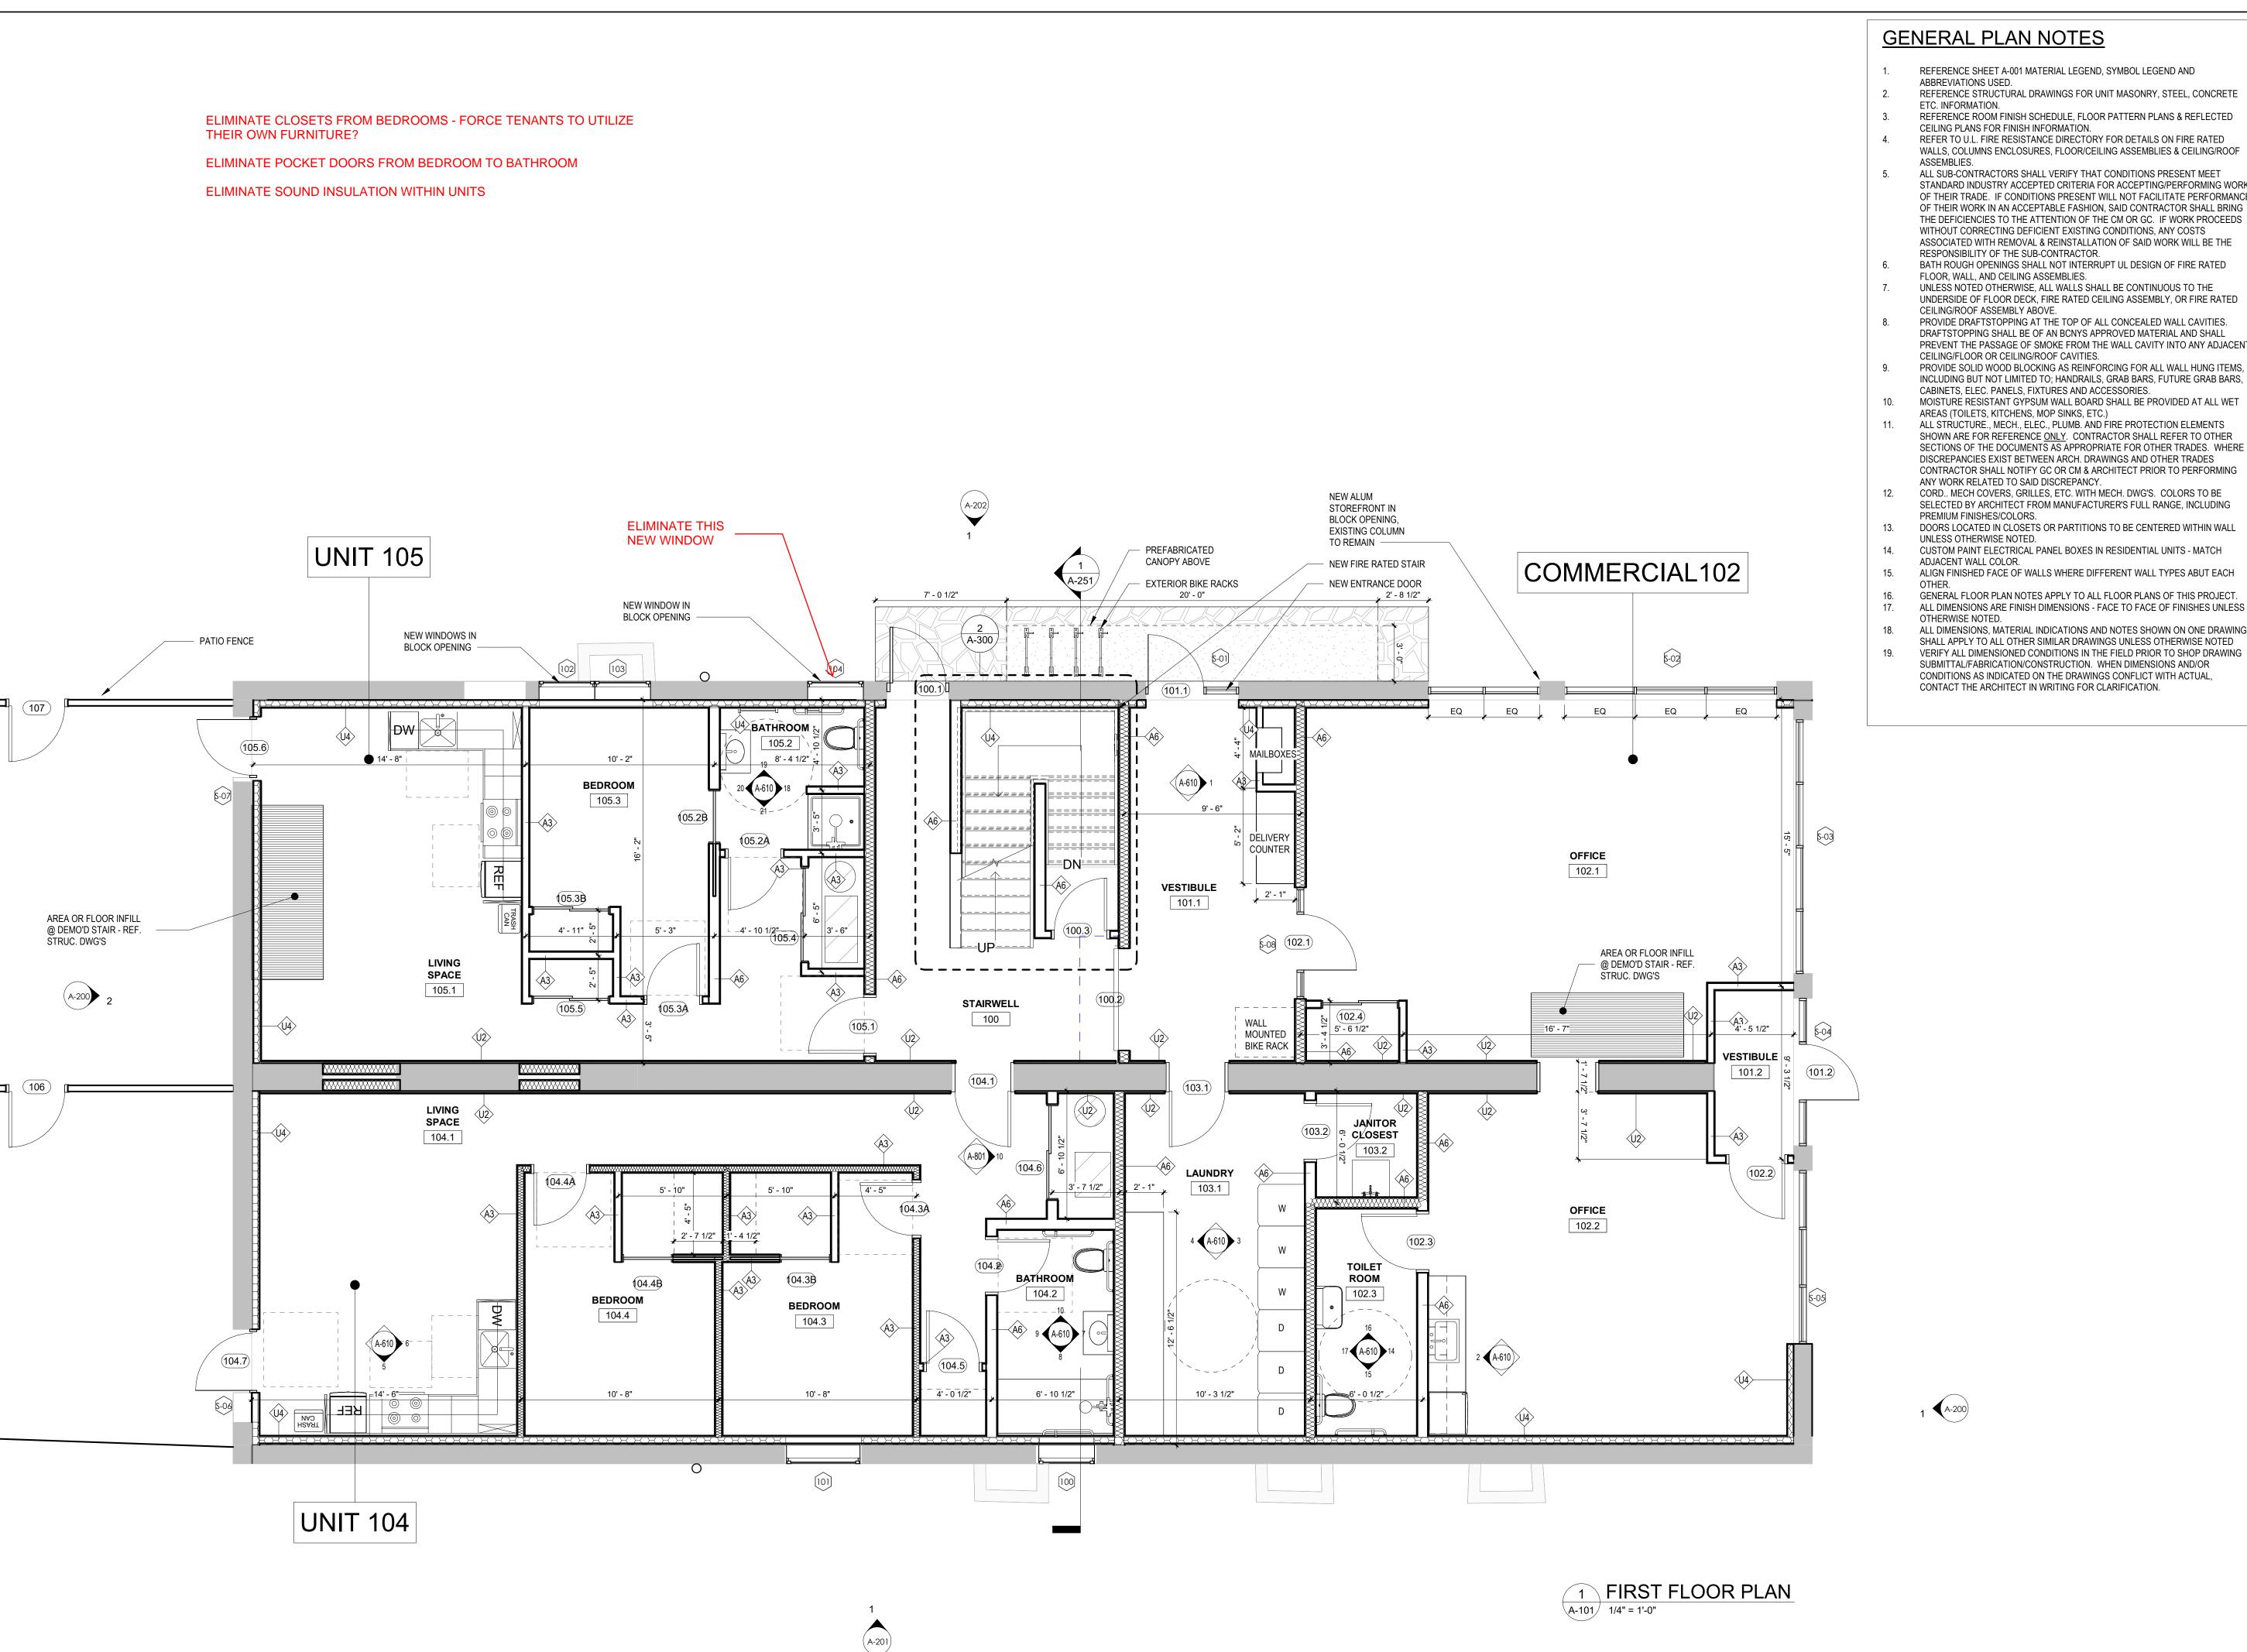



GENERAL PLAN NOTES

- REFERENCE SHEET A-001 MATERIAL LEGEND, SYMBOL LEGEND AND
- REFERENCE STRUCTURAL DRAWINGS FOR UNIT MASONRY, STEEL, CONCRETE
- REFER TO U.L. FIRE RESISTANCE DIRECTORY FOR DETAILS ON FIRE RATED WALLS, COLUMNS ENCLOSURES, FLOOR/CEILING ASSEMBLIES & CEILING/ROOF
- ALL SUB-CONTRACTORS SHALL VERIFY THAT CONDITIONS PRESENT MEET STANDARD INDUSTRY ACCEPTED CRITERIA FOR ACCEPTING/PERFORMING WORK OF THEIR TRADE. IF CONDITIONS PRESENT WILL NOT FACILITATE PERFORMANCE OF THEIR WORK IN AN ACCEPTABLE FASHION, SAID CONTRACTOR SHALL BRING THE DEFICIENCIES TO THE ATTENTION OF THE CM OR GC. IF WORK PROCEEDS WITHOUT CORRECTING DEFICIENT EXISTING CONDITIONS, ANY COSTS ASSOCIATED WITH REMOVAL & REINSTALLATION OF SAID WORK WILL BE THE
- BATH ROUGH OPENINGS SHALL NOT INTERRUPT UL DESIGN OF FIRE RATED
- UNLESS NOTED OTHERWISE, ALL WALLS SHALL BE CONTINUOUS TO THE UNDERSIDE OF FLOOR DECK, FIRE RATED CEILING ASSEMBLY, OR FIRE RATED
- PROVIDE DRAFTSTOPPING AT THE TOP OF ALL CONCEALED WALL CAVITIES. DRAFTSTOPPING SHALL BE OF AN BCNYS APPROVED MATERIAL AND SHALL PREVENT THE PASSAGE OF SMOKE FROM THE WALL CAVITY INTO ANY ADJACENT CEILING/FLOOR OR CEILING/ROOF CAVITIES.
- INCLUDING BUT NOT LIMITED TO; HANDRAILS, GRAB BARS, FUTURE GRAB BARS, CABINETS, ELEC. PANELS, FIXTURES AND ACCESSORIES.
- MOISTURE RESISTANT GYPSUM WALL BOARD SHALL BE PROVIDED AT ALL WET AREAS (TOILETS, KITCHENS, MOP SINKS, ETC.)
- ALL STRUCTURE., MECH., ELEC., PLUMB. AND FIRE PROTECTION ELEMENTS SHOWN ARE FOR REFERENCE ONLY. CONTRACTOR SHALL REFER TO OTHER SECTIONS OF THE DOCUMENTS AS APPROPRIATE FOR OTHER TRADES. WHERE DISCREPANCIES EXIST BETWEEN ARCH. DRAWINGS AND OTHER TRADES CONTRACTOR SHALL NOTIFY GC OR CM & ARCHITECT PRIOR TO PERFORMING
- CORD.. MECH COVERS, GRILLES, ETC. WITH MECH. DWG'S. COLORS TO BE SELECTED BY ARCHITECT FROM MANUFACTURER'S FULL RANGE, INCLUDING
- DOORS LOCATED IN CLOSETS OR PARTITIONS TO BE CENTERED WITHIN WALL UNLESS OTHERWISE NOTED.
- CUSTOM PAINT ELECTRICAL PANEL BOXES IN RESIDENTIAL UNITS MATCH
- GENERAL FLOOR PLAN NOTES APPLY TO ALL FLOOR PLANS OF THIS PROJECT.
- ALL DIMENSIONS ARE FINISH DIMENSIONS FACE TO FACE OF FINISHES UNLESS
- ALL DIMENSIONS, MATERIAL INDICATIONS AND NOTES SHOWN ON ONE DRAWING
- SHALL APPLY TO ALL OTHER SIMILAR DRAWINGS UNLESS OTHERWISE NOTED VERIFY ALL DIMENSIONED CONDITIONS IN THE FIELD PRIOR TO SHOP DRAWING SUBMITTAL/FABRICATION/CONSTRUCTION. WHEN DIMENSIONS AND/OR CONDITIONS AS INDICATED ON THE DRAWINGS CONFLICT WITH ACTUAL,



BUFFALO | ROCHESTER www.cjsarchitects.com

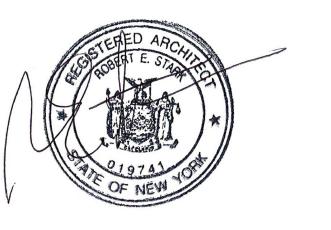

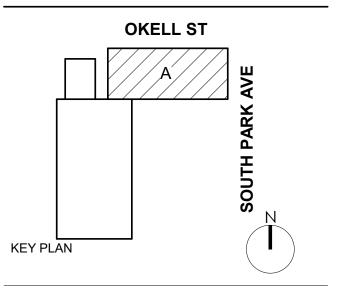

DOFI PROPERTIES

SOUTH PARK MIXED USE

2221 SOUTH PARK AVE BUFFALO, NY 14220

REV.# DESCRIPTION DATE

25	JOB NO.
1/4" = 1'-	SCALE
08/04/	SSUE DATE
G	DRAWN BY
JM	CHECKED BY

THIS IS A SINGLE SHEET OF A COHESIVE SET OF CONSTRUCTION DOCUMENTS (INCLUDING DRAWINGS AND SPECIFICATIONS). INTERPRETATION OF THE INFORMATION AS PRESENTED SHOULD BE BASED ON THE ENTIRE SET OF DOCUMENTS.

DRAWING TITLE


FIRST FLOOR PLAN

A-101

ELIMINATE CLOSETS FROM BEDROOMS - FORCE TENANTS TO UTILIZE THEIR OWN FURNITURE?

ELIMINATE POCKET DOORS FROM BEDROOM TO BATHROOM

ELIMINATE SOUND INSULATION WITHIN UNITS

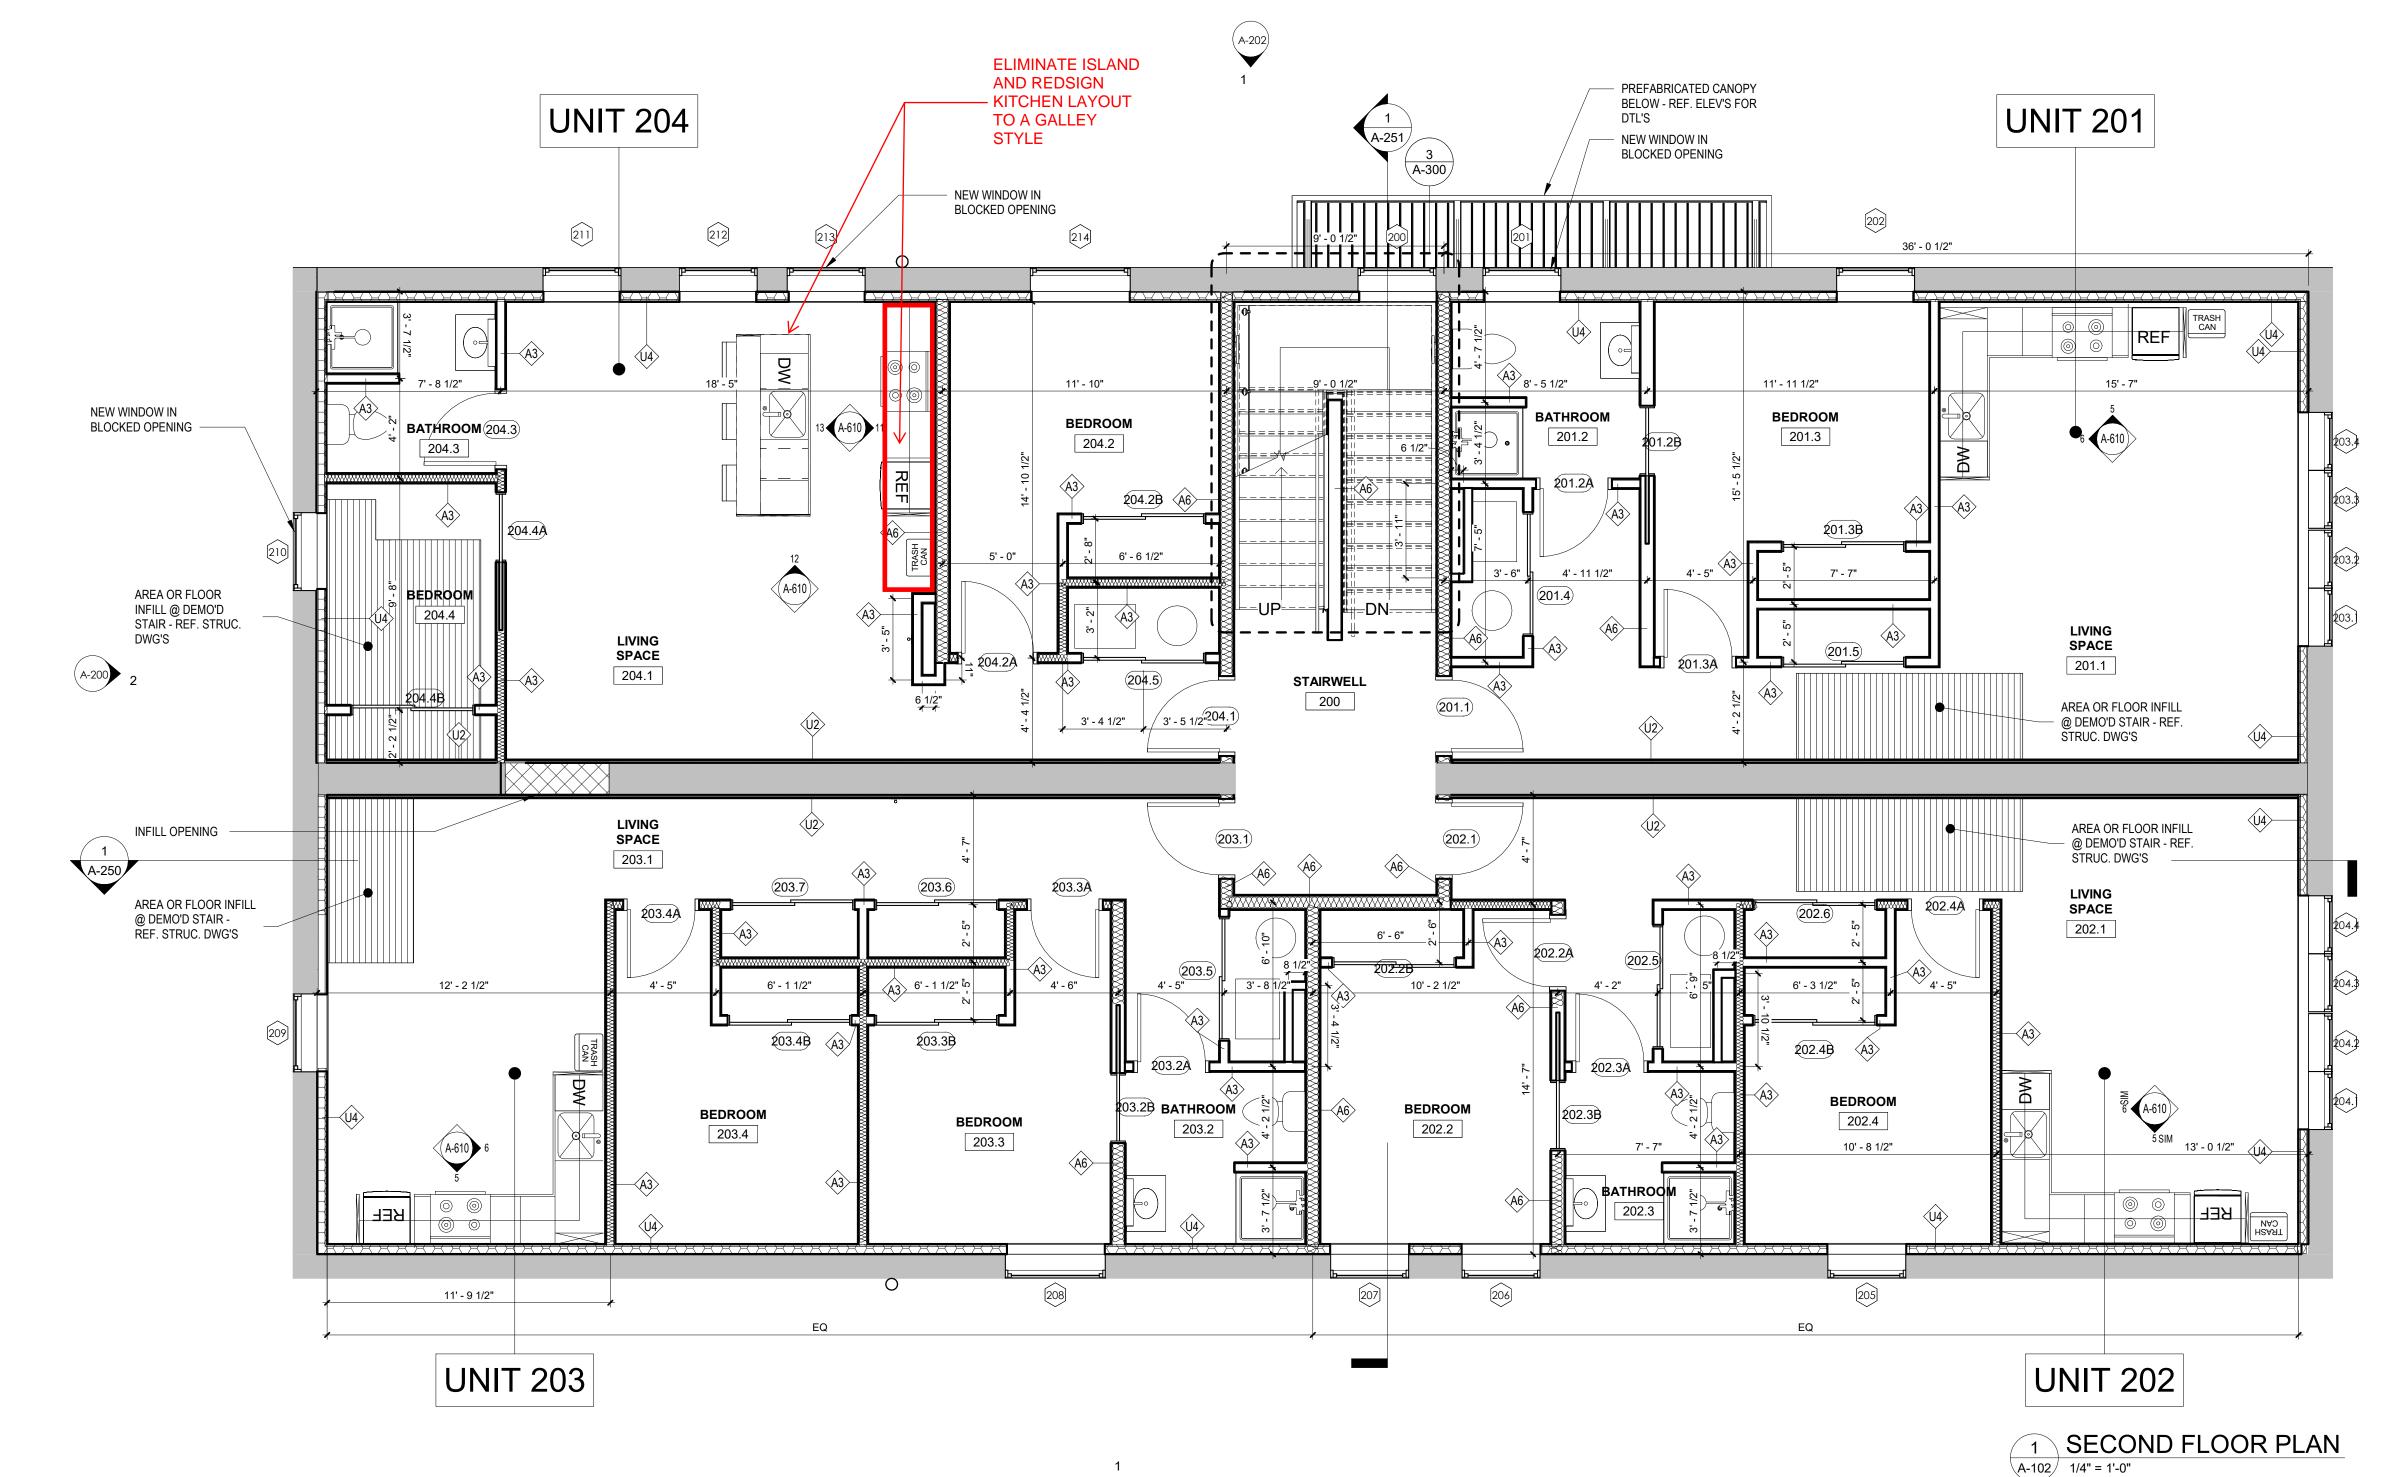

GENERAL PLAN NOTES

- REFERENCE SHEET A-001 MATERIAL LEGEND, SYMBOL LEGEND AND ABBREVIATIONS USED.
- 2. REFERENCE STRUCTURAL DRAWINGS FOR UNIT MASONRY, STEEL, CONCRETE
- ETC. INFORMATION.

 3. REFERENCE ROOM FINISH SCHEDULE, FLOOR PATTERN PLANS & REFLECTED
- CEILING PLANS FOR FINISH INFORMATION.

 4. REFER TO U.L. FIRE RESISTANCE DIRECTORY FOR DETAILS ON FIRE RATED WALLS, COLUMNS ENCLOSURES, FLOOR/CEILING ASSEMBLIES & CEILING/ROOF ASSEMBLIES.
- ALL SUB-CONTRACTORS SHALL VERIFY THAT CONDITIONS PRESENT MEET STANDARD INDUSTRY ACCEPTED CRITERIA FOR ACCEPTING/PERFORMING WORK OF THEIR TRADE. IF CONDITIONS PRESENT WILL NOT FACILITATE PERFORMANCE OF THEIR WORK IN AN ACCEPTABLE FASHION, SAID CONTRACTOR SHALL BRING THE DEFICIENCIES TO THE ATTENTION OF THE CM OR GC. IF WORK PROCEEDS WITHOUT CORRECTING DEFICIENT EXISTING CONDITIONS, ANY COSTS ASSOCIATED WITH REMOVAL & REINSTALLATION OF SAID WORK WILL BE THE RESPONSIBILITY OF THE SUB-CONTRACTOR.
- BATH ROUGH OPENINGS SHALL NOT INTERRUPT UL DESIGN OF FIRE RATED FLOOR, WALL, AND CEILING ASSEMBLIES.
- UNLESS NOTED OTHERWISE, ALL WALLS SHALL BE CONTINUOUS TO THE UNDERSIDE OF FLOOR DECK, FIRE RATED CEILING ASSEMBLY, OR FIRE RATED CEILING/ROOF ASSEMBLY ABOVE.
- 8. PROVIDE DRAFTSTOPPING AT THE TOP OF ALL CONCEALED WALL CAVITIES.
 DRAFTSTOPPING SHALL BE OF AN BCNYS APPROVED MATERIAL AND SHALL
 PREVENT THE PASSAGE OF SMOKE FROM THE WALL CAVITY INTO ANY ADJACENT
 CEILING/FLOOR OR CEILING/ROOF CAVITIES.
- 9. PROVIDE SOLID WOOD BLOCKING AS REINFORCING FOR ALL WALL HUNG ITEMS, INCLUDING BUT NOT LIMITED TO; HANDRAILS, GRAB BARS, FUTURE GRAB BARS, CABINETS, ELEC. PANELS, FIXTURES AND ACCESSORIES.
- MOISTURE RESISTANT GYPSUM WALL BOARD SHALL BE PROVIDED AT ALL WET AREAS (TOILETS, KITCHENS, MOP SINKS, ETC.)
- ALL STRUCTURE., MECH., ELEC., PLUMB. AND FIRE PROTECTION ELEMENTS SHOWN ARE FOR REFERENCE ONLY. CONTRACTOR SHALL REFER TO OTHER SECTIONS OF THE DOCUMENTS AS APPROPRIATE FOR OTHER TRADES. WHERE DISCREPANCIES EXIST BETWEEN ARCH. DRAWINGS AND OTHER TRADES CONTRACTOR SHALL NOTIFY GC OR CM & ARCHITECT PRIOR TO PERFORMING ANY WORK RELATED TO SAID DISCREPANCY.
- CORD.. MECH COVERS, GRILLES, ETC. WITH MECH. DWG'S. COLORS TO BE SELECTED BY ARCHITECT FROM MANUFACTURER'S FULL RANGE, INCLUDING PREMIUM FINISHES/COLORS.
- 13. DOORS LOCATED IN CLOSETS OR PARTITIONS TO BE CENTERED WITHIN WALL UNLESS OTHERWISE NOTED.
- 14. CUSTOM PAINT ELECTRICAL PANEL BOXES IN RESIDENTIAL UNITS MATCH ADJACENT WALL COLOR.
- 15. ALIGN FINISHED FACE OF WALLS WHERE DIFFERENT WALL TYPES ABUT EACH OTHER.

 16. GENERAL ELOOP BLAN NOTES ARRIVED ALL ELOOP BLANS OF THIS PROJECT.
- 16. GENERAL FLOOR PLAN NOTES APPLY TO ALL FLOOR PLANS OF THIS PROJECT.
 17. ALL DIMENSIONS ARE FINISH DIMENSIONS FACE TO FACE OF FINISHES UNLESS
- OTHERWISE NOTED.


 18. ALL DIMENSIONS, MATERIAL INDICATIONS AND NOTES SHOWN ON ONE DRAWING

CONTACT THE ARCHITECT IN WRITING FOR CLARIFICATION.


1 (A-200)


SHALL APPLY TO ALL OTHER SIMILAR DRAWINGS UNLESS OTHERWISE NOTED

19. VERIFY ALL DIMENSIONED CONDITIONS IN THE FIELD PRIOR TO SHOP DRAWING SUBMITTAL/FABRICATION/CONSTRUCTION. WHEN DIMENSIONS AND/OR CONDITIONS AS INDICATED ON THE DRAWINGS CONFLICT WITH ACTUAL,

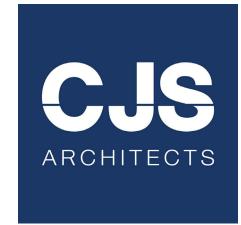

BUFFALO | ROCHESTER www.cjsarchitects.com

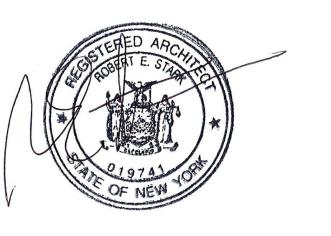

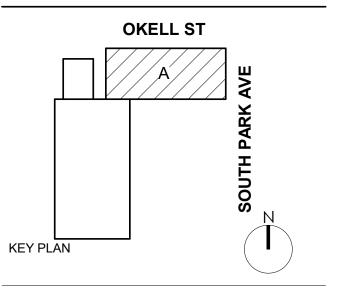

DOFI PROPERTIES

SOUTH PARK MIXED USE

2221 SOUTH PARK AVE BUFFALO, NY 14220

REV. # DESCRIPTION DATE

JOB NO.	2508
SCALE	1/4" = 1'-0"
ISSUE DATE	08/04/25
DRAWN BY	Gac
CHECKED BY	JMC

THIS IS A SINGLE SHEET OF A COHESIVE SET OF CONSTRUCTION DOCUMENTS (INCLUDING DRAWINGS AND SPECIFICATIONS). INTERPRETATION OF THE INFORMATION AS PRESENTED SHOULD BE BASED ON THE ENTIRE SET OF DOCUMENTS.

DRAWING TITLE

SECOND FLOOR PLAN


A-102

ELIMINATE CLOSETS FROM BEDROOMS - FORCE TENANTS TO UTILIZE

THEIR OWN FURNITURE?

ELIMINATE POCKET DOORS FROM BEDROOM TO BATHROOM


ELIMINATE SOUND INSULATION WITHIN UNITS

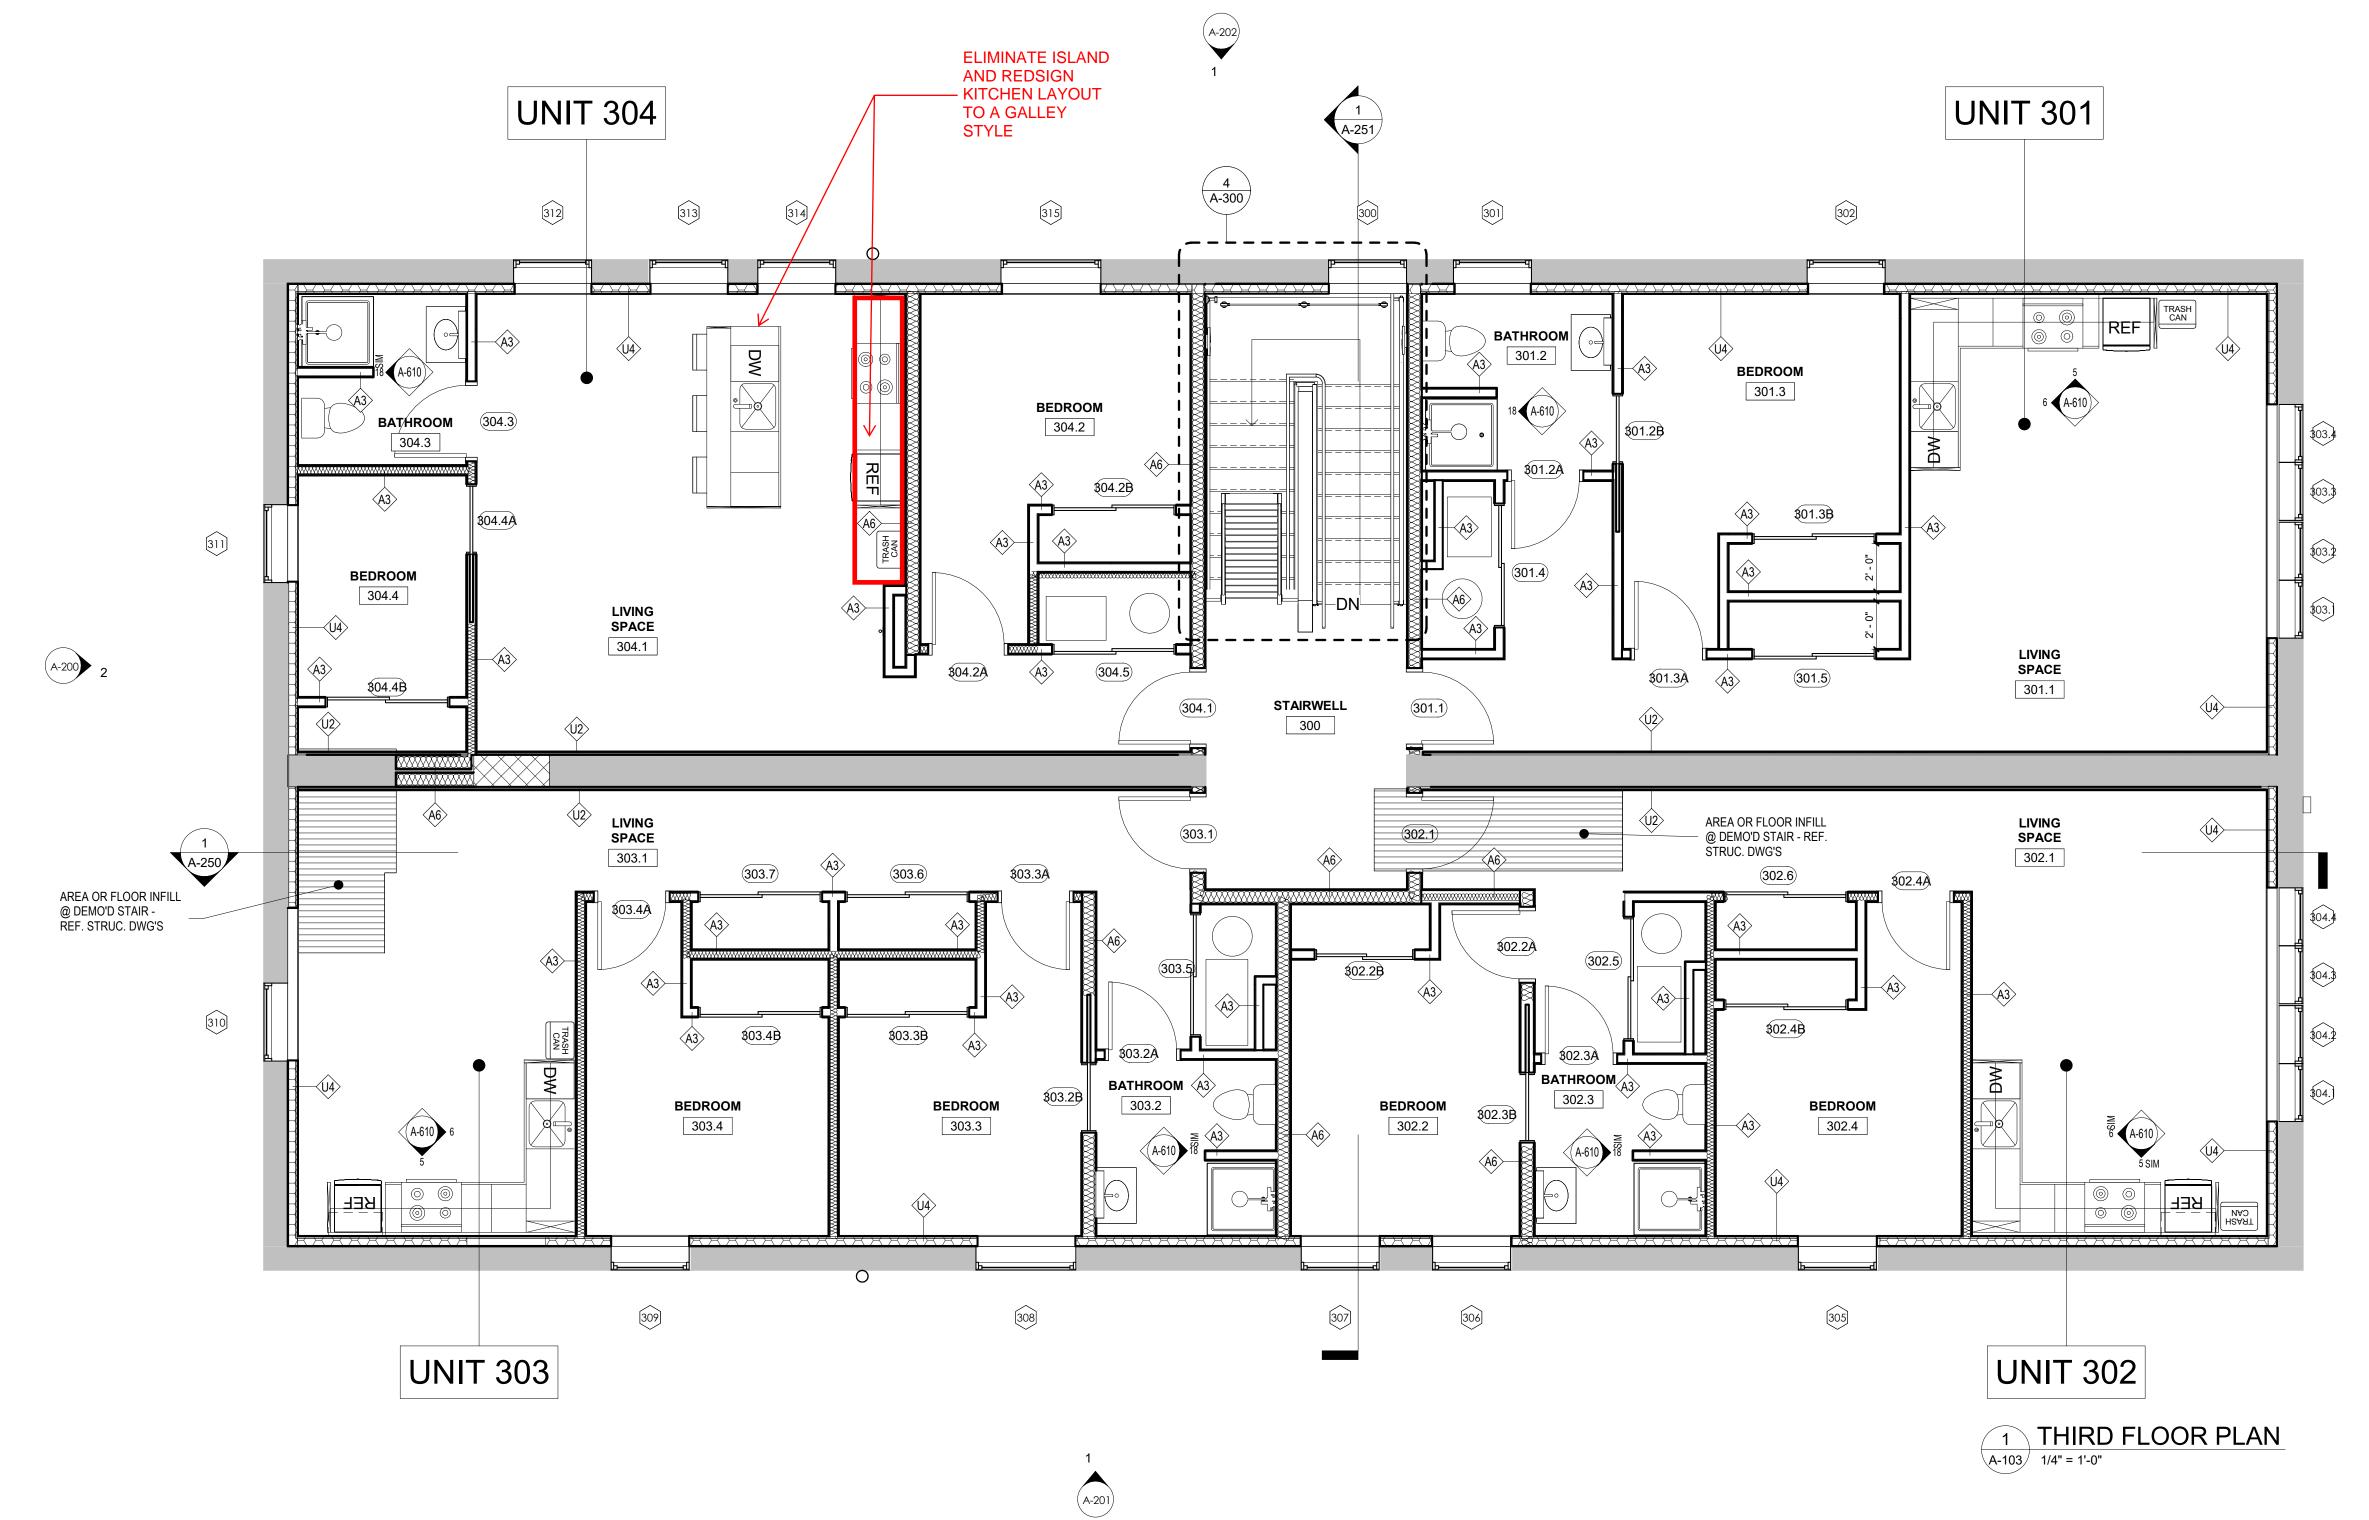


GENERAL PLAN NOTES


- REFERENCE SHEET A-001 MATERIAL LEGEND, SYMBOL LEGEND AND ABBREVIATIONS USED.
- REFERENCE STRUCTURAL DRAWINGS FOR UNIT MASONRY, STEEL, CONCRETE
- ETC. INFORMATION. REFERENCE ROOM FINISH SCHEDULE, FLOOR PATTERN PLANS & REFLECTED
- CEILING PLANS FOR FINISH INFORMATION. REFER TO U.L. FIRE RESISTANCE DIRECTORY FOR DETAILS ON FIRE RATED WALLS, COLUMNS ENCLOSURES, FLOOR/CEILING ASSEMBLIES & CEILING/ROOF ASSEMBLIES.
- ALL SUB-CONTRACTORS SHALL VERIFY THAT CONDITIONS PRESENT MEET STANDARD INDUSTRY ACCEPTED CRITERIA FOR ACCEPTING/PERFORMING WORK OF THEIR TRADE. IF CONDITIONS PRESENT WILL NOT FACILITATE PERFORMANCE OF THEIR WORK IN AN ACCEPTABLE FASHION, SAID CONTRACTOR SHALL BRING THE DEFICIENCIES TO THE ATTENTION OF THE CM OR GC. IF WORK PROCEEDS WITHOUT CORRECTING DEFICIENT EXISTING CONDITIONS, ANY COSTS ASSOCIATED WITH REMOVAL & REINSTALLATION OF SAID WORK WILL BE THE
- RESPONSIBILITY OF THE SUB-CONTRACTOR. BATH ROUGH OPENINGS SHALL NOT INTERRUPT UL DESIGN OF FIRE RATED FLOOR, WALL, AND CEILING ASSEMBLIES.
- UNLESS NOTED OTHERWISE, ALL WALLS SHALL BE CONTINUOUS TO THE UNDERSIDE OF FLOOR DECK, FIRE RATED CEILING ASSEMBLY, OR FIRE RATED CEILING/ROOF ASSEMBLY ABOVE.
- PROVIDE DRAFTSTOPPING AT THE TOP OF ALL CONCEALED WALL CAVITIES. DRAFTSTOPPING SHALL BE OF AN BCNYS APPROVED MATERIAL AND SHALL PREVENT THE PASSAGE OF SMOKE FROM THE WALL CAVITY INTO ANY ADJACENT CEILING/FLOOR OR CEILING/ROOF CAVITIES.
- PROVIDE SOLID WOOD BLOCKING AS REINFORCING FOR ALL WALL HUNG ITEMS, INCLUDING BUT NOT LIMITED TO; HANDRAILS, GRAB BARS, FUTURE GRAB BARS, CABINETS, ELEC. PANELS, FIXTURES AND ACCESSORIES.
- MOISTURE RESISTANT GYPSUM WALL BOARD SHALL BE PROVIDED AT ALL WET AREAS (TOILETS, KITCHENS, MOP SINKS, ETC.)
- ALL STRUCTURE., MECH., ELEC., PLUMB. AND FIRE PROTECTION ELEMENTS SHOWN ARE FOR REFERENCE ONLY. CONTRACTOR SHALL REFER TO OTHER SECTIONS OF THE DOCUMENTS AS APPROPRIATE FOR OTHER TRADES. WHERE DISCREPANCIES EXIST BETWEEN ARCH. DRAWINGS AND OTHER TRADES CONTRACTOR SHALL NOTIFY GC OR CM & ARCHITECT PRIOR TO PERFORMING ANY WORK RELATED TO SAID DISCREPANCY.
- CORD.. MECH COVERS, GRILLES, ETC. WITH MECH. DWG'S. COLORS TO BE SELECTED BY ARCHITECT FROM MANUFACTURER'S FULL RANGE, INCLUDING PREMIUM FINISHES/COLORS.
- DOORS LOCATED IN CLOSETS OR PARTITIONS TO BE CENTERED WITHIN WALL UNLESS OTHERWISE NOTED.
- CUSTOM PAINT ELECTRICAL PANEL BOXES IN RESIDENTIAL UNITS MATCH ADJACENT WALL COLOR.
- ALIGN FINISHED FACE OF WALLS WHERE DIFFERENT WALL TYPES ABUT EACH GENERAL FLOOR PLAN NOTES APPLY TO ALL FLOOR PLANS OF THIS PROJECT.
- ALL DIMENSIONS ARE FINISH DIMENSIONS FACE TO FACE OF FINISHES UNLESS OTHERWISE NOTED.
- ALL DIMENSIONS, MATERIAL INDICATIONS AND NOTES SHOWN ON ONE DRAWING SHALL APPLY TO ALL OTHER SIMILAR DRAWINGS UNLESS OTHERWISE NOTED
- VERIFY ALL DIMENSIONED CONDITIONS IN THE FIELD PRIOR TO SHOP DRAWING SUBMITTAL/FABRICATION/CONSTRUCTION. WHEN DIMENSIONS AND/OR CONDITIONS AS INDICATED ON THE DRAWINGS CONFLICT WITH ACTUAL, CONTACT THE ARCHITECT IN WRITING FOR CLARIFICATION.

1 (A-200)

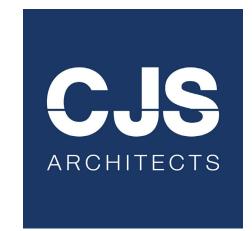

BUFFALO | ROCHESTER www.cjsarchitects.com

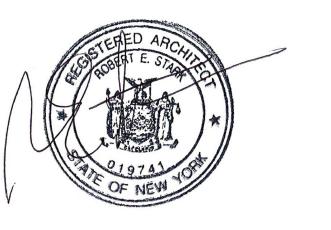

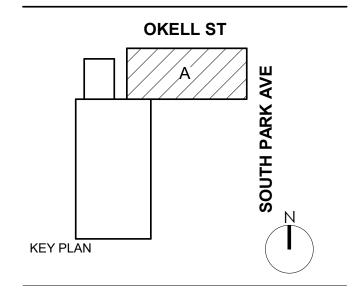

DOFI PROPERTIES

SOUTH PARK MIXED USE

2221 SOUTH PARK AVE BUFFALO, NY 14220

REV.# DESCRIPTION DATE


IOB NO.	2508
SCALE	1/4" = 1'-0"
SSUE DATE	08/04/25
DRAWN BY	Gac
CHECKED BY	JMC

THIS IS A SINGLE SHEET OF A COHESIVE SET OF CONSTRUCTION DOCUMENTS (INCLUDING DRAWINGS AND SPECIFICATIONS). INTERPRETATION OF THE INFORMATION AS PRESENTED SHOULD BE BASED ON THE ENTIRE SET OF DOCUMENTS.

DRAWING TITLE

THIRD FLOOR **PLAN**

A-103

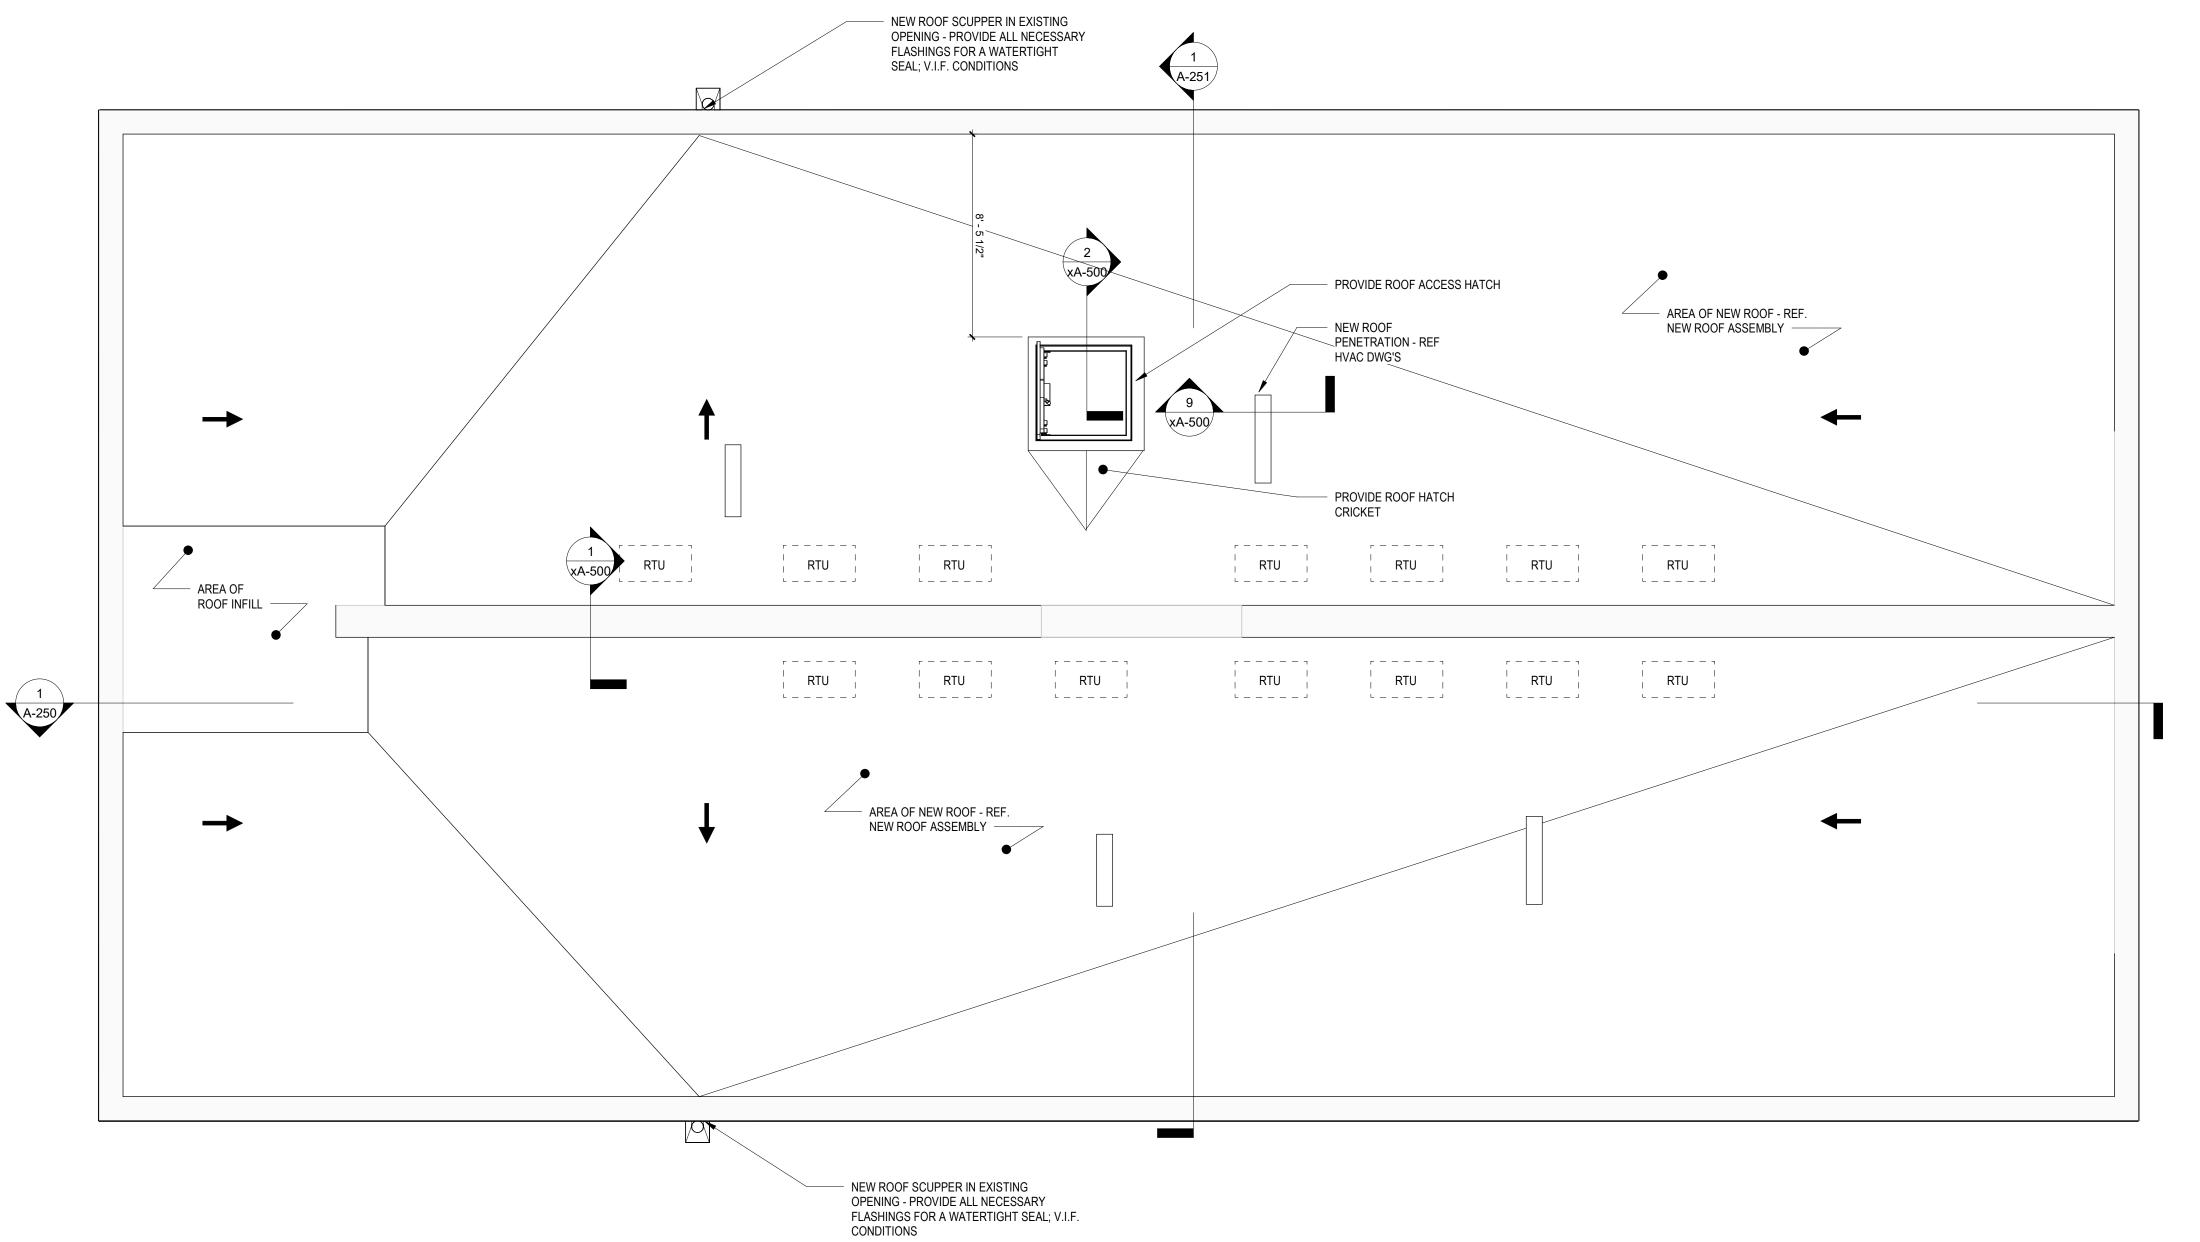

GENERAL PLAN NOTES

ASSEMBLIES.

- REFERENCE SHEET A-001 MATERIAL LEGEND, SYMBOL LEGEND AND ABBREVIATIONS USED.
- REFERENCE STRUCTURAL DRAWINGS FOR UNIT MASONRY, STEEL, CONCRETE
- ETC. INFORMATION. REFERENCE ROOM FINISH SCHEDULE, FLOOR PATTERN PLANS & REFLECTED
- CEILING PLANS FOR FINISH INFORMATION. REFER TO U.L. FIRE RESISTANCE DIRECTORY FOR DETAILS ON FIRE RATED WALLS, COLUMNS ENCLOSURES, FLOOR/CEILING ASSEMBLIES & CEILING/ROOF
- ALL SUB-CONTRACTORS SHALL VERIFY THAT CONDITIONS PRESENT MEET STANDARD INDUSTRY ACCEPTED CRITERIA FOR ACCEPTING/PERFORMING WORK OF THEIR TRADE. IF CONDITIONS PRESENT WILL NOT FACILITATE PERFORMANCE OF THEIR WORK IN AN ACCEPTABLE FASHION, SAID CONTRACTOR SHALL BRING THE DEFICIENCIES TO THE ATTENTION OF THE CM OR GC. IF WORK PROCEEDS WITHOUT CORRECTING DEFICIENT EXISTING CONDITIONS, ANY COSTS ASSOCIATED WITH REMOVAL & REINSTALLATION OF SAID WORK WILL BE THE RESPONSIBILITY OF THE SUB-CONTRACTOR.
- BATH ROUGH OPENINGS SHALL NOT INTERRUPT UL DESIGN OF FIRE RATED FLOOR, WALL, AND CEILING ASSEMBLIES.
- UNLESS NOTED OTHERWISE, ALL WALLS SHALL BE CONTINUOUS TO THE UNDERSIDE OF FLOOR DECK, FIRE RATED CEILING ASSEMBLY, OR FIRE RATED CEILING/ROOF ASSEMBLY ABOVE.
- PROVIDE DRAFTSTOPPING AT THE TOP OF ALL CONCEALED WALL CAVITIES. DRAFTSTOPPING SHALL BE OF AN BCNYS APPROVED MATERIAL AND SHALL PREVENT THE PASSAGE OF SMOKE FROM THE WALL CAVITY INTO ANY ADJACENT CEILING/FLOOR OR CEILING/ROOF CAVITIES.
- PROVIDE SOLID WOOD BLOCKING AS REINFORCING FOR ALL WALL HUNG ITEMS, INCLUDING BUT NOT LIMITED TO; HANDRAILS, GRAB BARS, FUTURE GRAB BARS,
- CABINETS, ELEC. PANELS, FIXTURES AND ACCESSORIES. MOISTURE RESISTANT GYPSUM WALL BOARD SHALL BE PROVIDED AT ALL WET AREAS (TOILETS, KITCHENS, MOP SINKS, ETC.)
- ALL STRUCTURE., MECH., ELEC., PLUMB. AND FIRE PROTECTION ELEMENTS SHOWN ARE FOR REFERENCE ONLY. CONTRACTOR SHALL REFER TO OTHER SECTIONS OF THE DOCUMENTS AS APPROPRIATE FOR OTHER TRADES. WHERE DISCREPANCIES EXIST BETWEEN ARCH. DRAWINGS AND OTHER TRADES CONTRACTOR SHALL NOTIFY GC OR CM & ARCHITECT PRIOR TO PERFORMING ANY WORK RELATED TO SAID DISCREPANCY.
- CORD.. MECH COVERS, GRILLES, ETC. WITH MECH. DWG'S. COLORS TO BE SELECTED BY ARCHITECT FROM MANUFACTURER'S FULL RANGE, INCLUDING PREMIUM FINISHES/COLORS.
- DOORS LOCATED IN CLOSETS OR PARTITIONS TO BE CENTERED WITHIN WALL
- UNLESS OTHERWISE NOTED. CUSTOM PAINT ELECTRICAL PANEL BOXES IN RESIDENTIAL UNITS - MATCH ADJACENT WALL COLOR.
- ALIGN FINISHED FACE OF WALLS WHERE DIFFERENT WALL TYPES ABUT EACH
- GENERAL FLOOR PLAN NOTES APPLY TO ALL FLOOR PLANS OF THIS PROJECT. ALL DIMENSIONS ARE FINISH DIMENSIONS - FACE TO FACE OF FINISHES UNLESS
- OTHERWISE NOTED. ALL DIMENSIONS, MATERIAL INDICATIONS AND NOTES SHOWN ON ONE DRAWING
- SHALL APPLY TO ALL OTHER SIMILAR DRAWINGS UNLESS OTHERWISE NOTED VERIFY ALL DIMENSIONED CONDITIONS IN THE FIELD PRIOR TO SHOP DRAWING SUBMITTAL/FABRICATION/CONSTRUCTION. WHEN DIMENSIONS AND/OR CONDITIONS AS INDICATED ON THE DRAWINGS CONFLICT WITH ACTUAL, CONTACT THE ARCHITECT IN WRITING FOR CLARIFICATION.

NEW ROOF ASSEMBLY: -POLY VAPOR BARRIER OVER EXISTING WOOD SHEATHING (REPLACE SHEATHING WHERE


-MIN. R30 CONTINUOUS RIGID ROOD INSUL. (PROVIDE CRICKETING WHERE/IF REQ'D. EXISTING STRUCT. SLOPES TOWARDS EXISTING SCUPPER LOCATIONS TO BE RE-USED) -OPTIONAL 1/2" COVERBOARD - COORD. W/ ROOFING CONTRACTOR AND OWNER ON INCLUSION CONSIDER ALTERNATE -60 MIL EPDM MEMBRANE ROOFING MATERIALS. IS TPO


CHEAPER RIGHT NOW?

CONTRACTOR TO INSTALL ROOFING SYSTEM PER MANUFACTURERS WRITTEN INSTRUCTIONS AND DETAILS. PROVIDE ALL REQ-D FLASHINGS AND OTHER MATERIALS AT PENETRATIONS, PARAPETS, COPINGS, INTERFACES W/ OTHER MATERIALS, ETC CONTRACTOR SHALL COORD. A FINAL INSPECTION W/ A MANUFACTURER CERTIFIED REPRESENTATIVE TO ENSURE FULL PRODUCT WARRANTY WILL BE PROVIDED.



BUFFALO | ROCHESTER www.cjsarchitects.com

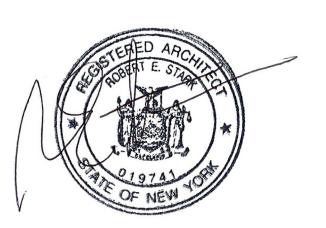

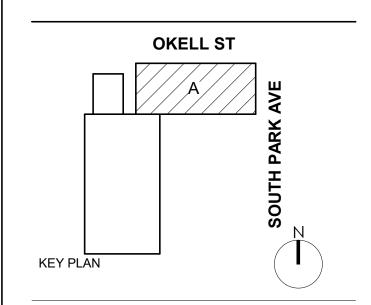

DOFI PROPERTIES

SOUTH PARK MIXED USE

2221 SOUTH PARK AVE BUFFALO, NY 14220

REV.#	DESCRIPTION	DATE
-		

JOB NO.	250
SCALE	1/4" = 1'-
ISSUE DATE	08/04/2
DRAWN BY	Auth
CHECKED BY	Check

THIS IS A SINGLE SHEET OF A COHESIVE SET OF CONSTRUCTION DOCUMENTS (INCLUDING DRAWINGS AND SPECIFICATIONS). INTERPRETATION OF THE INFORMATION AS PRESENTED SHOULD BE BASED ON THE ENTIRE SET OF DOCUMENTS.

DRAWING TITLE

ROOF PLAN

A-104


PERMIT SET

1 ROOF PLAN A-104 1/4" = 1'-0"

G.C. SHALL RETAIN A QUALIFIED MASON TO EXAMINE ALL EXTERIOR WALLS. MASON SHALL REMOVE PARGING WHERE FAILING AND REPARGE IN A MANNER CONSISTENT WITH THE EXISTING CONDITIONS. MASONRY INFILLS TO REMAIN SHALL BE EVALUATED AND REPAIRED/REPOINTED AS NEEDED. ALL ABANDONED WALL OPENINGS SHALL BE INFILLED WITH MASONRY IN A MANNER CONSISTENT WITH THE EXISTING INFILLS. V.I.F. ALL EXISTING CONDITIONS.





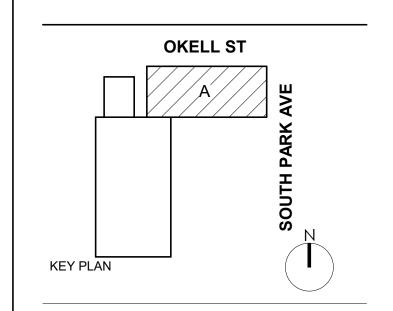

DOFI PROPERTIES

SOUTH PARK MIXED USE

2221 SOUTH PARK AVE BUFFALO, NY 14220

DESCRIPTION

JOB NO.	2508
SCALE	1/4" = 1'-0"
ISSUE DATE	08/04/25
DRAWN BY	Gac
CHECKED BY	JMC


THIS IS A SINGLE SHEET OF A COHESIVE SET OF CONSTRUCTION DOCUMENTS (INCLUDING DRAWINGS AND SPECIFICATIONS). INTERPRETATION OF THE INFORMATION AS PRESENTED SHOULD BE BASED ON THE ENTIRE SET OF DOCUMENTS.

DRAWING TITLE

REV.#

EXTERIOR ELEVATIONS


A-200

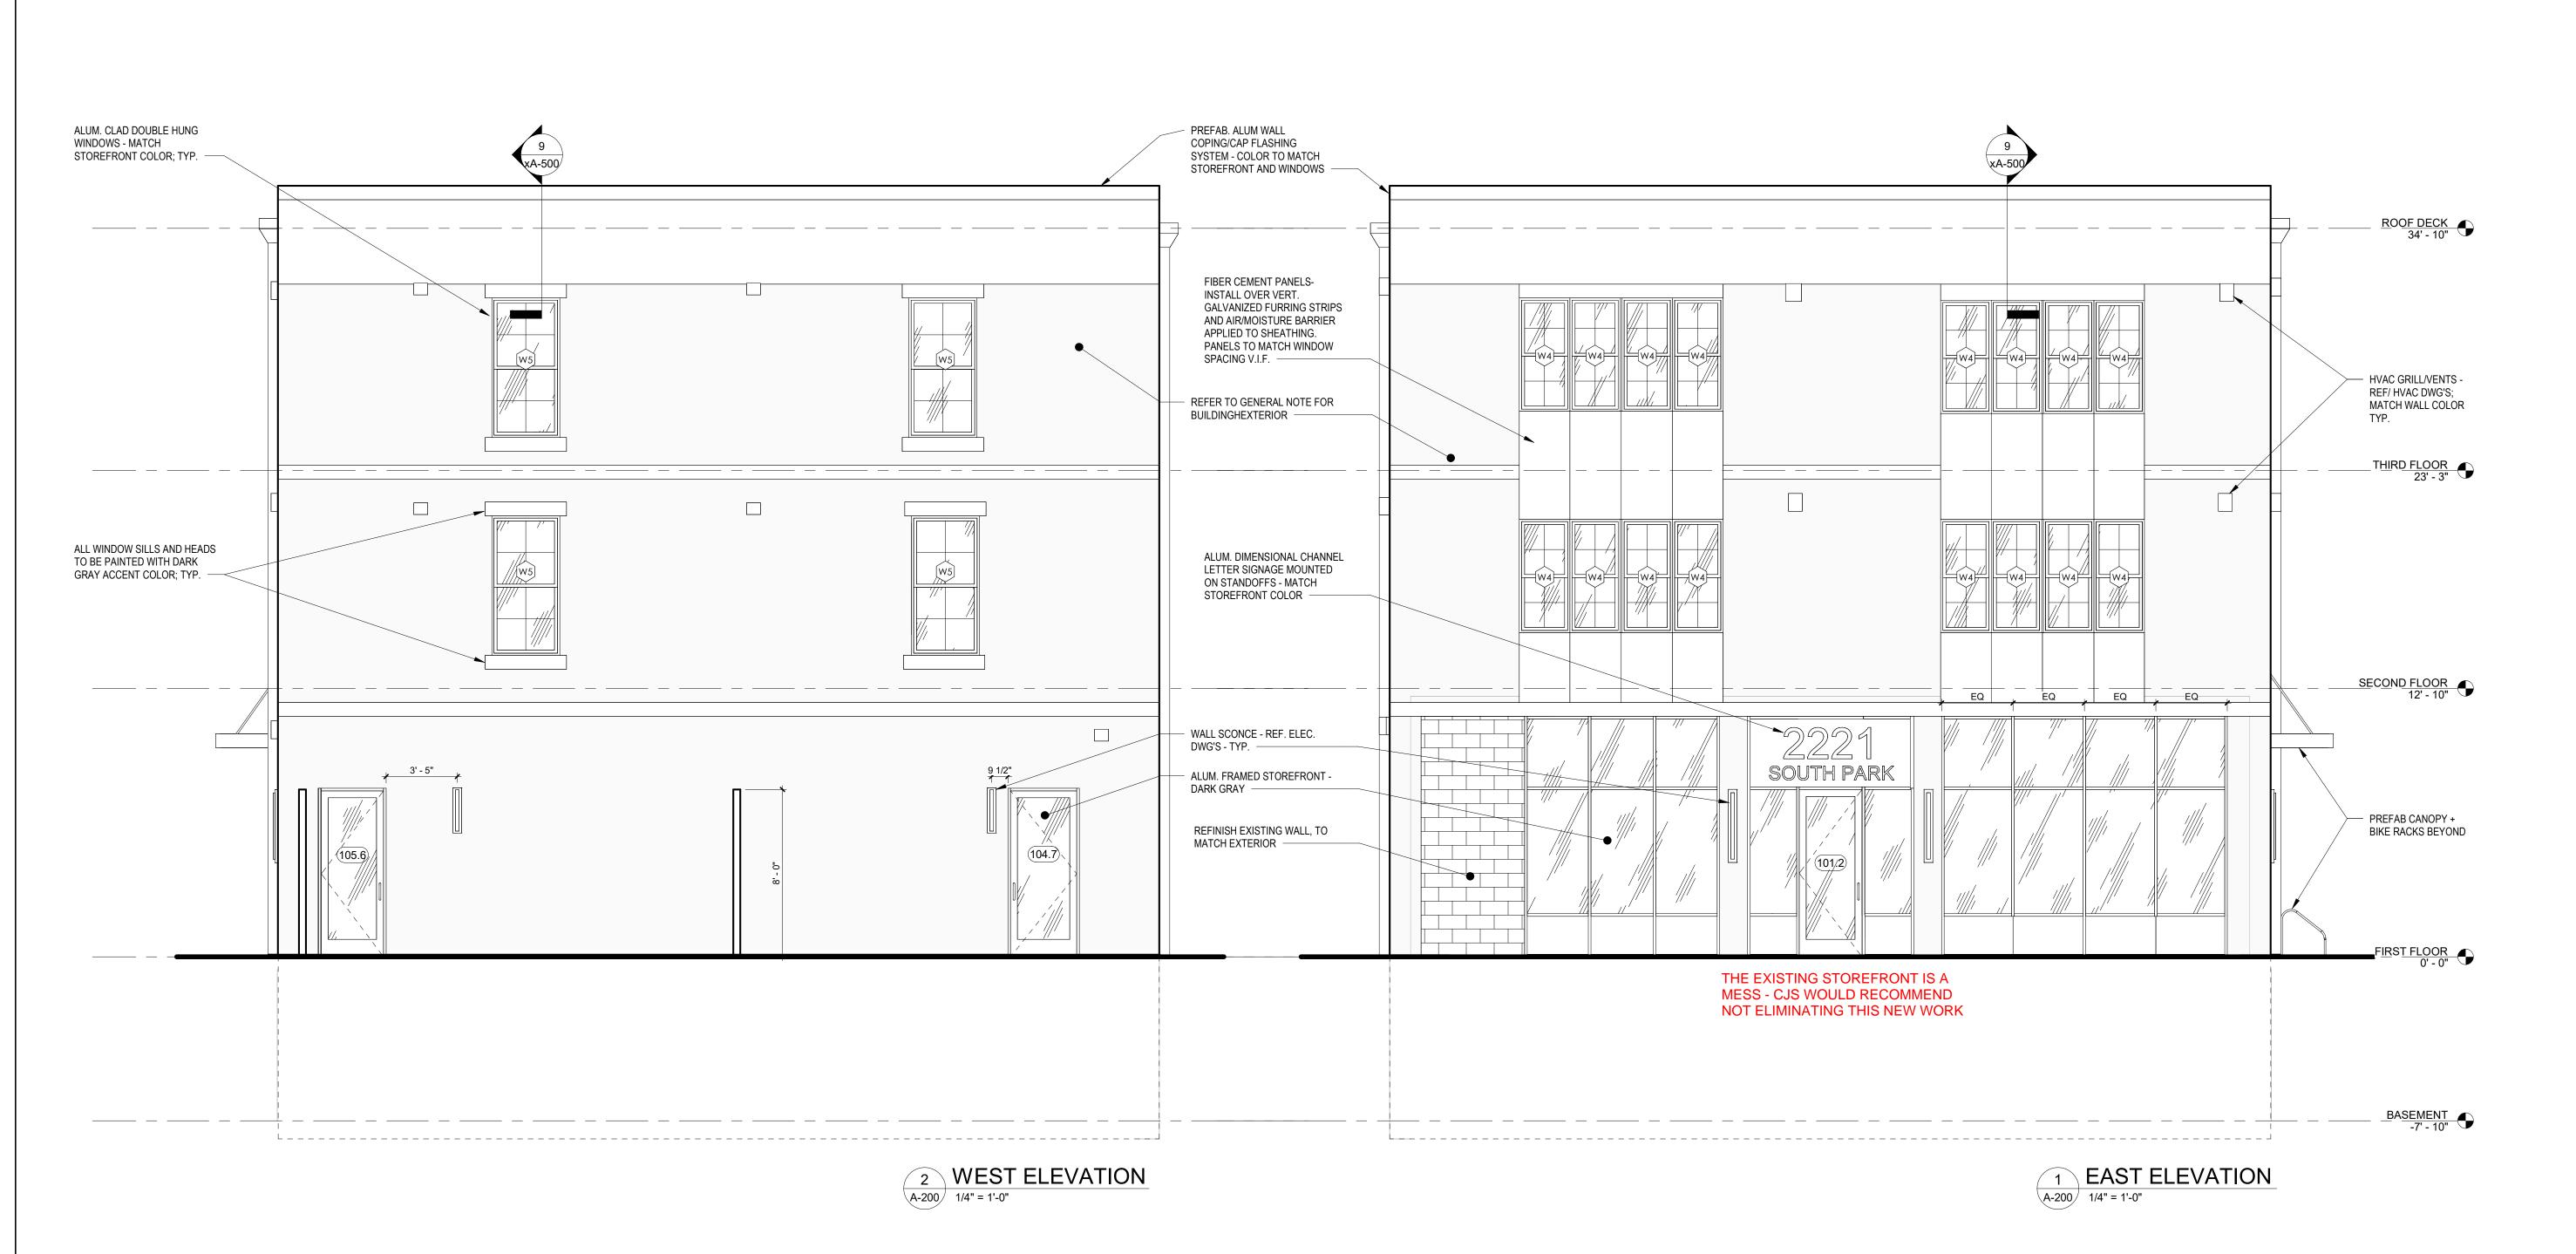

G.C. SHALL RETAIN A QUALIFIED MASON TO EXAMINE ALL EXTERIOR WALLS. MASON SHALL REMOVE PARGING WHERE FAILING AND REPARGE IN A MANNER CONSISTENT WITH THE EXISTING CONDITIONS. MASONRY INFILLS TO REMAIN SHALL BE EVALUATED AND REPAIRED/REPOINTED AS NEEDED. ALL ABANDONED WALL OPENINGS SHALL BE INFILLED WITH MASONRY IN A MANNER CONSISTENT WITH THE EXISTING INFILLS. V.I.F. ALL EXISTING CONDITIONS.





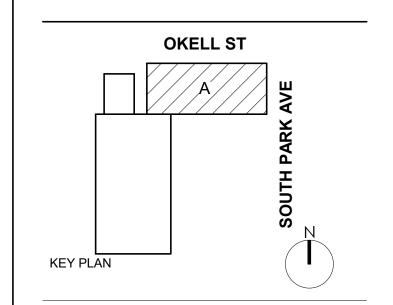

DOFI PROPERTIES

SOUTH PARK MIXED USE

2221 SOUTH PARK AVE BUFFALO, NY 14220

DESCRIPTION

DATE

JOB NO.	2508
SCALE	1/4" = 1'-0"
ISSUE DATE	08/04/25
DRAWN BY	Gac
CHECKED BY	JMC

THIS IS A SINGLE SHEET OF A COHESIVE SET OF CONSTRUCTION DOCUMENTS (INCLUDING DRAWINGS AND SPECIFICATIONS). INTERPRETATION OF THE INFORMATION AS PRESENTED SHOULD BE BASED ON THE ENTIRE SET OF DOCUMENTS.


DRAWING TITLE

REV.#

EXTERIOR ELEVATIONS


A-201


-20 i

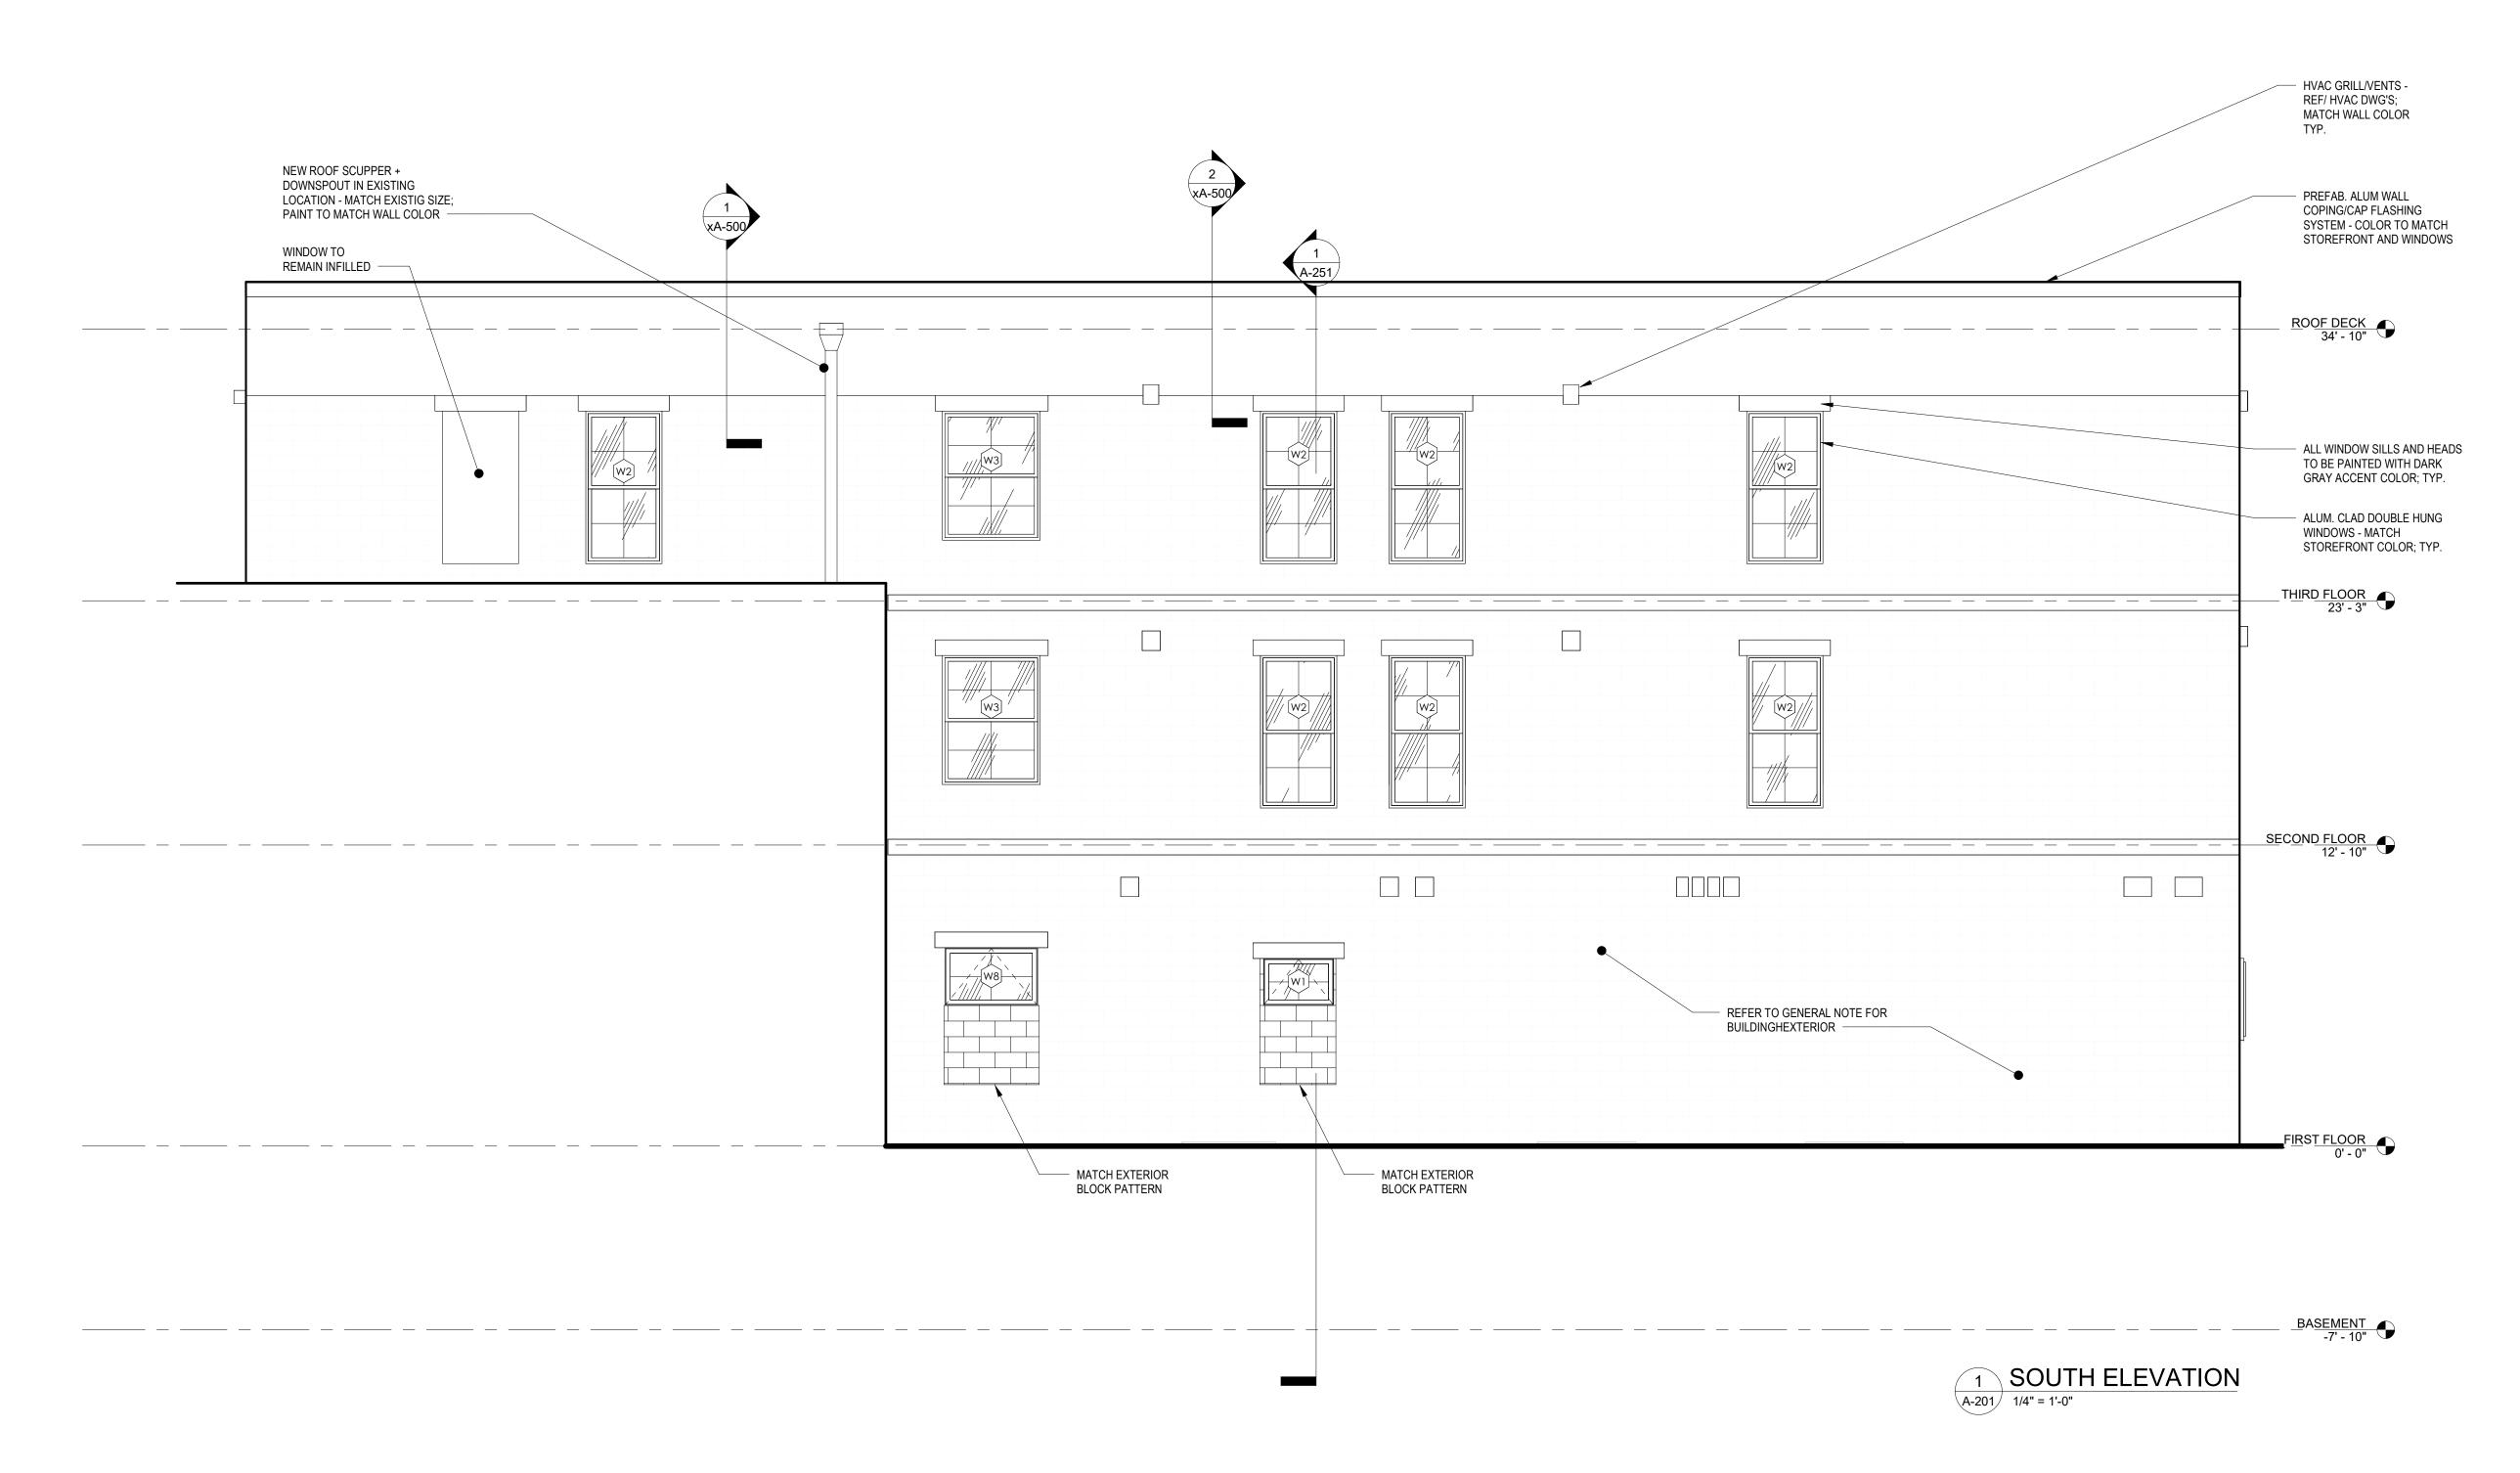

G.C. SHALL RETAIN A QUALIFIED MASON TO EXAMINE ALL EXTERIOR WALLS. MASON SHALL REMOVE PARGING WHERE FAILING AND REPARGE IN A MANNER CONSISTENT WITH THE EXISTING CONDITIONS. MASONRY INFILLS TO REMAIN SHALL BE EVALUATED AND REPAIRED/REPOINTED AS NEEDED. ALL ABANDONED WALL OPENINGS SHALL BE INFILLED WITH MASONRY IN A MANNER CONSISTENT WITH THE EXISTING INFILLS. V.I.F. ALL EXISTING CONDITIONS.



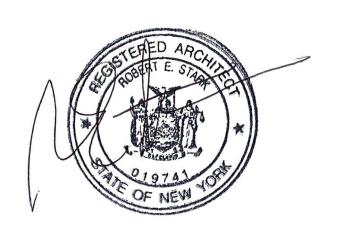

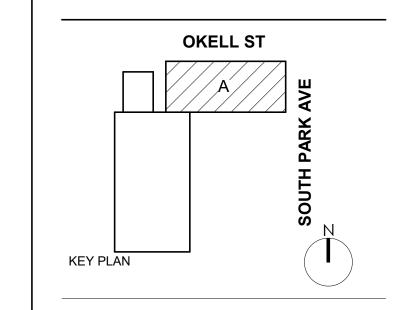

DOFI PROPERTIES

SOUTH PARK MIXED USE

2221 SOUTH PARK AVE BUFFALO, NY 14220

DESCRIPTION

DATE

PERMIT SET

JOB NO.	2508
SCALE	1/4" = 1'-0"
ISSUE DATE	08/04/25
DRAWN BY	Author
CHECKED BY	Checker


THIS IS A SINGLE SHEET OF A COHESIVE
SET OF CONSTRUCTION DOCUMENTS
(INCLUDING DRAWINGS AND SPECIFICATIONS).
INTERPRETATION OF THE INFORMATION
AS PRESENTED SHOULD BE BASED ON
THE ENTIRE SET OF DOCUMENTS.


DRAWING TITLE

REV.#

EXTERIOR ELEVATION


A-202

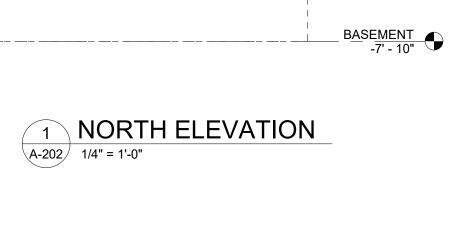

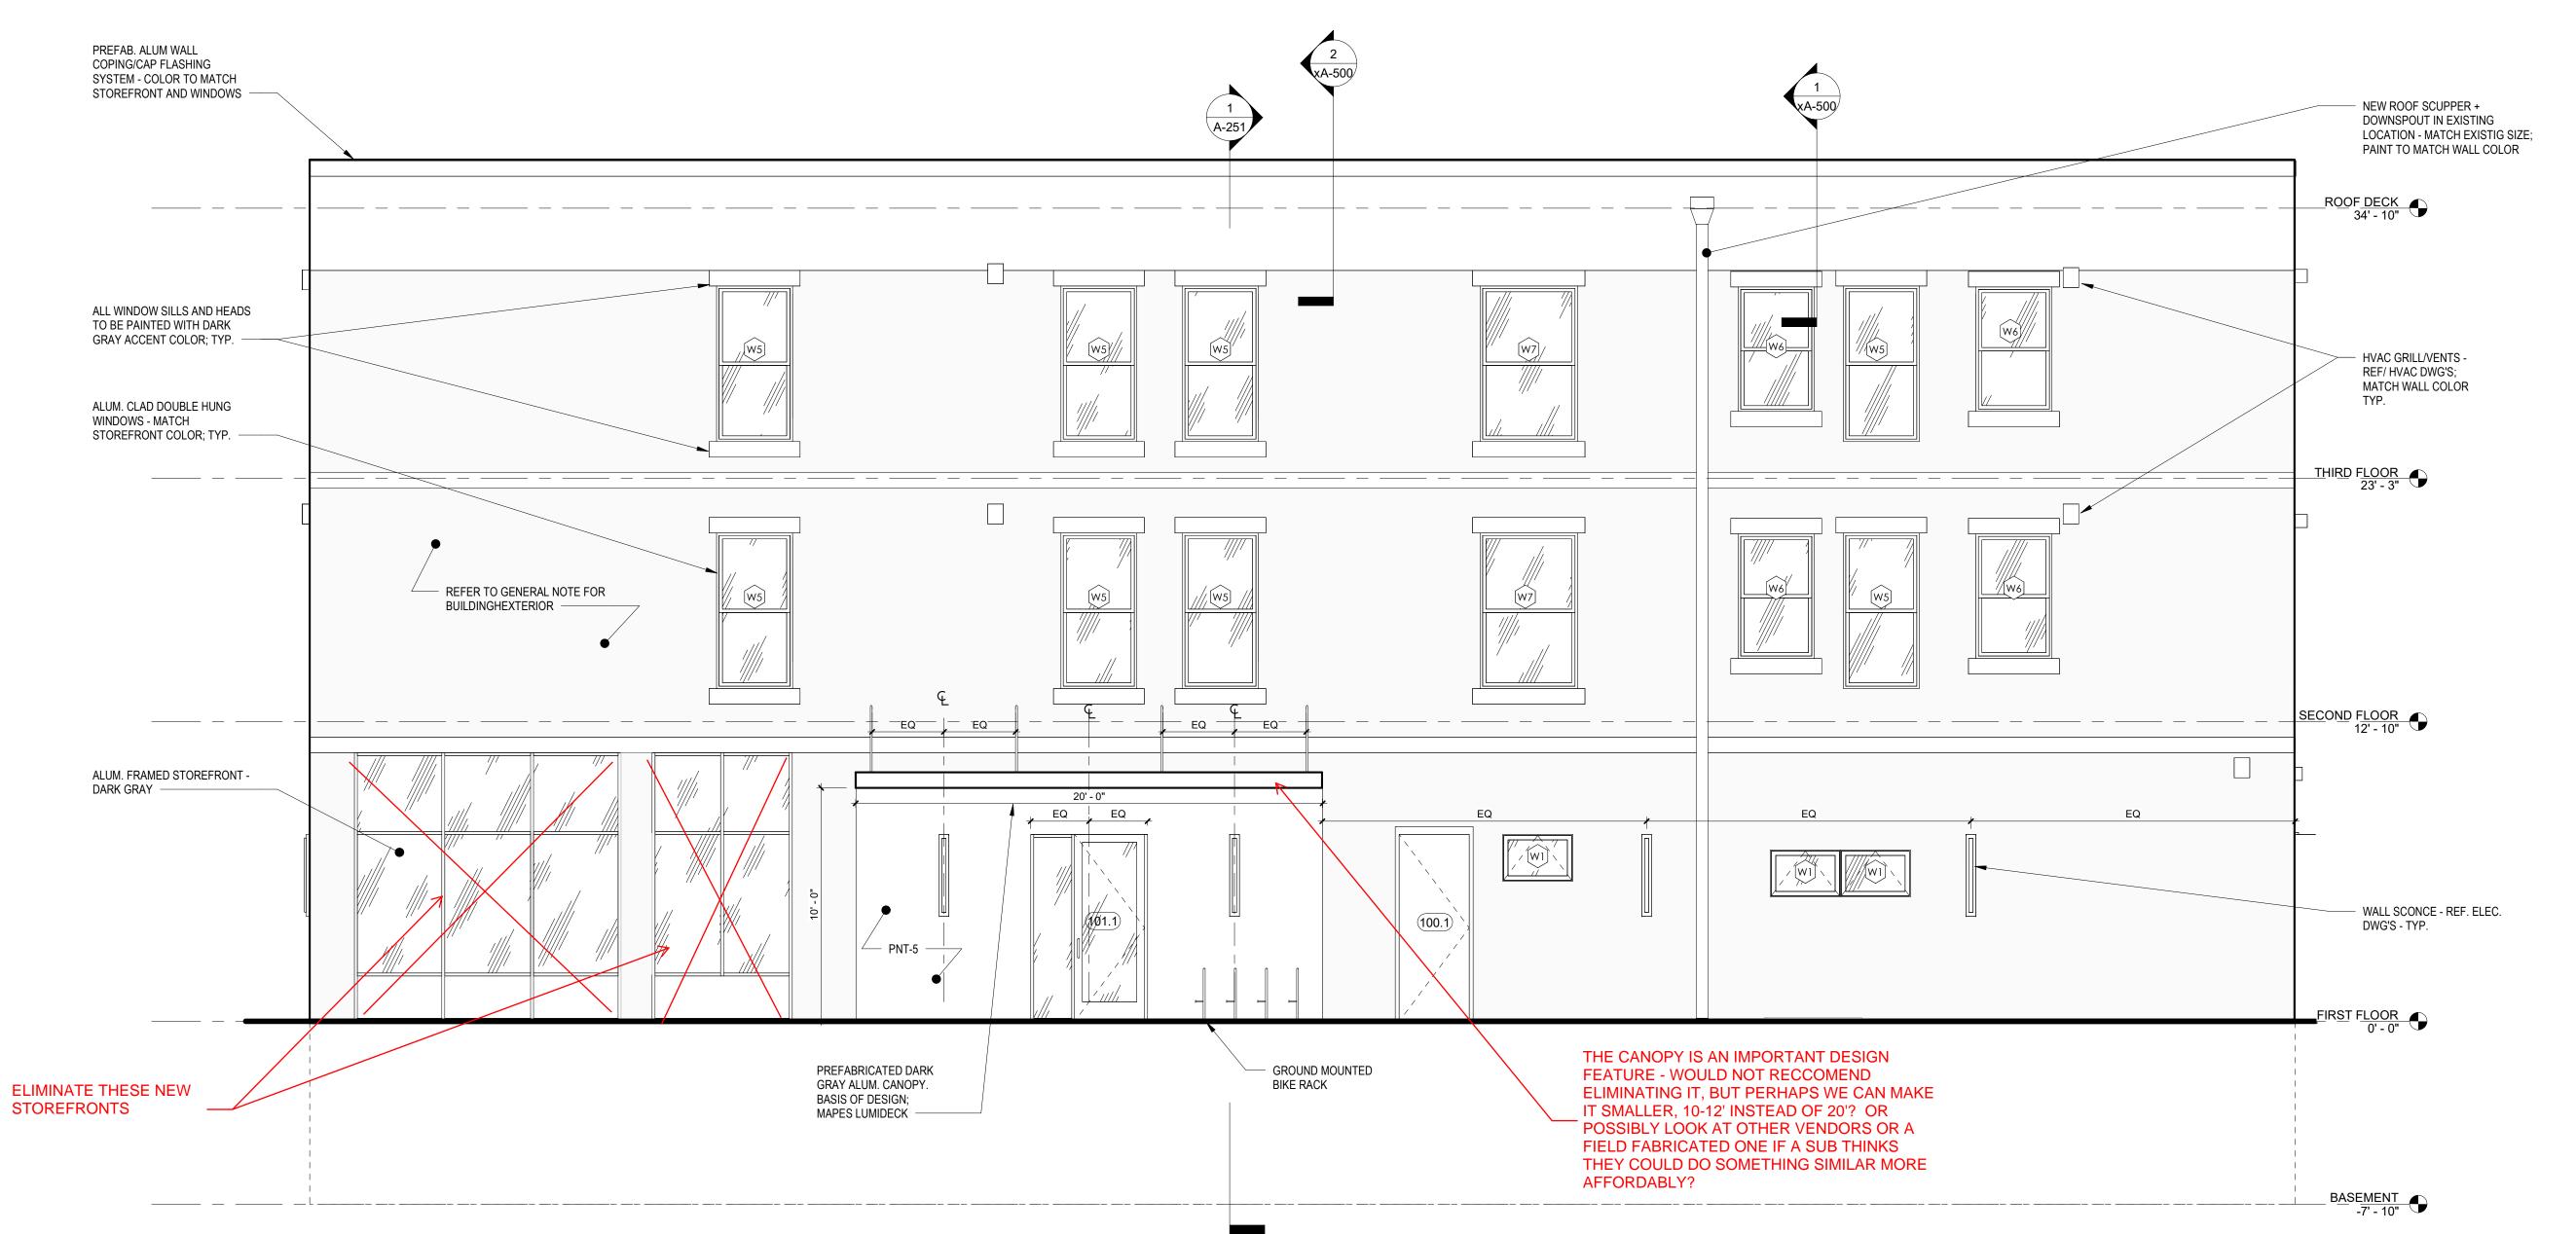





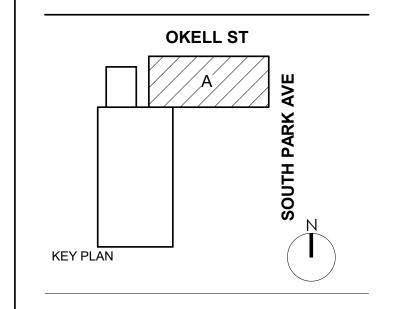

SOUTH PARK MIXED USE

2221 SOUTH PARK AVE BUFFALO, NY 14220

DESCRIPTION

JOB NO.	2508
SCALE	1/4" = 1'-0"
ISSUE DATE	08/04/25
DRAWN BY	XXX
CHECKED BY	XXX

DATE


THIS IS A SINGLE SHEET OF A COHESIVE SET OF CONSTRUCTION DOCUMENTS (INCLUDING DRAWINGS AND SPECIFICATIONS). INTERPRETATION OF THE INFORMATION AS PRESENTED SHOULD BE BASED ON THE ENTIRE SET OF DOCUMENTS.

DRAWING TITLE

REV.#


BUILDING SECTIONS

A-250 PERMIT SET

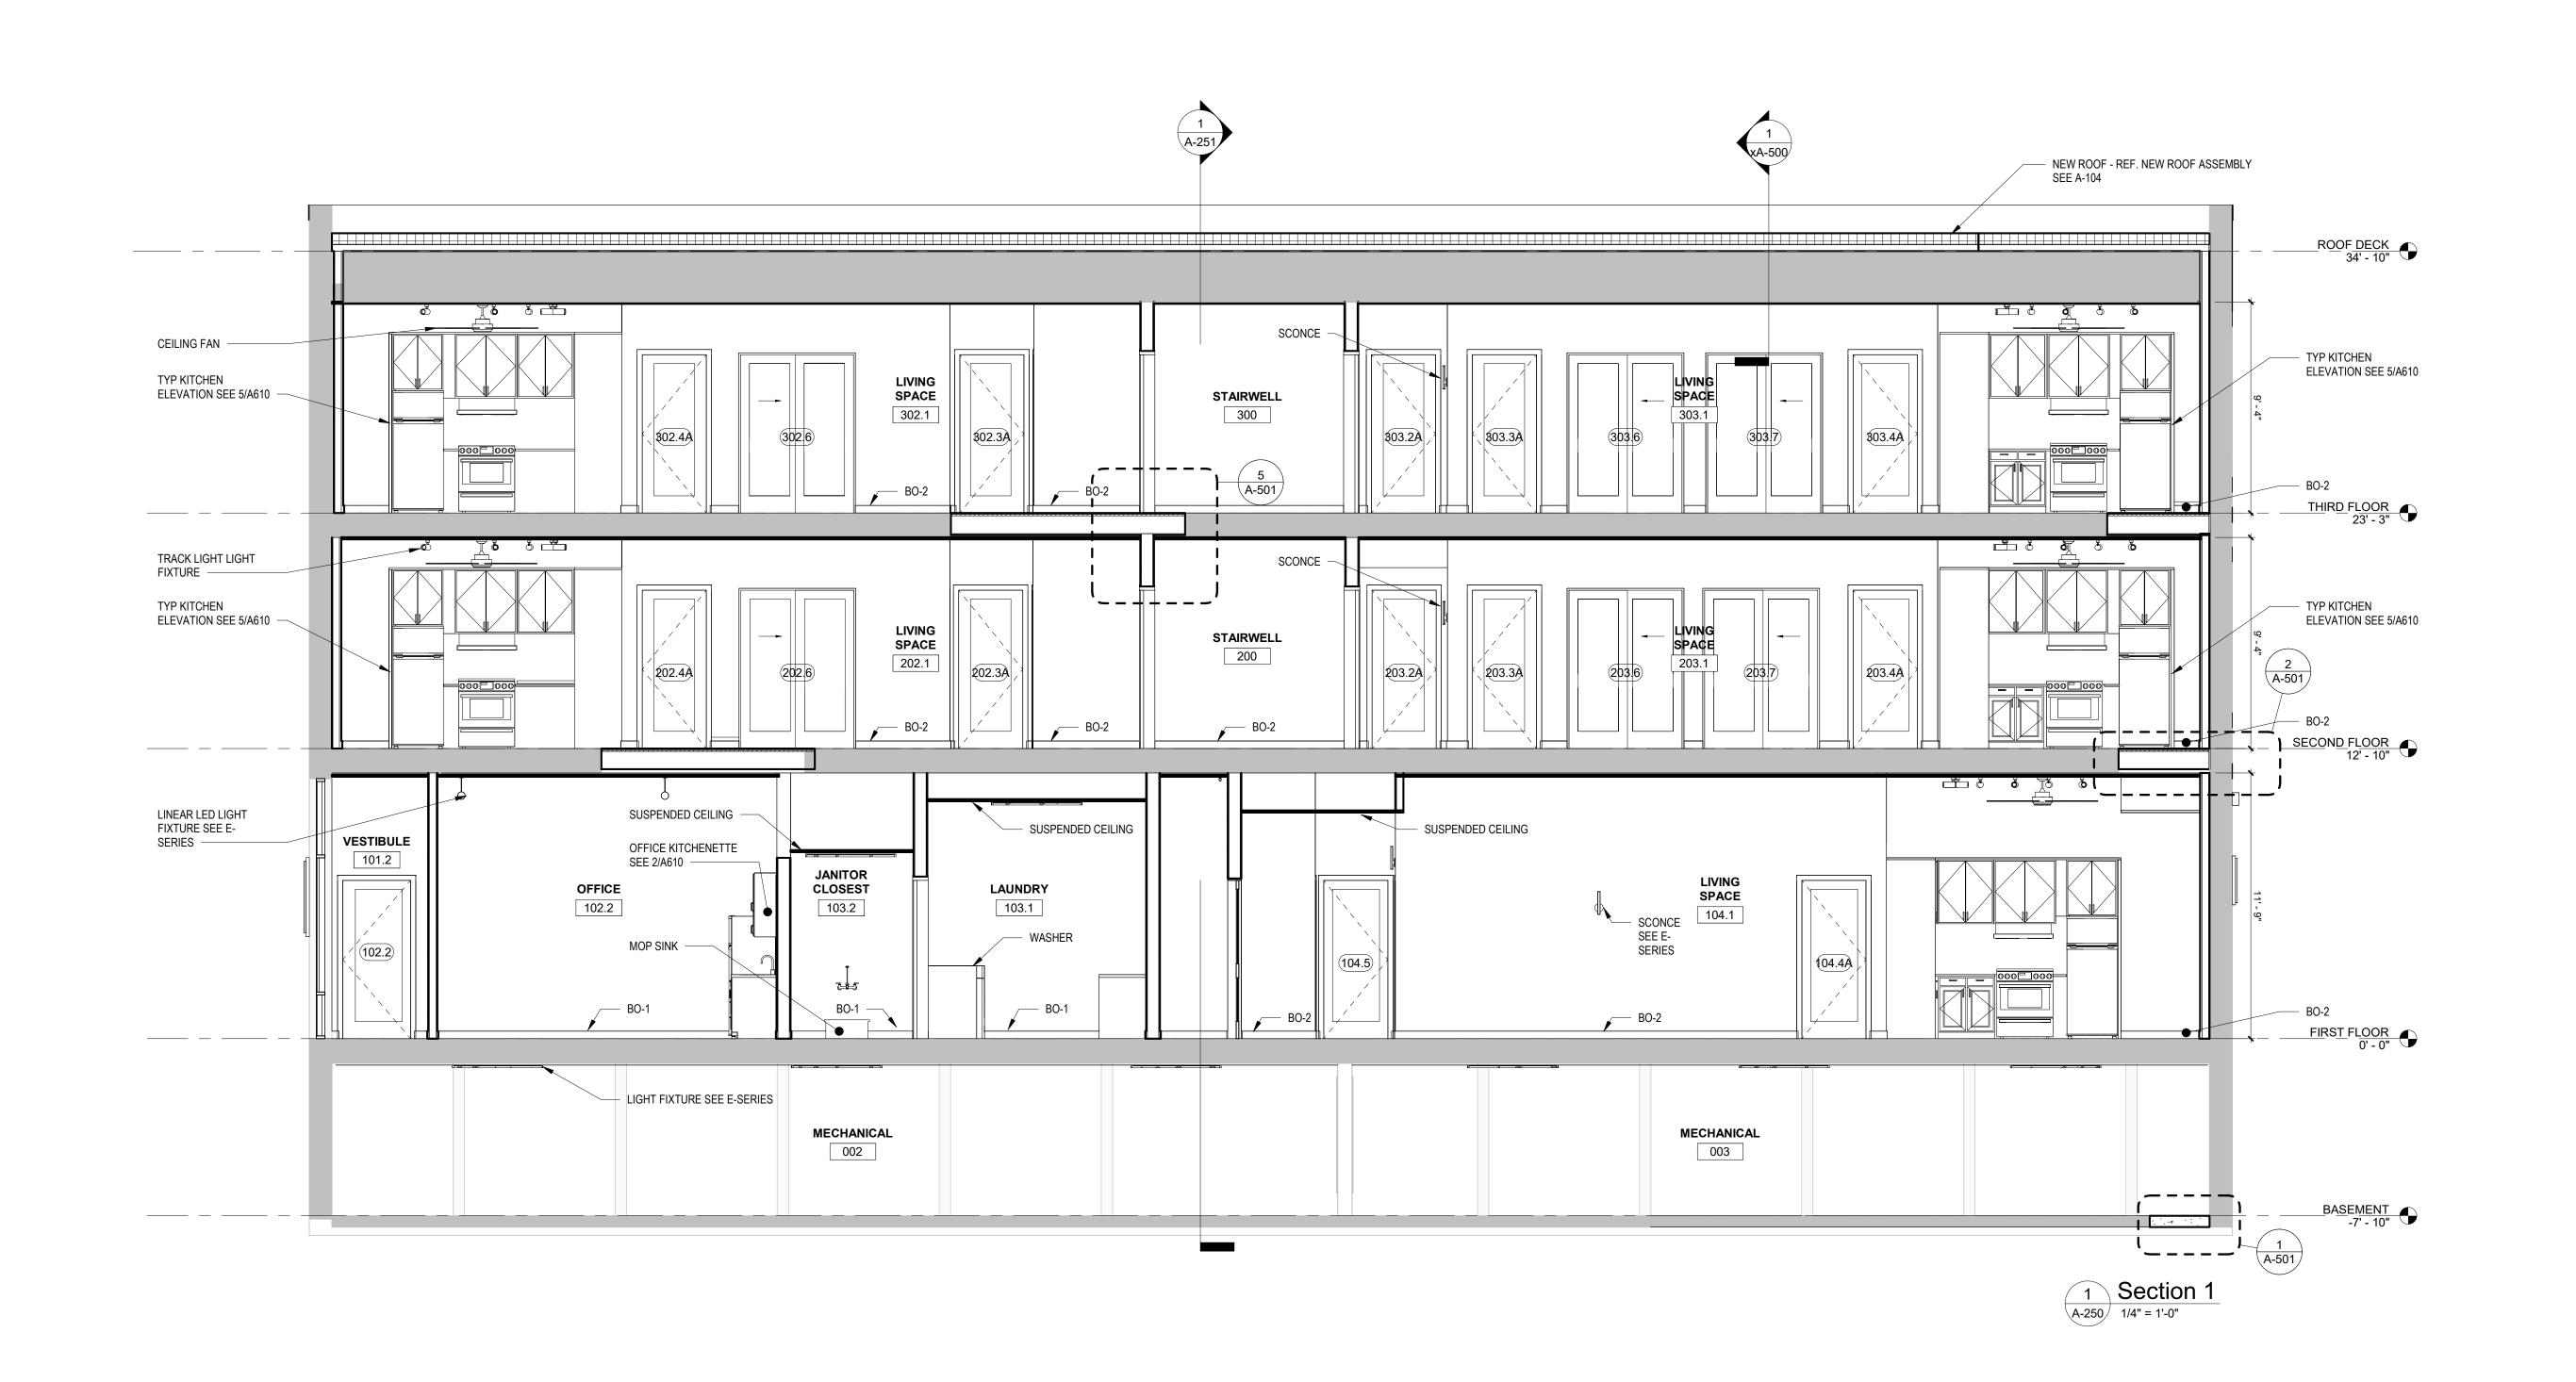





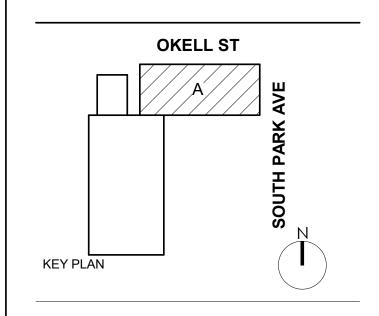

SOUTH PARK MIXED USE

2221 SOUTH PARK AVE BUFFALO, NY 14220

DESCRIPTION

DATE

	JOB NO.	250
	SCALE	1/4" = 1'-0
	ISSUE DATE	08/04/2
-	DRAWN BY	Autho
	CHECKED BY	Checke
_		


THIS IS A SINGLE SHEET OF A COHESIVE SET OF CONSTRUCTION DOCUMENTS (INCLUDING DRAWINGS AND SPECIFICATIONS). INTERPRETATION OF THE INFORMATION AS PRESENTED SHOULD BE BASED ON THE ENTIRE SET OF DOCUMENTS.


DRAWING TITLE

REV.#


BUILDING SECTION


A-251

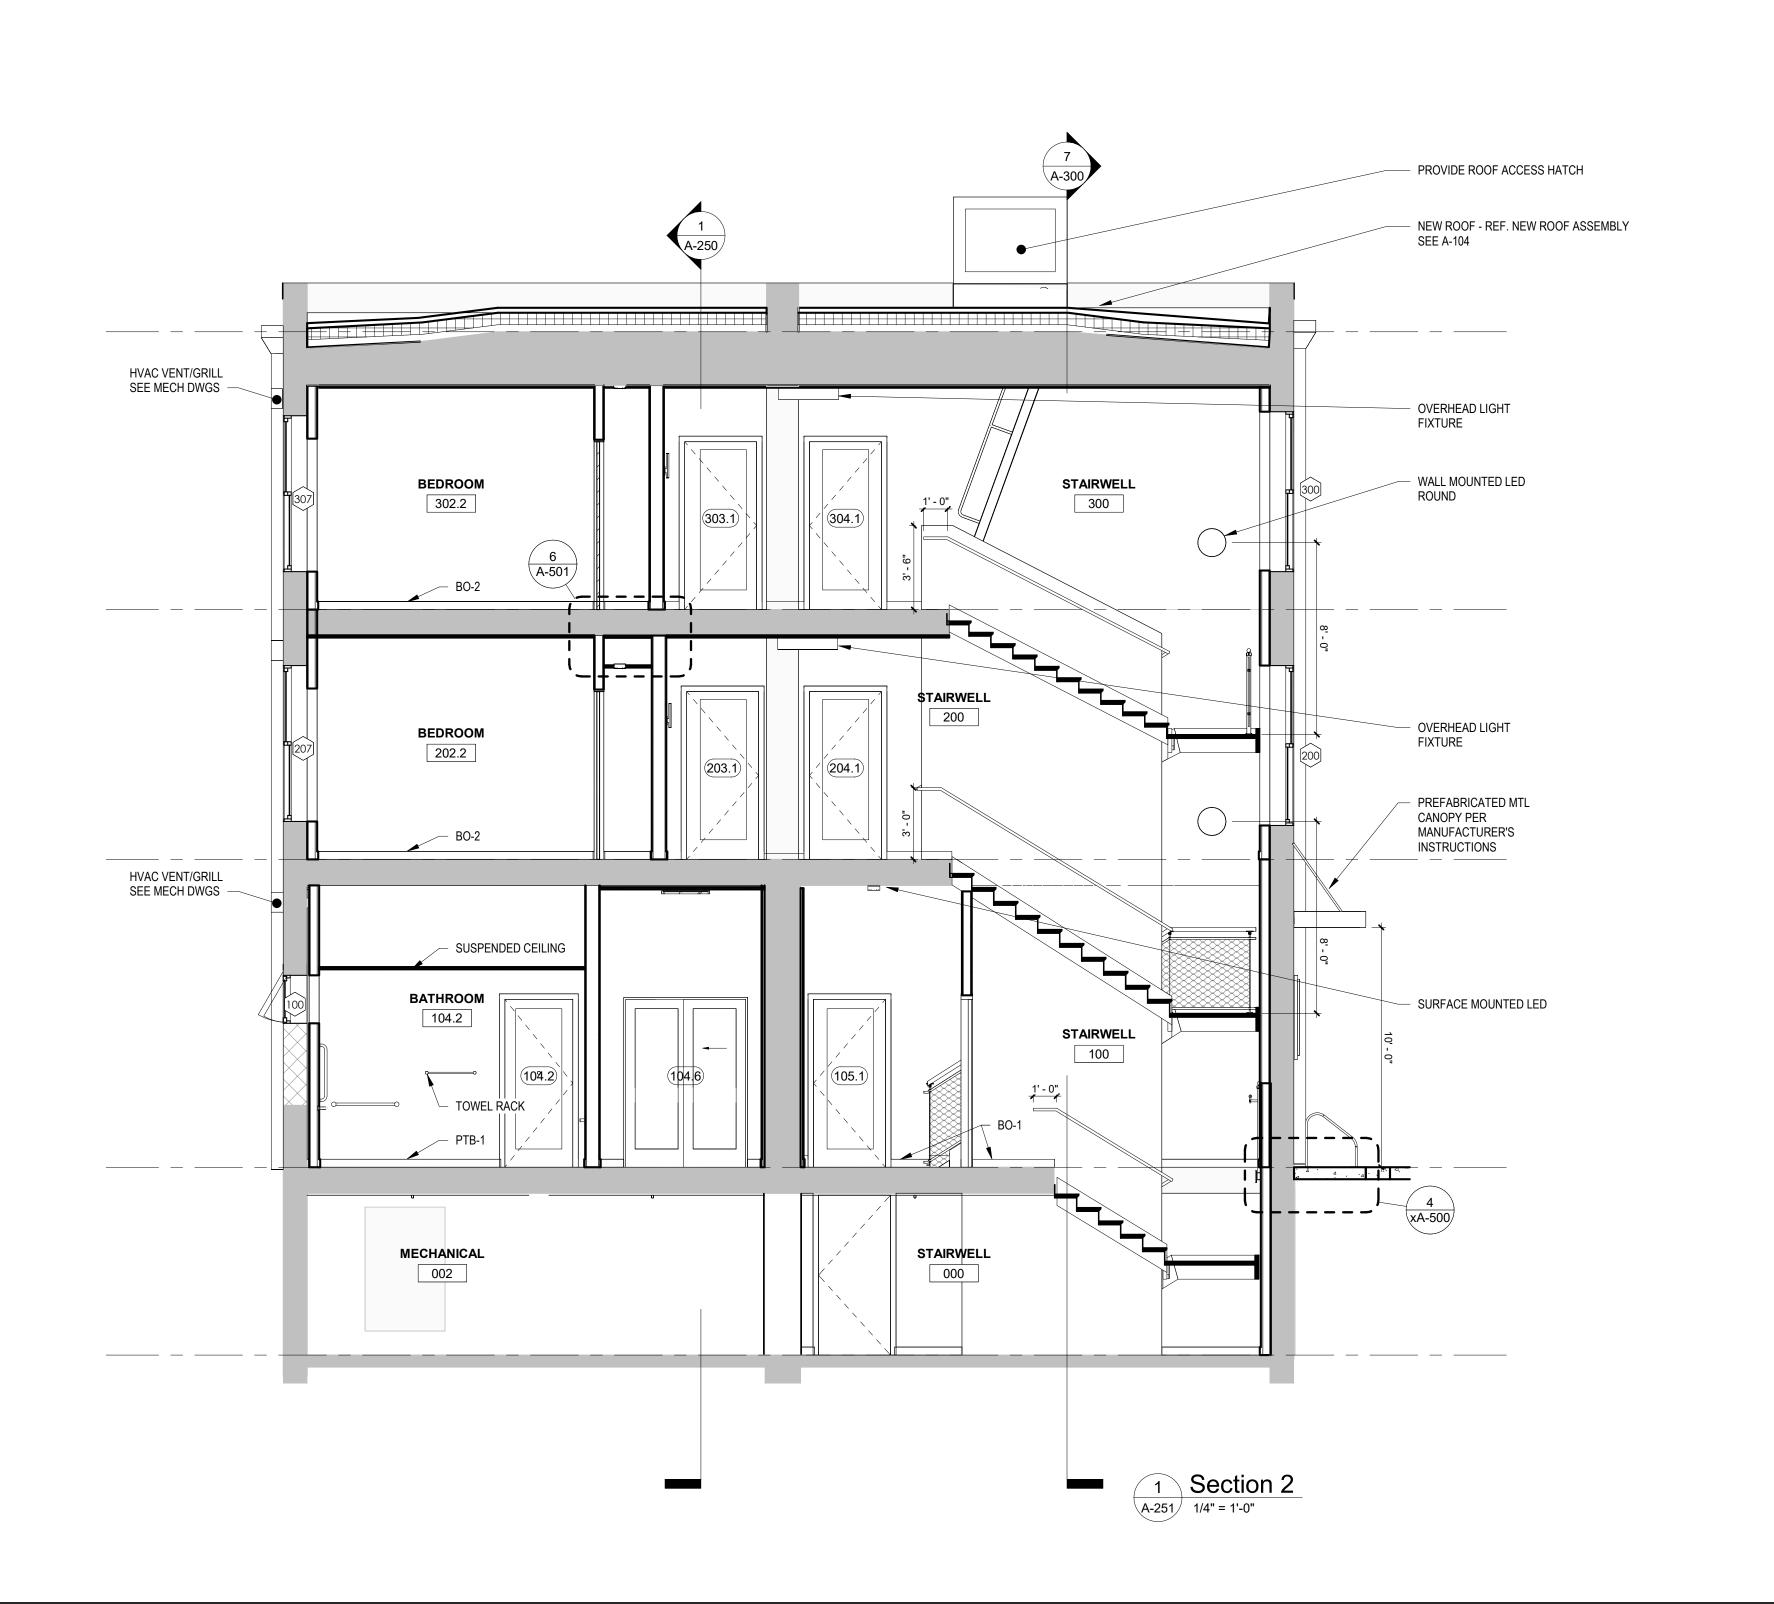

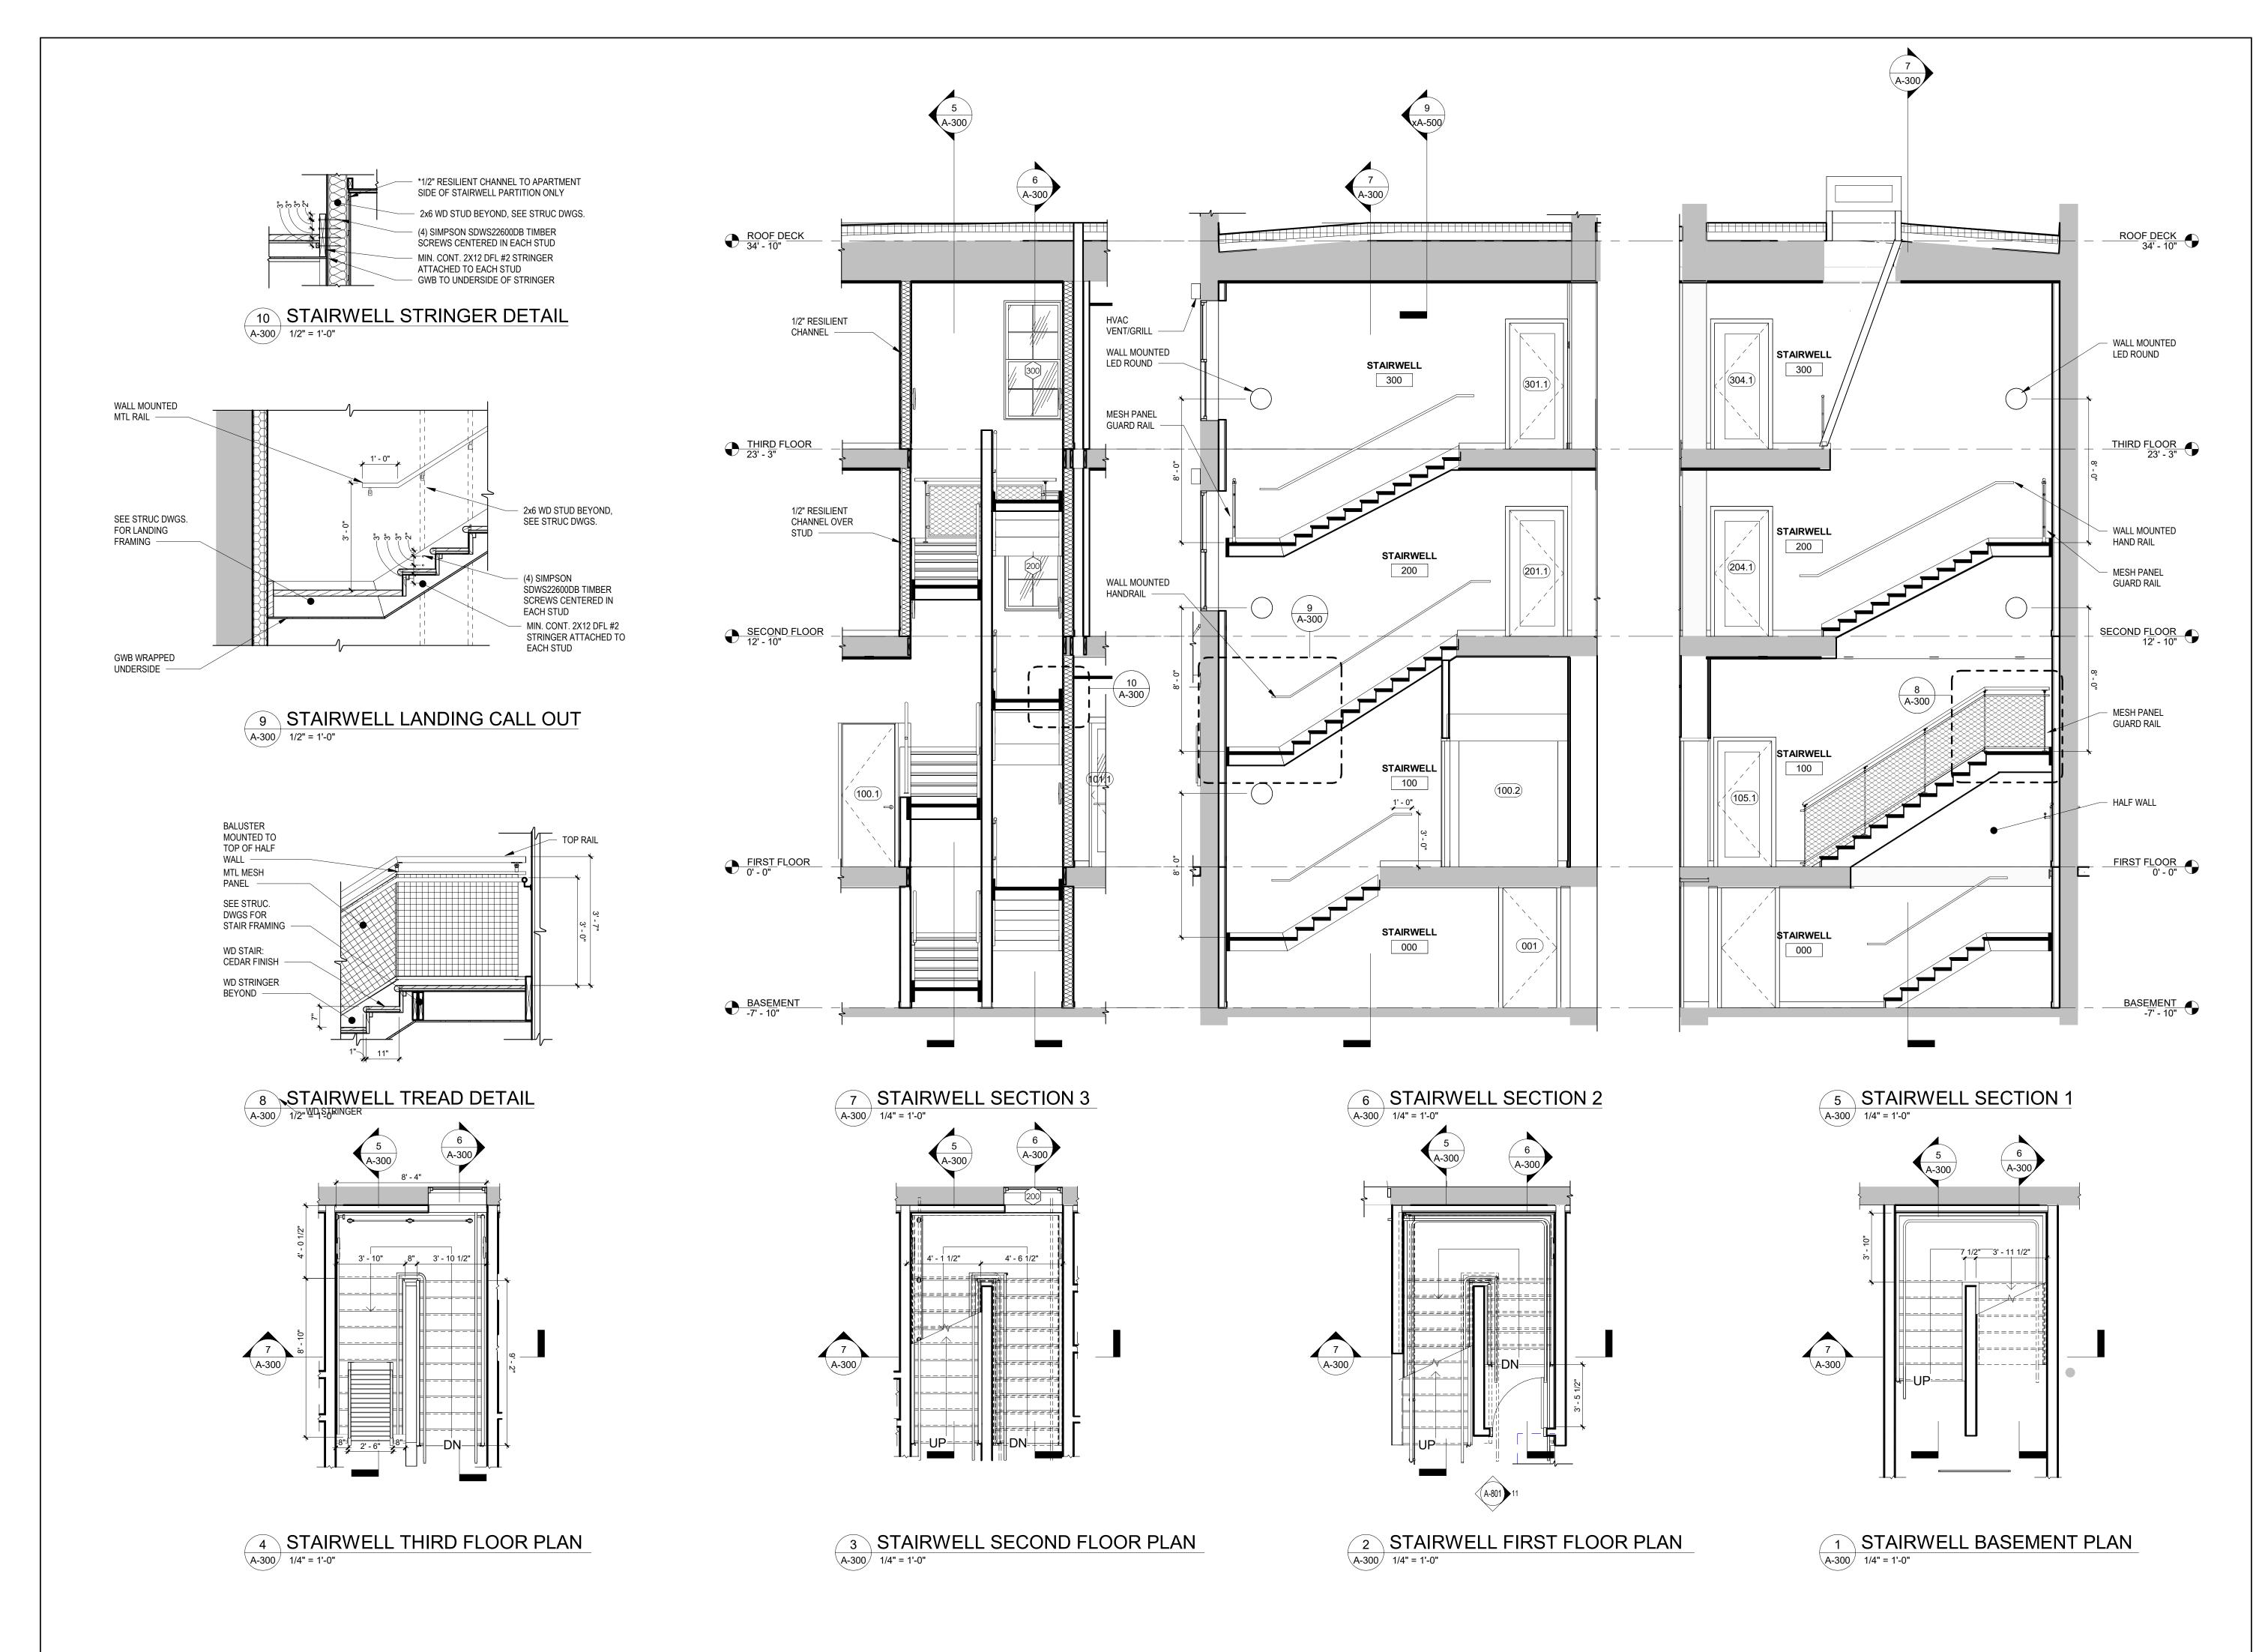



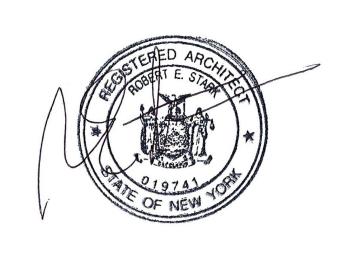

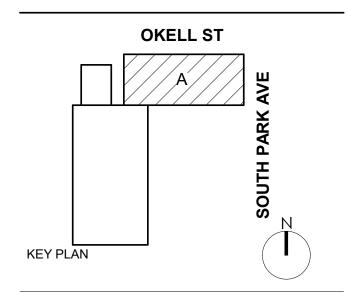

SOUTH PARK MIXED USE

2221 SOUTH PARK AVE BUFFALO, NY 14220

REV.#	DESCRIPTION	DATE

JOB NO.	2508
SCALE	As indicated
ISSUE DATE	08/04/25
DRAWN BY	Author
CHECKED BY	Checker
THIS IS A SINGLE SHEET OF A COHESIVE SET OF CONSTRUCTION DOCUMENTS	


(INCLUDING DRAWINGS AND SPECIFICATIONS).
INTERPRETATION OF THE INFORMATION
AS PRESENTED SHOULD BE BASED ON
THE ENTIRE SET OF DOCUMENTS.

DRAWING TITLE

VERTICAL CIRCULATION

A-300

CHECK WITH EBS AND ELECTRICIAN - CAN WE REMOVE BASEMENT LIGHTING?

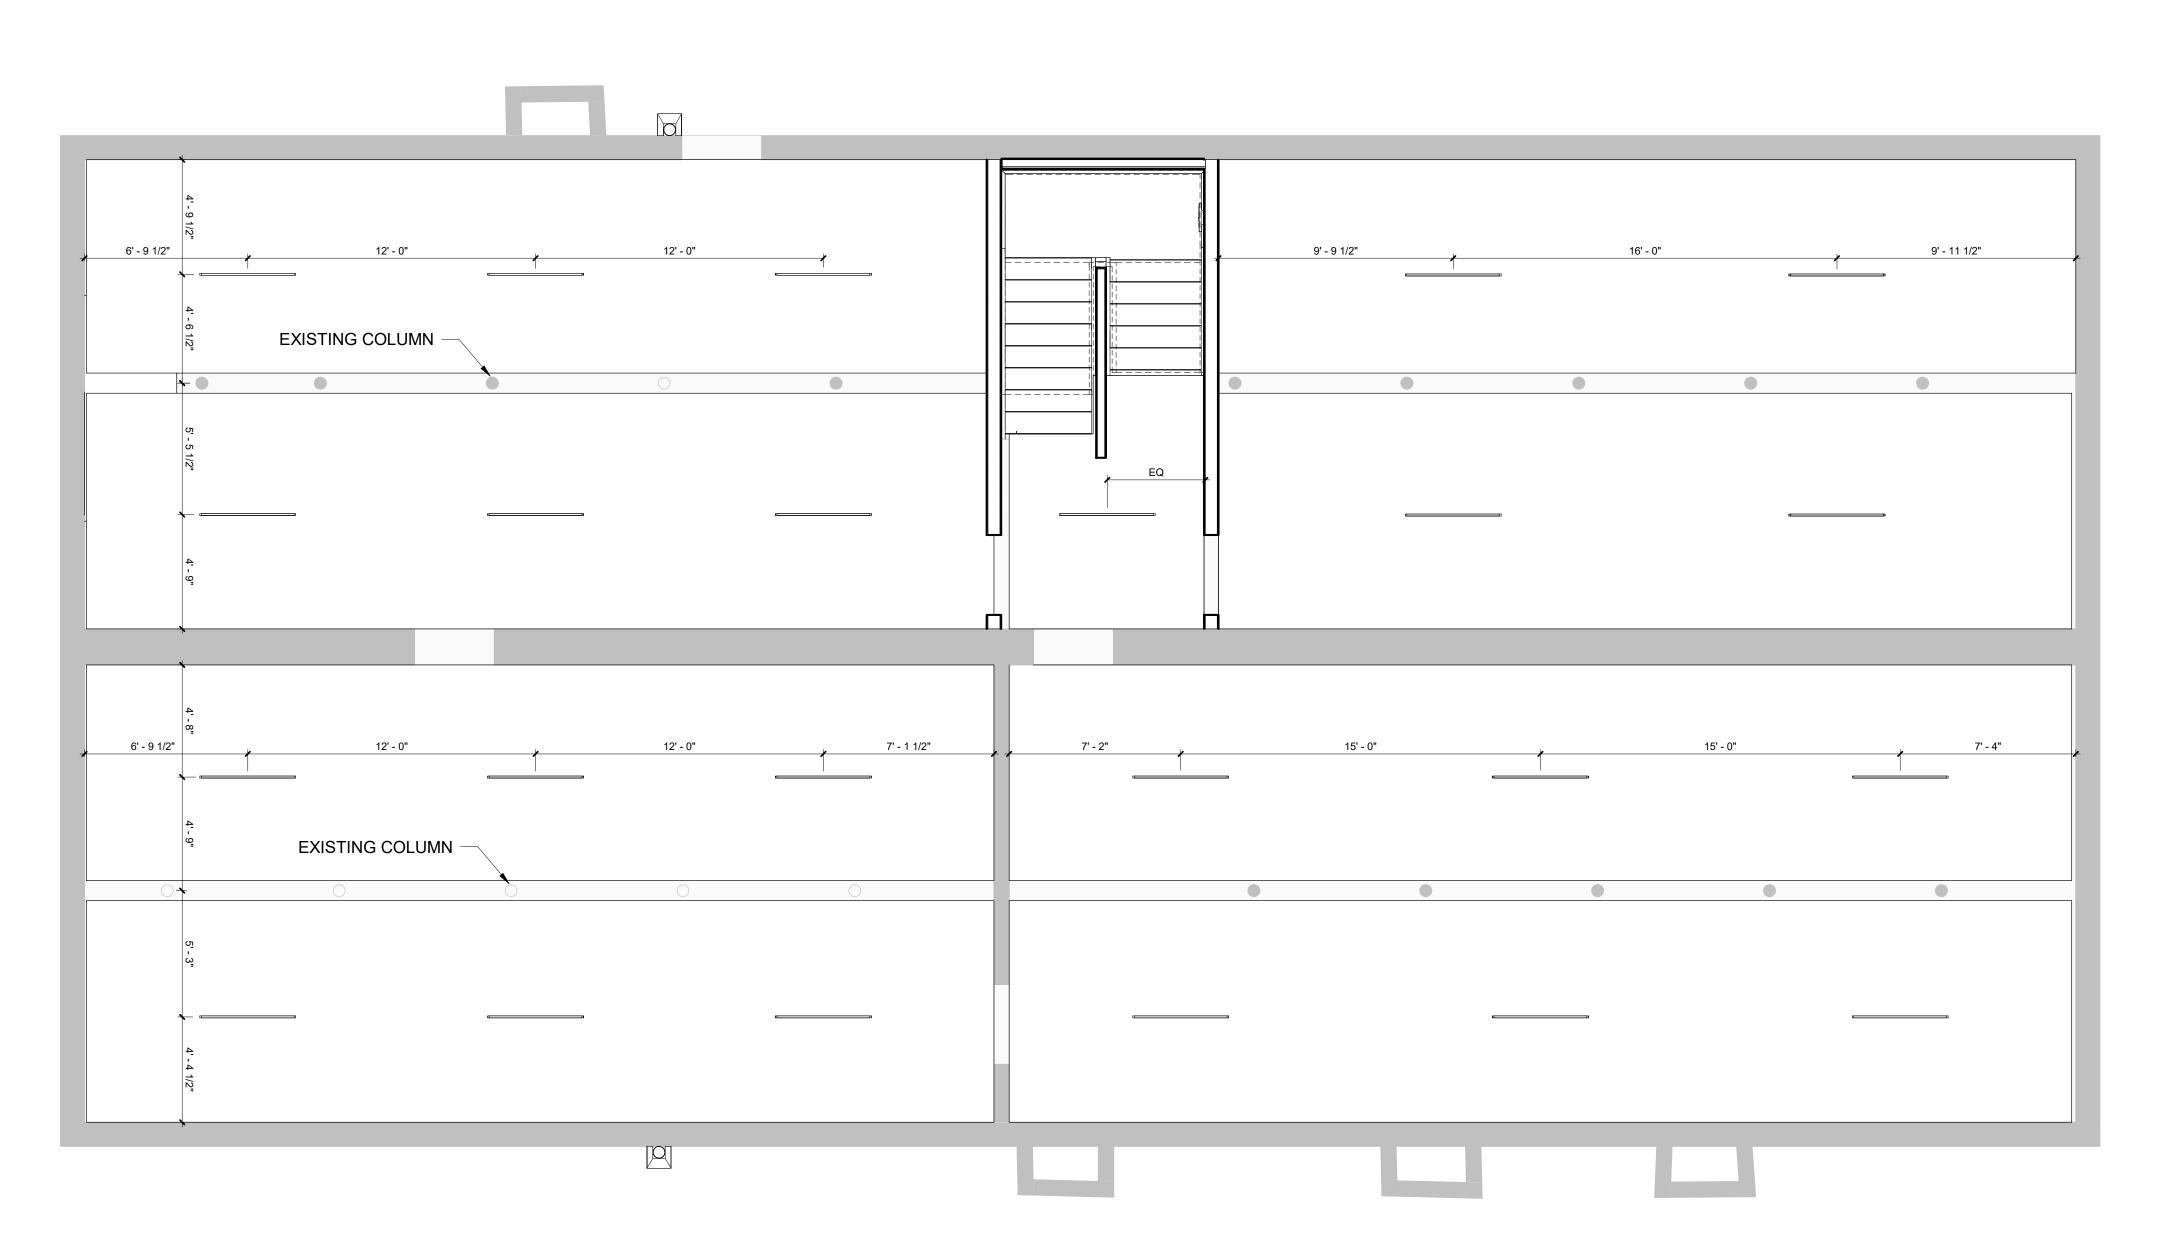


1 BASEMENT RCP A-400 1/4" = 1'-0"


GENERAL RCP NOTES

- REFER TO SHEET T001 FOR WALL TYPES, MATERIAL LEGEND, SYMBOL LEGEND
- AND ABBREVIATIONS USED.
- WITHIN ACP CEILINGS SHALL BE CENTERED IN CEILING TILES. ALL ACP CEILING GRID SHALL BE CENTERED WITHIN SPACES & LAYED OUT TO
- IN AN EFFORT TO ENSURE THAT CEILING HEIGHTS INDICATED ON THESE COORDINATE W/OTHER TRADES ON MOUNTING HEIGHTS OF ALL MEP ITEMS LOCATED ABOVE ACP CEILINGS PRIOR TO INSTALLATION OF ANY ITEMS. ANY WORK INSTALLED THAT WOULD PREVENT THE INSTALLATION OF THE CEILING AT THE HEIGHT INDICATED ON THESE DOCUMENTS SHALL BE REMOVED & REINSTALLED AS REQUIRED AT THE EXPENSE OF THE SUB-CONTRACTOR
- REFER TO U.L. FIRE RESISTANCE DIRECTORY FOR DETAILS ON FIRE RATED WALLS, COLUMNS ENCLOSURES, FLOOR/CEILING ASSEMBLIES & CEILING/ROOF
- ALL STRUCTURE., MECH., ELEC., PLUMB. AND FIRE PROTECTION ELEMENTS SHOWN ARE FOR REFERENCE ONLY. CONTRACTOR SHALL REFER TO OTHER SECTIONS OF THE DOCUMENTS AS APPOPRIATE FOR OTHER TRADES. WHERE DISCREPANCIES EXIST BETWEEN ARCH. DRAWINGS AND OTHER TRADES CONTRACTOR SHALL NOTIFY CM OR GC & ARCHITECT PRIOR TO PERFORMING ANY WORK RELATED TO SAID DISCREPANCY.
- PREMIUM FINISHES/COLORS.
- SPRINKLER HEADS LOCATED IN GWB CEILINGS TO BE CONCEALED TYPE
- SPRINKLER HEADS TO BE LOCATED PER FIRE PROTECTION DWG'S UNLESS

RCP'S MATERIALS LEGEND

ALL MATERIALS NOT NECESSARILY USED

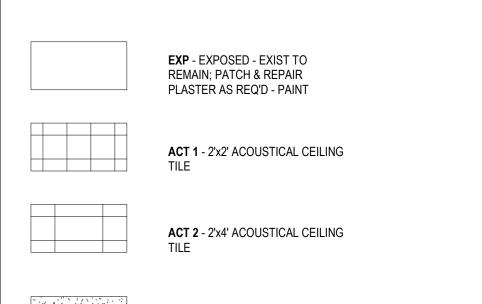

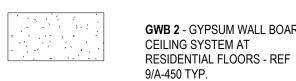

GWB 2 - GYPSUM WALL BOARD CEILING SYSTEM AT

GWB 1 - SUSPENDED GYPSUM WALL BOARD CEILING SYSTEM -



PENDANT MOUNTED CEILING FAN -ARCH./INTERIOR DESIGNER TO

DETERMINE MOUNTING HEIGHT IN

KITCHEN ISLAND PENDANT LIGHT FIXT. - ARCH./INTERIOR DESIGNER TO DETERMINE MOUNTING HEIGHT

TRACK LIGHTING - ARCH./INTERIOR DESIGNER TO LOCATE HEADS IN FIELD - REF. ELEC DWG'S

SURFACE MOUNTED LIGHT FIXT.

WALL MOUNTED AT BATHROOM

WALL MOUNTED SCONCE

22" LED STRIP LIGHT

0 0

DIRECT/INDIRECT LIGHT

EXTERIOR WALL MOUNTED SCONCE

LOBBY/VESTIBULE CEILING LIGHT

STAIRWELL WALL MOUNTED ROUND

SPRINKLER HEAD - REF. FP DWG'S

SPRINKLER HEAD - REF. FP DWG'S

DIFFUSER AT ACT - REF. MECH

DIFFUSER AT GWB. - REF. MECH

SECURITY CAMERA

EMERGENCY SIGNAGE

2221 SOUTH PARK AVE BUFFALO, NY 14220

JOB NO.	2508
SCALE	As indicated
ISSUE DATE	08/04/25
DRAWN BY	XXX
CHECKED BY	XXX


THIS IS A SINGLE SHEET OF A COHESIVE SET OF CONSTRUCTION DOCUMENTS
(INCLUDING DRAWINGS AND SPECIFICATIONS).
INTERPRETATION OF THE INFORMATION
AS PRESENTED SHOULD BE BASED ON
THE ENTIRE SET OF DOCUMENTS.

DRAWING TITLE

BASEMENT REFLECTED **CEILING PLAN**


A-400

PERMIT SET

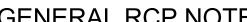

- ALL LIGHT FIXTURES, SPRINKLER HEADS, GRILLES, DIFFUSERS, ETC. LOCATED
- PREVENT THE CUTTING OF TILES TO ANY DIMENSION LESS THAN 4" (UNLESS OTHERWISE INDICATED). DOCUMENTS ARE MAINTAINED, ALL SUB-CONTRACTORS ARE REQUIRED TO
- RESPOSIBLE FOR INSTALLING SAID WORK.
- ASSEMBLIES.
- PROVIDE DRAFTSTOPPING AT THE TOP OF ALL CONCEALED WALL CAVITIES. DRAFTSTOPPING SHALL BE OF AN BCNYS APPROVED MATERIAL AND SHALL PREVENT THE PASSAGE OF SMOKE FROM THE WALL CAVITY INTO ANY ADJACENT CEILING/FLOOR OR CEILING/ROOF CAVITIES.
- COORD. MECH COVERS, GRILLES, ETC. WITH MECH. DWG'S. COLORS TO BE SELECTED BY ARCHITECT FROM MANUFACTURES FULL RANGE, INCLUDING
- REFER TO RM FINISH SCHEDULES FOR ALL INTERIOR FINISHES.
- OTHERWISE NOTED. 12. ALL KEY PLANS ARE FOR REFERENCE ONLY.



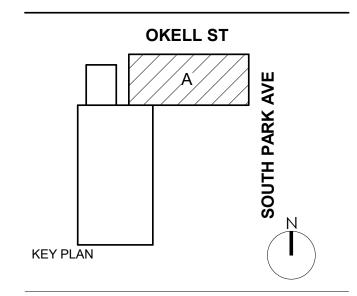


ARCHITECTS

BUFFALO | ROCHESTER

www.cjsarchitects.com

DOFI PROPERTIES

EV. #	DESCRIPTION	DATE

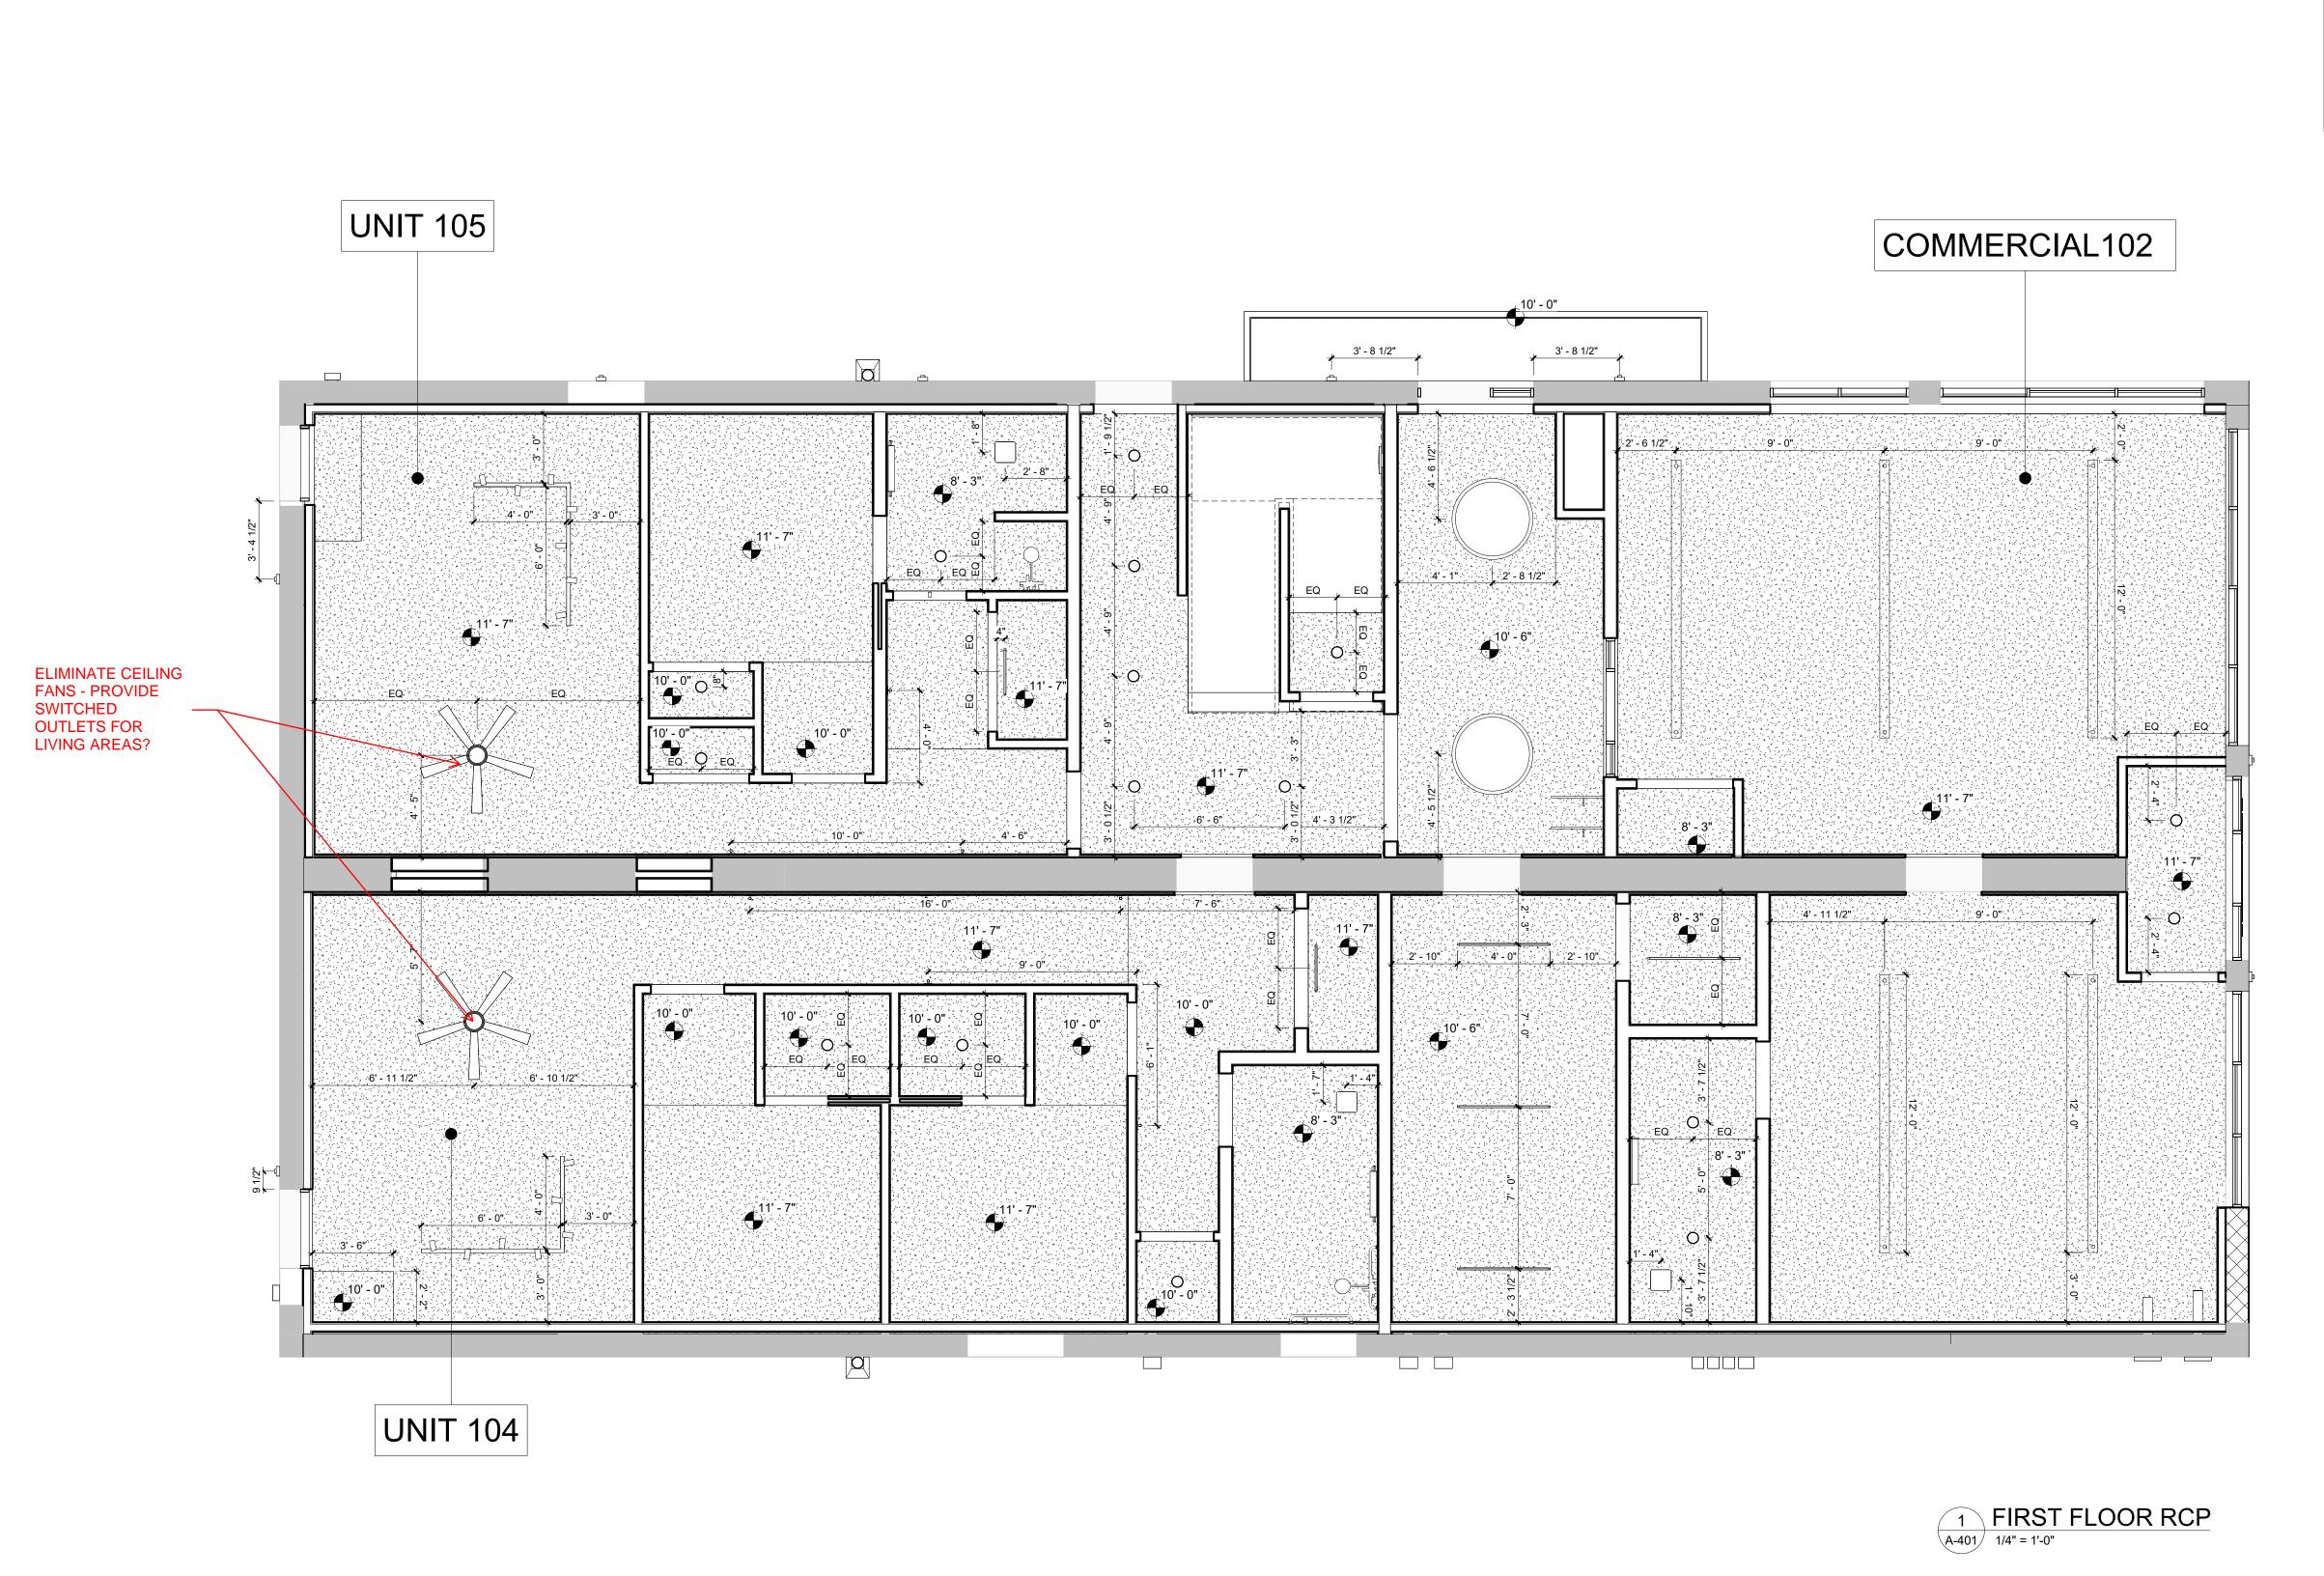


GENERAL RCP NOTES


OTHERWISE INDICATED).


- REFER TO SHEET T001 FOR WALL TYPES, MATERIAL LEGEND, SYMBOL LEGEND
- AND ABBREVIATIONS USED. ALL LIGHT FIXTURES, SPRINKLER HEADS, GRILLES, DIFFUSERS, ETC. LOCATED
- WITHIN ACP CEILINGS SHALL BE CENTERED IN CEILING TILES. ALL ACP CEILING GRID SHALL BE CENTERED WITHIN SPACES & LAYED OUT TO PREVENT THE CUTTING OF TILES TO ANY DIMENSION LESS THAN 4" (UNLESS
- IN AN EFFORT TO ENSURE THAT CEILING HEIGHTS INDICATED ON THESE DOCUMENTS ARE MAINTAINED, ALL SUB-CONTRACTORS ARE REQUIRED TO COORDINATE W/OTHER TRADES ON MOUNTING HEIGHTS OF ALL MEP ITEMS LOCATED ABOVE ACP CEILINGS PRIOR TO INSTALLATION OF ANY ITEMS. ANY WORK INSTALLED THAT WOULD PREVENT THE INSTALLATION OF THE CEILING AT THE HEIGHT INDICATED ON THESE DOCUMENTS SHALL BE REMOVED & REINSTALLED AS REQUIRED AT THE EXPENSE OF THE SUB-CONTRACTOR
- RESPOSIBLE FOR INSTALLING SAID WORK. REFER TO U.L. FIRE RESISTANCE DIRECTORY FOR DETAILS ON FIRE RATED WALLS, COLUMNS ENCLOSURES, FLOOR/CEILING ASSEMBLIES & CEILING/ROOF
- PROVIDE DRAFTSTOPPING AT THE TOP OF ALL CONCEALED WALL CAVITIES. DRAFTSTOPPING SHALL BE OF AN BCNYS APPROVED MATERIAL AND SHALL PREVENT THE PASSAGE OF SMOKE FROM THE WALL CAVITY INTO ANY ADJACENT CEILING/FLOOR OR CEILING/ROOF CAVITIES.
- ALL STRUCTURE., MECH., ELEC., PLUMB. AND FIRE PROTECTION ELEMENTS SHOWN ARE FOR REFERENCE <u>ONLY</u>. CONTRACTOR SHALL REFER TO OTHER SECTIONS OF THE DOCUMENTS AS APPOPRIATE FOR OTHER TRADES. WHERE DISCREPANCIES EXIST BETWEEN ARCH. DRAWINGS AND OTHER TRADES CONTRACTOR SHALL NOTIFY CM OR GC & ARCHITECT PRIOR TO PERFORMING ANY WORK RELATED TO SAID DISCREPANCY.
- COORD. MECH COVERS, GRILLES, ETC. WITH MECH. DWG'S. COLORS TO BE SELECTED BY ARCHITECT FROM MANUFACTURES FULL RANGE, INCLUDING
- PREMIUM FINISHES/COLORS. SPRINKLER HEADS LOCATED IN GWB CEILINGS TO BE CONCEALED TYPE
- REFER TO RM FINISH SCHEDULES FOR ALL INTERIOR FINISHES. SPRINKLER HEADS TO BE LOCATED PER FIRE PROTECTION DWG'S UNLESS
- OTHERWISE NOTED. 12. ALL KEY PLANS ARE FOR REFERENCE ONLY.

RCP'S MATERIALS LEGEND

ALL MATERIALS NOT NECESSARILY USED

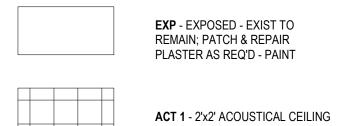

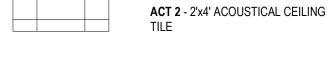

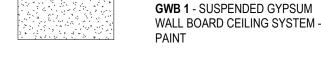

GWB 2 - GYPSUM WALL BOARD CEILING SYSTEM AT RESIDENTIAL FLOORS - REF 9/A-450 TYP.

RCP'S SYMBOLS LEGEND ALL SYMBOLS NOT NECESSARILY USED; SYMBOLS NOT TO

PENDANT MOUNTED CEILING FAN -ARCH./INTERIOR DESIGNER TO DETERMINE MOUNTING HEIGHT IN

KITCHEN ISLAND PENDANT LIGHT FIXT. - ARCH./INTERIOR DESIGNER TO DETERMINE MOUNTING HEIGHT

WALL MOUNTED AT BATHROOM

TRACK LIGHTING - ARCH./INTERIOR DESIGNER TO LOCATE HEADS IN FIELD - REF. ELEC DWG'S SURFACE MOUNTED LIGHT FIXT.

EXTERIOR WALL MOUNTED SCONCE WALL MOUNTED SCONCE

LOBBY/VESTIBULE CEILING LIGHT

STAIRWELL WALL MOUNTED ROUND

22" LED STRIP LIGHT DIRECT/INDIRECT LIGHT 0 0

SPRINKLER HEAD - REF. FP DWG'S

SPRINKLER HEAD - REF. FP DWG'S


DIFFUSER AT GWB. - REF. MECH


DIFFUSER AT ACT - REF. MECH

SECURITY CAMERA

EMERGENCY SIGNAGE



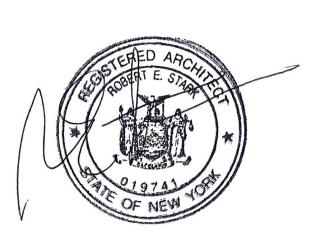

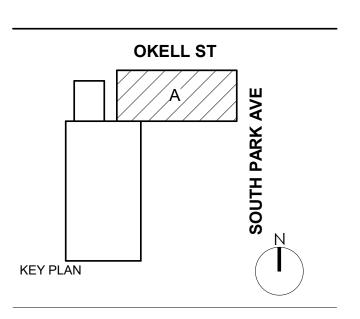

DOFI PROPERTIES

SOUTH PARK MIXED USE

2221 SOUTH PARK AVE BUFFALO, NY 14220

REV.# DESCRIPTION DATE


JOB NO.	2508	
SCALE	As indicated	
ISSUE DATE	08/04/2	
DRAWN BY	Ga	
CHECKED BY	JMC	

THIS IS A SINGLE SHEET OF A COHESIVE SET OF CONSTRUCTION DOCUMENTS (INCLUDING DRAWINGS AND SPECIFICATIONS). INTERPRETATION OF THE INFORMATION AS PRESENTED SHOULD BE BASED ON THE ENTIRE SET OF DOCUMENTS.

DRAWING TITLE

GROUND FLOOR REFLECTED **CEILING PLAN**

A-401

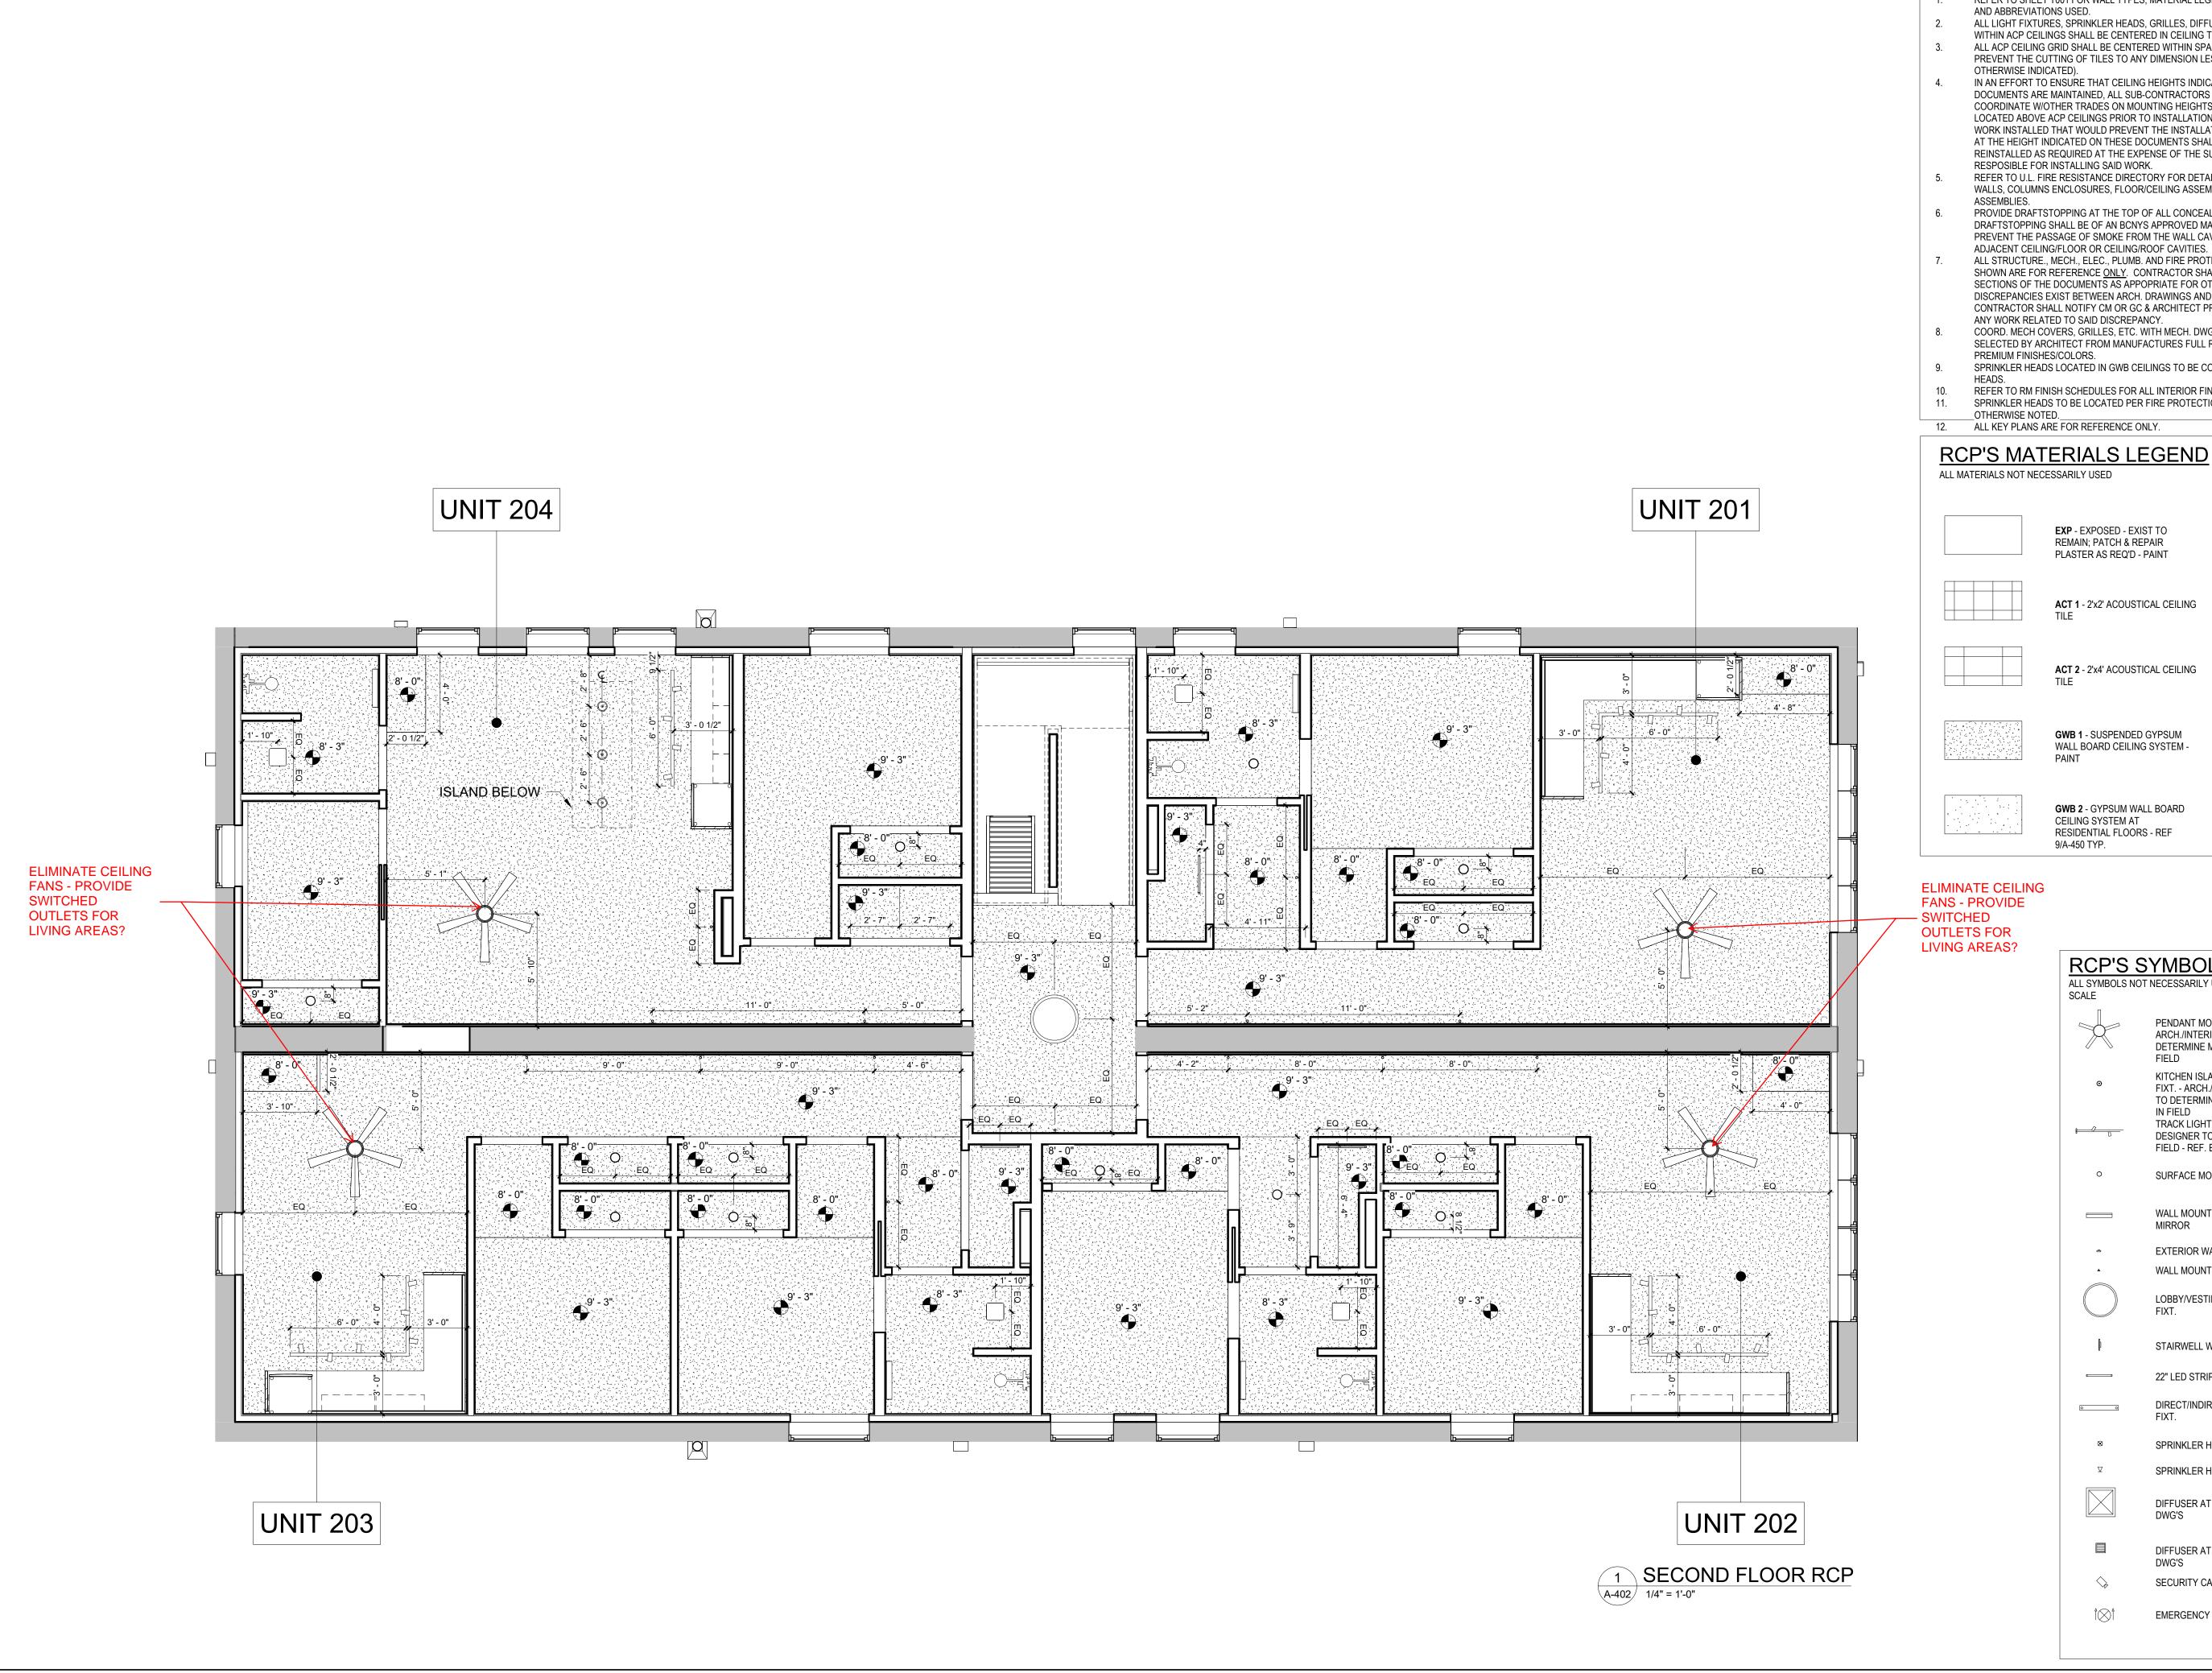

GENERAL RCP NOTES


- REFER TO SHEET T001 FOR WALL TYPES, MATERIAL LEGEND, SYMBOL LEGEND
- ALL LIGHT FIXTURES, SPRINKLER HEADS, GRILLES, DIFFUSERS, ETC. LOCATED
- WITHIN ACP CEILINGS SHALL BE CENTERED IN CEILING TILES. ALL ACP CEILING GRID SHALL BE CENTERED WITHIN SPACES & LAYED OUT TO PREVENT THE CUTTING OF TILES TO ANY DIMENSION LESS THAN 4" (UNLESS
- IN AN EFFORT TO ENSURE THAT CEILING HEIGHTS INDICATED ON THESE DOCUMENTS ARE MAINTAINED, ALL SUB-CONTRACTORS ARE REQUIRED TO COORDINATE W/OTHER TRADES ON MOUNTING HEIGHTS OF ALL MEP ITEMS LOCATED ABOVE ACP CEILINGS PRIOR TO INSTALLATION OF ANY ITEMS. ANY WORK INSTALLED THAT WOULD PREVENT THE INSTALLATION OF THE CEILING AT THE HEIGHT INDICATED ON THESE DOCUMENTS SHALL BE REMOVED & REINSTALLED AS REQUIRED AT THE EXPENSE OF THE SUB-CONTRACTOR
- REFER TO U.L. FIRE RESISTANCE DIRECTORY FOR DETAILS ON FIRE RATED WALLS, COLUMNS ENCLOSURES, FLOOR/CEILING ASSEMBLIES & CEILING/ROOF
- PROVIDE DRAFTSTOPPING AT THE TOP OF ALL CONCEALED WALL CAVITIES. DRAFTSTOPPING SHALL BE OF AN BCNYS APPROVED MATERIAL AND SHALL PREVENT THE PASSAGE OF SMOKE FROM THE WALL CAVITY INTO ANY ADJACENT CEILING/FLOOR OR CEILING/ROOF CAVITIES.
- ALL STRUCTURE., MECH., ELEC., PLUMB. AND FIRE PROTECTION ELEMENTS SHOWN ARE FOR REFERENCE <u>ONLY</u>. CONTRACTOR SHALL REFER TO OTHER SECTIONS OF THE DOCUMENTS AS APPOPRIATE FOR OTHER TRADES. WHERE DISCREPANCIES EXIST BETWEEN ARCH. DRAWINGS AND OTHER TRADES CONTRACTOR SHALL NOTIFY CM OR GC & ARCHITECT PRIOR TO PERFORMING ANY WORK RELATED TO SAID DISCREPANCY.
- COORD. MECH COVERS, GRILLES, ETC. WITH MECH. DWG'S. COLORS TO BE SELECTED BY ARCHITECT FROM MANUFACTURES FULL RANGE, INCLUDING
- PREMIUM FINISHES/COLORS. SPRINKLER HEADS LOCATED IN GWB CEILINGS TO BE CONCEALED TYPE
- REFER TO RM FINISH SCHEDULES FOR ALL INTERIOR FINISHES. SPRINKLER HEADS TO BE LOCATED PER FIRE PROTECTION DWG'S UNLESS


12. ALL KEY PLANS ARE FOR REFERENCE ONLY.



REMAIN; PATCH & REPAIR PLASTER AS REQ'D - PAINT



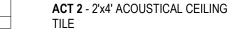

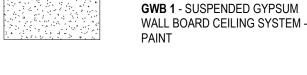

GWB 2 - GYPSUM WALL BOARD CEILING SYSTEM AT RESIDENTIAL FLOORS - REF 9/A-450 TYP.

RCP'S SYMBOLS LEGEND ALL SYMBOLS NOT NECESSARILY USED; SYMBOLS NOT TO

PENDANT MOUNTED CEILING FAN -ARCH./INTERIOR DESIGNER TO DETERMINE MOUNTING HEIGHT IN

KITCHEN ISLAND PENDANT LIGHT FIXT. - ARCH./INTERIOR DESIGNER TO DETERMINE MOUNTING HEIGHT

TRACK LIGHTING - ARCH./INTERIOR DESIGNER TO LOCATE HEADS IN FIELD - REF. ELEC DWG'S

SURFACE MOUNTED LIGHT FIXT.

WALL MOUNTED AT BATHROOM

EXTERIOR WALL MOUNTED SCONCE

WALL MOUNTED SCONCE LOBBY/VESTIBULE CEILING LIGHT

STAIRWELL WALL MOUNTED ROUND

22" LED STRIP LIGHT

0 0

SPRINKLER HEAD - REF. FP DWG'S

DIRECT/INDIRECT LIGHT

SPRINKLER HEAD - REF. FP DWG'S


DIFFUSER AT ACT - REF. MECH


DIFFUSER AT GWB. - REF. MECH SECURITY CAMERA

EMERGENCY SIGNAGE

ARCHITECTS BUFFALO | ROCHESTER

www.cjsarchitects.com

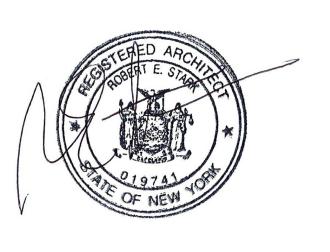

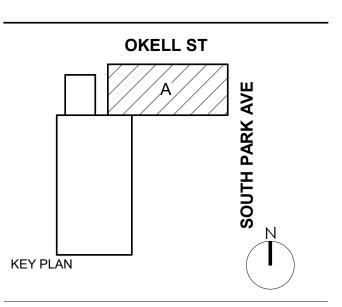

DOFI PROPERTIES

SOUTH PARK MIXED USE

2221 SOUTH PARK AVE BUFFALO, NY 14220

REV.# DESCRIPTION DATE


JOB NO.	2508
SCALE	As indicated
ISSUE DATE	08/04/29
DRAWN BY	Ga
CHECKED BY	JMC

THIS IS A SINGLE SHEET OF A COHESIVE SET OF CONSTRUCTION DOCUMENTS (INCLUDING DRAWINGS AND SPECIFICATIONS). INTERPRETATION OF THE INFORMATION AS PRESENTED SHOULD BE BASED ON THE ENTIRE SET OF DOCUMENTS.

DRAWING TITLE

SECOND FLOOR REFLECTED **CEILING PLAN**


A-402

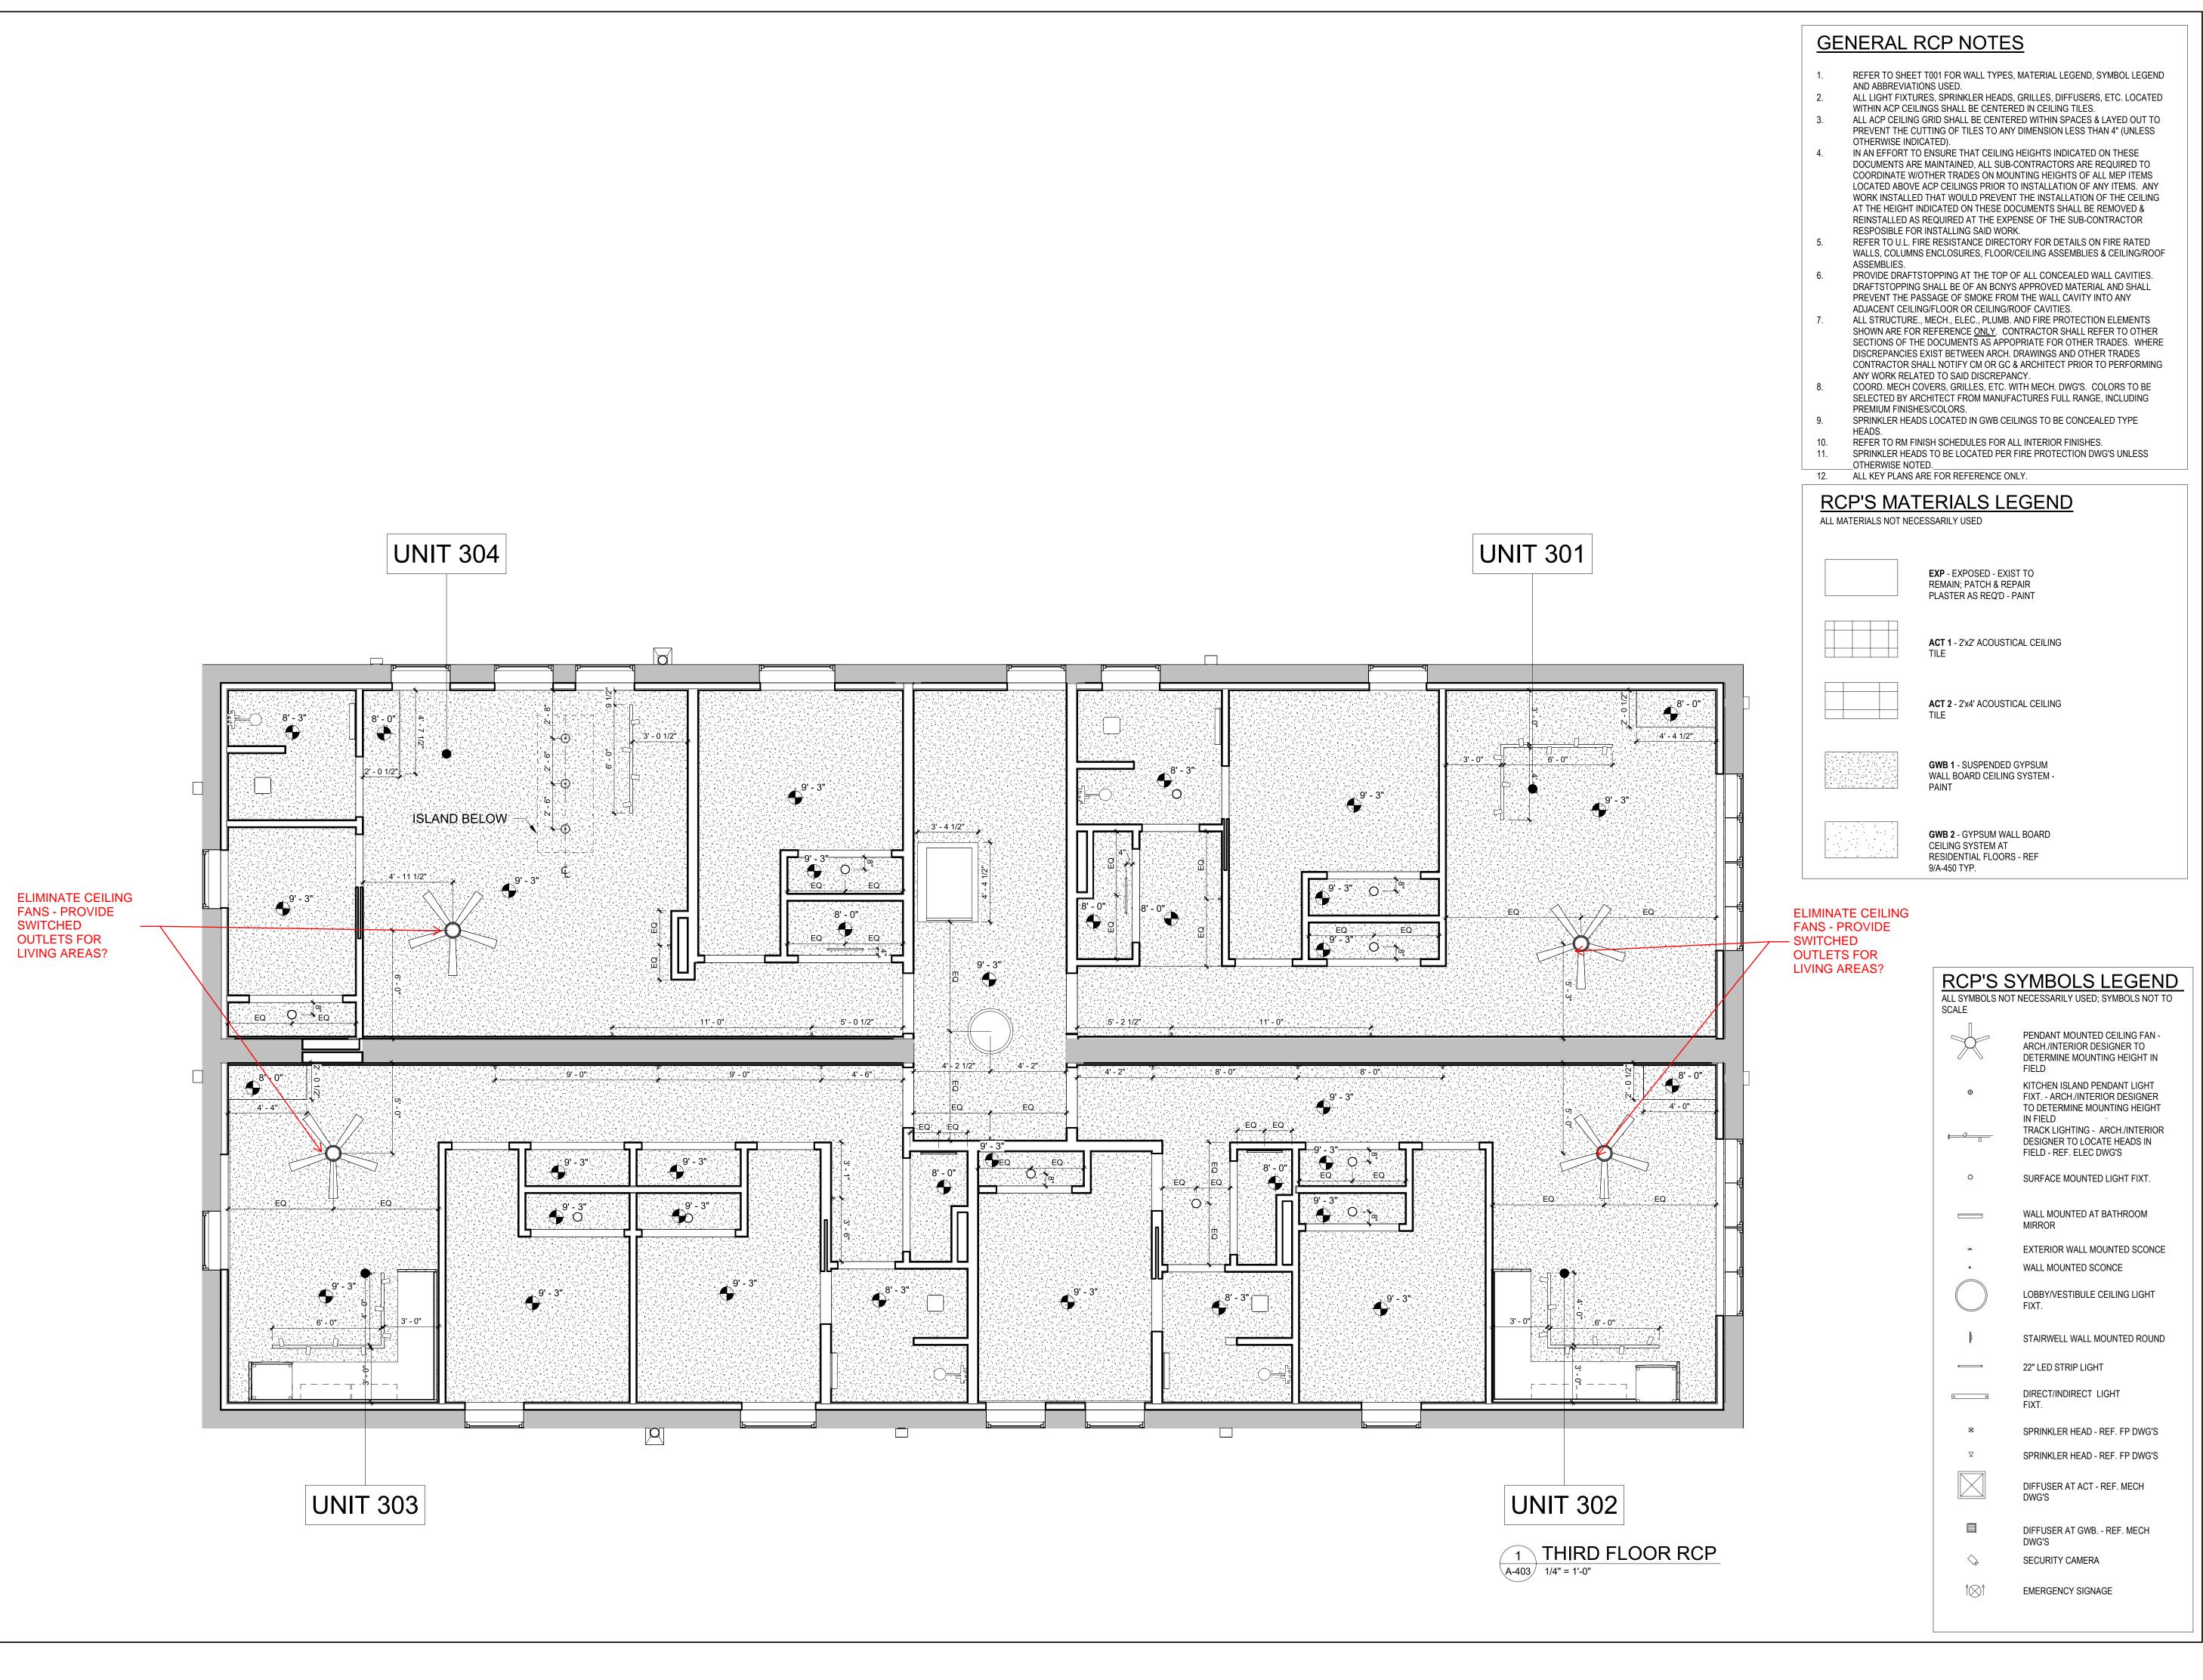



BUFFALO | ROCHESTER www.cjsarchitects.com



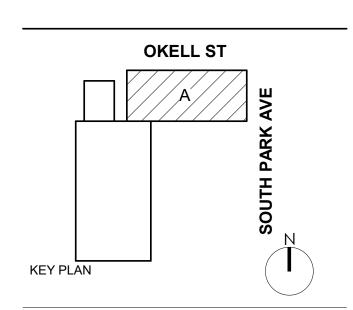

DOFI PROPERTIES

SOUTH PARK MIXED USE

2221 SOUTH PARK AVE BUFFALO, NY 14220

REV. # DESCRIPTION DATE

JOB NO.	2508
SCALE	As indicated
ISSUE DATE	08/04/2
DRAWN BY	Autho
CHECKED BY	Checke


THIS IS A SINGLE SHEET OF A COHESIVE SET OF CONSTRUCTION DOCUMENTS (INCLUDING DRAWINGS AND SPECIFICATIONS). INTERPRETATION OF THE INFORMATION AS PRESENTED SHOULD BE BASED ON THE ENTIRE SET OF DOCUMENTS.


DRAWING TITLE

THRID FLOOR REFLECTED CEILING PLAN

A-403



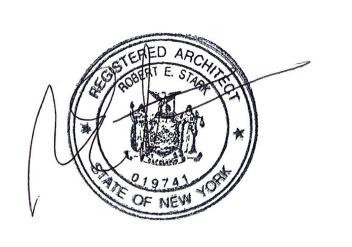

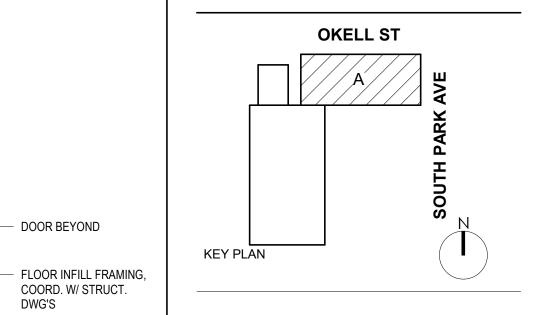

SOUTH PARK MIXED USE

2221 SOUTH PARK AVE BUFFALO, NY 14220

REV.#	DESCRIPTION	DATE

JOB NO.	2508
SCALE	3/4" = 1'-0"
ISSUE DATE	08/04/25
DRAWN BY	Gac
CHECKED BY	JMC
THIS IS A SINGLE SHEET OF A COHESIVE SET OF CONSTRUCTION DOCUMENTS (INCLUDING DRAWINGS AND SPECIFICATION INTERPRETATION OF THE INFORMATION AS PRESENTED SHOULD BE BASED ON	

THE ENTIRE SET OF DOCUMENTS.

DRAWING TITLE

INTERIOR DETAILS


A-501

1/2" RESILIENT CHANNEL ON EXISTING JOISTS - GWB 5 FLOOR INFILL @ CENTRAL STAIR
A-501 3/4" = 1'-0"

CONCRETE SLAB INFILL, MATCH EXISTING DEPTH, V.I.F.

BASEMENT -7' - 10"

EXISTING JOIST

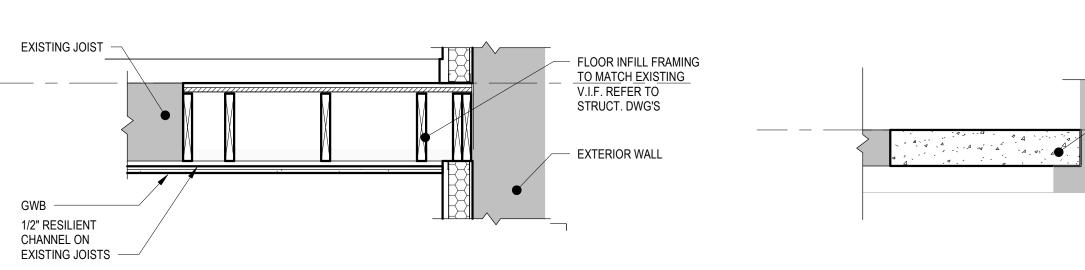

5/8" GWB TYPE XA6 WALL

- CEILING ASSEMBLY: 5/8" GWB 2x4 MTL STUD

2 FLOOR INFILL DETAIL @ REAR STAIR
A-501 3/4" = 1'-0"

EXISTING JOIST

6 RATED CEILING DETAIL
A-501 3/4" = 1'-0"

1 FLOOR INFILL @ BASEMENT TRENCH
A-501 3/4" = 1'-0"

				ROOM FI	VISH SC	HEDULE			
ROOM		FLOOR	BASE		W	ALLS		CEILING	
NO	NAME	FINISH	FINISH	NORTH	EAST	SOUTH	WEST	FINISH REMAR	KS
BASEMENT									
000	STAIRWELL	PC/WD-1	B01	-	-	-	-	GWB	
001	MECHANICAL	EXISTING	-	-	-	-	-	-	
002	MECHANICAL	EXISTING	-	-	-			-	
003	MECHANICAL	EXISTING	-	-	-	-	-	-	
004	MECHANICAL	EXISTING	-	-	-	-	-		
FIRST FLOOR			_			_			
100	STAIRWELL	CPT-3/WD-1		PNT-2	PNT-1	PNT-2	PNT-1	GWB-PNT-3	
101.1	VESTIBULE	CPT-3	B02	PNT-2	PNT-1	PNT-2	PNT-1	GWB-PNT-3	
101.2	VESTIBULE	CPT-3	B02	PNT-1	PNT-1	PNT-1	PNT-1	GWB-PNT-3	
102.1	OFFICE	CPT-2	B01	PNT-1	PNT-1	PNT-1	PNT-1	GWB-PNT-3	
102.2	OFFICE	CPT-2	B01	PNT-1	PNT-1	PNT-1	PNT-1	GWB-PNT-3	
102.3	TOILET ROOM	PT-2	PTB-1	PNT-1	PNT-1	PNT-1	PNT-1	GWB-PNT-3	
103.1	LAUNDRY	LVT-1	B01	PNT-1	PNT-1	PNT-1	PNT-1	GWB-PNT-3	
103.2	JANITOR CLOSEST LIVING SPACE	LVT-1 LVT-2	B01 B02	PNT-1 PNT-1	PNT-1 PNT-1	PNT-1	PNT-1	GWB-PNT-3 GWB-PNT-3	
104.1 104.2	BATHROOM	PT-2	PTB-1	PNT-1	PNT-1	PNT-1	PNT-1	GWB-PNT-3	
104.2	BEDROOM	LVT-2	B02	PNT-1	PNT-1	PNT-1	PNT-1	GWB-PNT-3	
104.4	BEDROOM	LVT-2	B02	PNT-1	PNT-1	PNT-1	PNT-1	GWB-PNT-3	
105.1	LIVING SPACE	LVT-2	B02	PNT-1	PNT-1	PNT-1	PNT-1	GWB-PNT-3	
105.2	BATHROOM	PT-2	PTB-1	PNT-1	PNT-1	PNT-1	PNT-1	GWB-PNT-3	
105.3	BEDROOM	LVT-2	B02	PNT-1	PNT-1	PNT-1	PNT-1	GWB-PNT-3	
200 201.1 201.2	STAIRWELL LIVING SPACE BATHROOM	LVT-2/WD-1 LVT-2 PT-2	B02 B02 PTB-1	PNT-2 PNT-1 PNT-1	PNT-1 PNT-1 PNT-1	PNT-1 PNT-1	PNT-1 PNT-1 PNT-1	GWB-PNT-3 GWB-PNT-3 GWB-PNT-3	
201.3	BEDROOM LIVING SPACE	LVT-2 LVT-2	B02 B02	PNT-1 PNT-1	PNT-1 PNT-1	PNT-1	PNT-1	GWB-PNT-3 GWB-PNT-3	
202.1	BEDROOM	LVT-2	B02	PNT-1	PNT-1	PNT-1	PNT-1	GWB-PNT-3	
202.2	BATHROOM	PT-2	PTB-1	PNT-1	PNT-1	PNT-1	PNT-1	GWB-PNT-3	
202.4	BEDROOM	LVT-2	B02	PNT-1	PNT-1	PNT-1	PNT-1	GWB-PNT-3	
203.1	LIVING SPACE	LVT-2	B02	PNT-1	PNT-1	PNT-1	PNT-1	GWB-PNT-3	
203.2	BATHROOM	PT-2	PTB-1	PNT-1	PNT-1	PNT-1	PNT-1	GWB-PNT-3	
203.3	BEDROOM	LVT-2	B02	PNT-1	PNT-1	PNT-1	PNT-1	GWB-PNT-3	
203.4	BEDROOM	LVT-2	B02	PNT-1	PNT-1	PNT-1	PNT-1	GWB-PNT-3	
204.1	LIVING SPACE	LVT-2	B02	PNT-1	PNT-1	PNT-1	PNT-1	GWB-PNT-3	
204.2	BEDROOM	LVT-2	B02	PNT-1	PNT-1	PNT-1	PNT-1	GWB-PNT-3	
204.3	BATHROOM	PT-2	PTB-1	PNT-1	PNT-1	PNT-1	PNT-1	GWB-PNT-3	
204.4	BEDROOM	LVT-2	B02	PNT-1	PNT-1	PNT-1	PNT-1	GWB-PNT-3	
HIRD FLOOR									
300	STAIRWELL	LVT-2/WD-1	B02	PNT-2	PNT-1	PNT-2	PNT-1	GWB-PNT-3	
301.1	LIVING SPACE	LVT-2	B02	PNT-1	PNT-1	PNT-1	PNT-1	GWB-PNT-3	
301.2	BATHROOM	PT-2	PTB-1	PNT-1	PNT-1	PNT-1	PNT-1	GWB-PNT-3	
301.3	BEDROOM	LVT-2	B02	PNT-1	PNT-1	PNT-1	PNT-1	GWB-PNT-3	
302.1	LIVING SPACE	LVT-2	B02	PNT-1	PNT-1	PNT-1	PNT-1	GWB-PNT-3	
302.2	BEDROOM	LVT-2	B02	PNT-1	PNT-1	PNT-1	PNT-1	GWB-PNT-3	
302.3	BATHROOM	PT-2	PTB-1	PNT-1	PNT-1	PNT-1	PNT-1	GWB-PNT-3	
302.4	BEDROOM	LVT-2	B02	PNT-1	PNT-1	PNT-1	PNT-1	GWB-PNT-3	
303.1	LIVING SPACE	LVT-2	B02	PNT-1	PNT-1	PNT-1	PNT-1	GWB-PNT-3	
303.2	BATHROOM	PT-2	PTB-1	PNT-1	PNT-1	PNT-1	PNT-1	GWB-PNT-3	
303.3	BEDROOM BEDROOM	LVT-2 LVT-2	B02 B02	PNT-1 PNT-1	PNT-1 PNT-1	PNT-1 PNT-1	PNT-1	GWB-PNT-3 GWB-PNT-3	
303.4	LIVING SPACE	LVT-2	B02 B02	PNT-1	PNT-1	PNT-1	PNT-1	GWB-PNT-3	
304.1	BEDROOM	LVT-2	B02	PNT-1	PNT-1	PNT-1	PNT-1	GWB-PNT-3	
304.3	BATHROOM	PT-2	PTB-1	PNT-1	PNT-1	PNT-1	PNT-1	GWB-PNT-3	
304.4	BEDROOM	LVT-2	B02	PNT-1	PNT-1	PNT-1	PNT-1	GWB-PNT-3	
30		1-··-	- ·	1	1	1	1	· · · · · ·	

*ALL CLOSESTS TREATED SAME AS	ADJOINING ROOM

			FINISH MATERIAL LIST	
FLOOR				
MATERIAL	TAG	MANUFACTURER	MODEL	NOTES
CARPET	CPT-1	MILLIKEN	OBEX ENTRANCE FLOORING STYLE CUT COLOR GREY TILE SIZE 19"x19"	
CARPET	CPT-2	INTERFACE	LAUNCH PAD ARTIST PROOF 125280AK00 COLOR:107480 GRAPHITE	
CARPET	CPT-3	INTERFACE	SR7799 104915 KHAKI	VESTIBULE AND ENTRANCE FLOOR STAIRWELL
PORCELAIN TILE	PT-1	DALTILE	DELEGATE COLOR OFF WHITE DL25 12"x24"	TBD
PORCELAIN TILE	PT-2	DALTILE	OUTLANDER GRAND DESIGN COLOR:ONYX OU59	BATHROOMS
LVT	LVT-1	INTERFACE	BRUSHED LINES A01605 GRAPHITE	TBD
LVT	LVT-2	INTERFACE	NATURAL WOOD GRAINS CEDAR A00212	TBD
				TBD
WOOD STEPS	WD-1	CONTRACTOR MADE 2" WOOD STEPS	CENTRAL MAIN STAIRS: CEDAR FINISH	
BASE				
VINLY BASE	BO1	TARKETT REVEAL 4-1/4"	COLOR TBD	
VOOD BASE	BO2	TARKETT MANDALAY TB3 4-1/2"	COLOR TO MATCH WALL	
ORCELAIN TILE	PTB-1	DALTILE	OUTLANDER COLLECTION MARINE COLOR OU59 12"X24"	
WALLS PORCELAIN TILE	PWT-1	ARTWALK DESIGN	AWD-T1198	
PORCELAIN TILE	PWT-1	ARTWALK DESIGN	AWD-T1198	
PORCELAIN TILE	PWT-2	DALTILE	SATRE POKE COLOR:CONFETTI FLECKS PK23 12"x24"	BACKSPLASH IN OFFICES KITCHENETTES
PORCELAIN TILE	PWT-3	DALTILE	SATRE POKE COLOR:CLOUD FLECKS PK23 12"x24"	BACKSPLASH IN RESIDENTIAL UNITS
PORCELAIN TILE	PWT-4	DALTILE	OUTLANDER COLLECTION MARINE COLOR OU59 12"X24"	SHOWER TILE
PAINT	PNT-1	BENJAMIN MOORE	WHITE OC-151	UNIT PAINT
PAINT	PNT-2	BENJAMIN MOORE	CSP-110 VINTAGE PEWTER	STAIRWELL/VESTIBULE PAINT
PAINT	PNT-3	BENJAMIN MOORE	CHINTILLY LACE OC-65	UNIT CEILINGS
SURFACES				
DEKTON	QTZ-1	SILVERKOAST	LAGUNA VELVET FINISH 2 CM	KITCHEN ISLAND AND COUNTERTOPS
WOOD SURROUND	WD-2	LAMINATED WOOD LOOK ENCLOSURE	CHERRY FINISH	KITCHEN ENCLOSURE
CABINETS				
WOLF CABINETS		ENDEAVOR	EASTON SERIES: POLAR	UNIT CABINETRY
CEILINGS	<u>'</u>			
GWB	GWB			
MISC.	<u> </u>			

ROLLER SHADE TBD AND COLOR PAVEMENT


GENERAL FINISH NOTES:
PNT-1 THROUGHOUT UNLESS OTHERWISE NOTED
ALL WALL PAINT FINISHED IS MATTE
BASE AND TRIM IS THE WALL COLOR


FB-1

SELECT BLINDS

WINDOW TREATMENTS



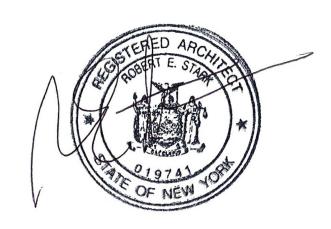

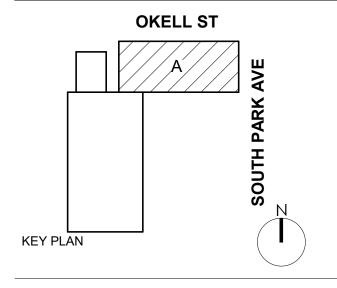

DOFI PROPERTIES

SOUTH PARK MIXED USE

2221 SOUTH PARK AVE BUFFALO, NY 14220

	REV.#	DESCRIPTION	DATE
•			


JOB NO.	2508
SCALE	1/4" = 1'-0"
ISSUE DATE	08/04/25
DRAWN BY	Gac
CHECKED BY	JMC
TUICI	

THIS IS A SINGLE SHEET OF A COHESIVE SET OF CONSTRUCTION DOCUMENTS (INCLUDING DRAWINGS AND SPECIFICATIONS). INTERPRETATION OF THE INFORMATION AS PRESENTED SHOULD BE BASED ON THE ENTIRE SET OF DOCUMENTS.

DRAWING TITLE

FINISH SCHEDULE


A-600

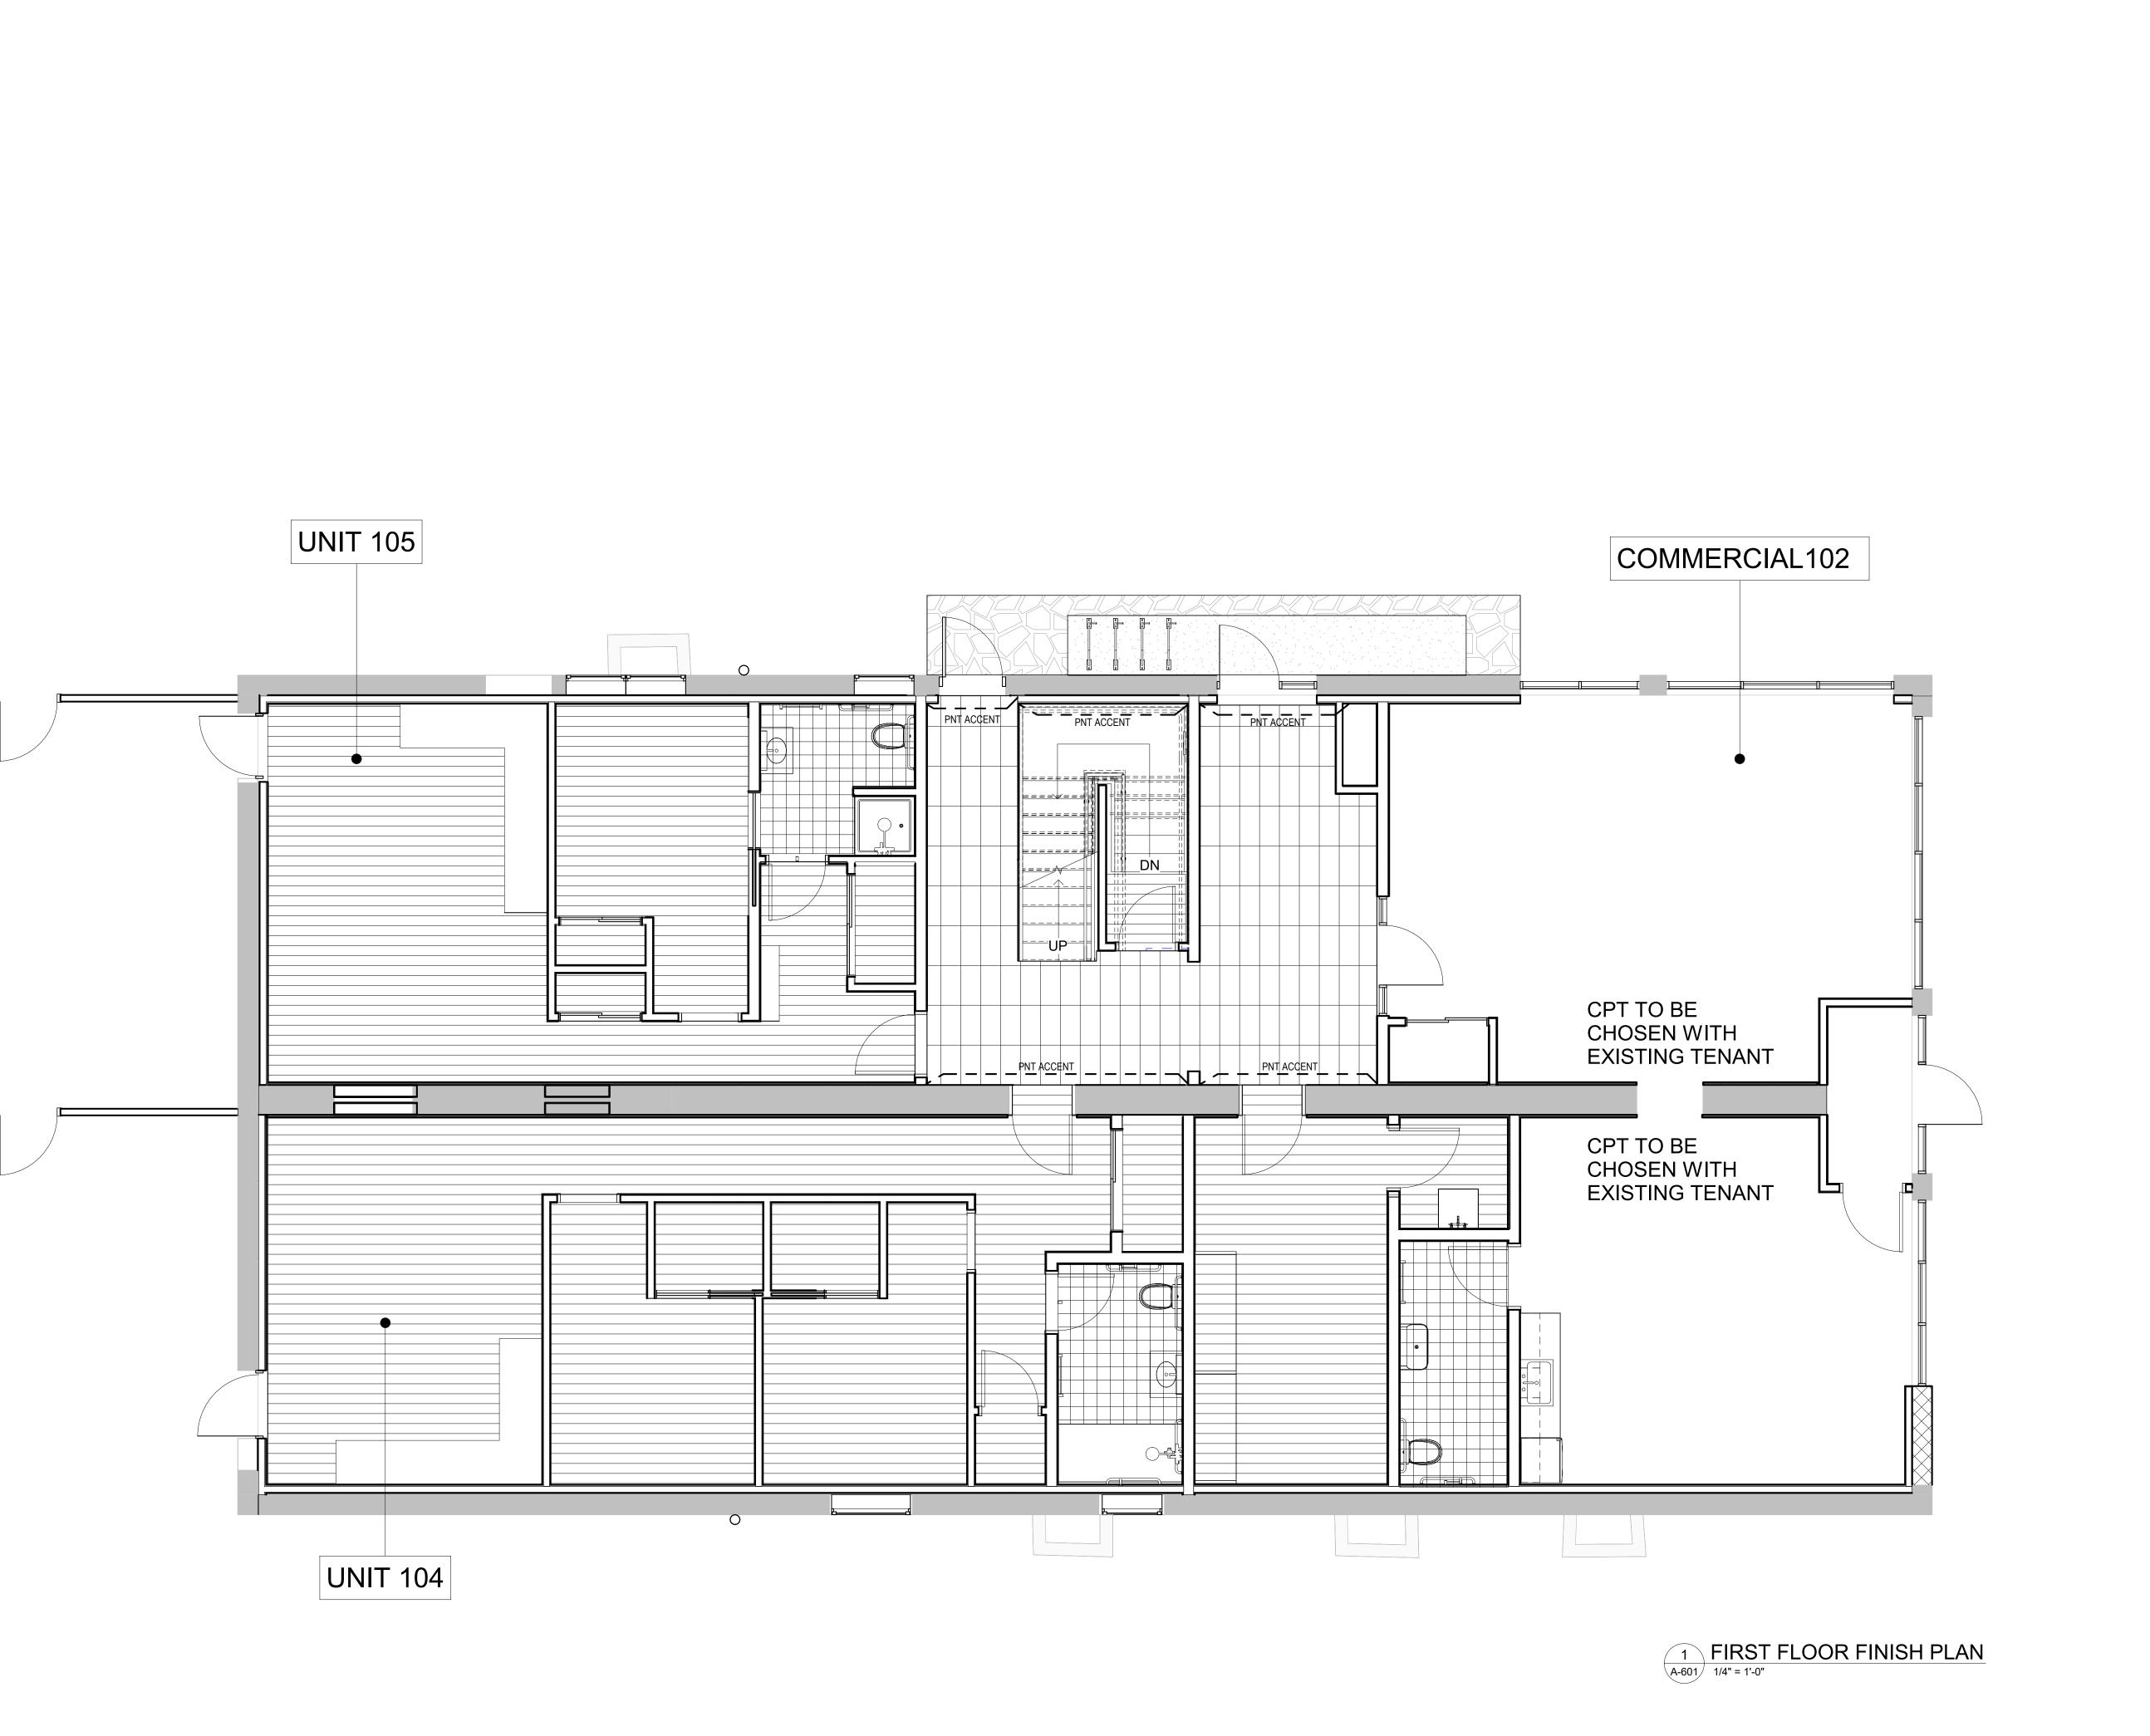






LVT-1

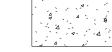



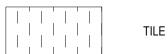











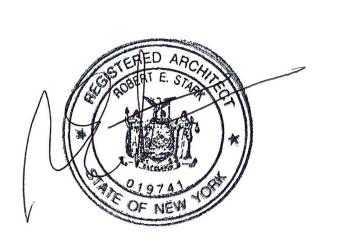

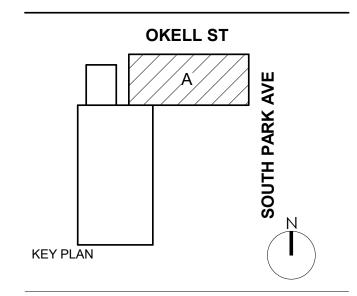

DOFI PROPERTIES

SOUTH PARK MIXED USE

2221 SOUTH PARK AVE BUFFALO, NY 14220

REV.#	DESCRIPTION	DATE


JOB NO.	2508
SCALE	1/4" = 1'-0"
ISSUE DATE	08/04/25
DRAWN BY	Author
CHECKED BY	Checker
<u> </u>	


THIS IS A SINGLE SHEET OF A COHESIVE SET OF CONSTRUCTION DOCUMENTS (INCLUDING DRAWINGS AND SPECIFICATIONS). INTERPRETATION OF THE INFORMATION AS PRESENTED SHOULD BE BASED ON THE ENTIRE SET OF DOCUMENTS.


DRAWING TITLE

FIRST FLOOR FINISH PLAN

A-601

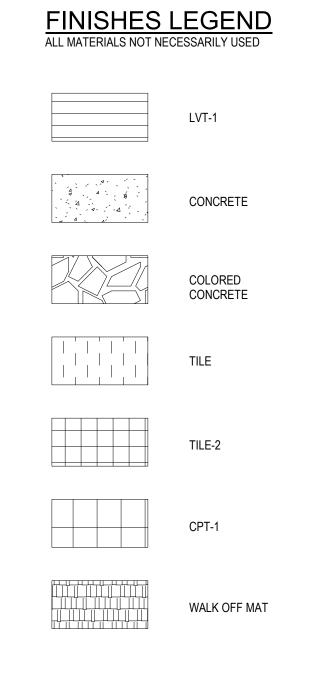

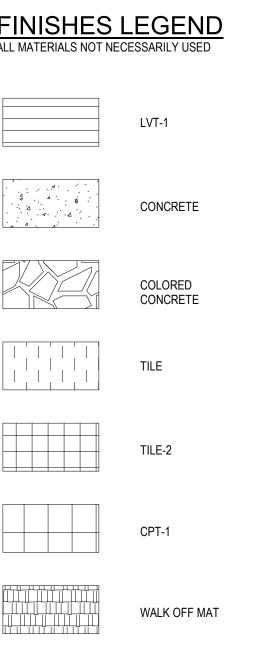

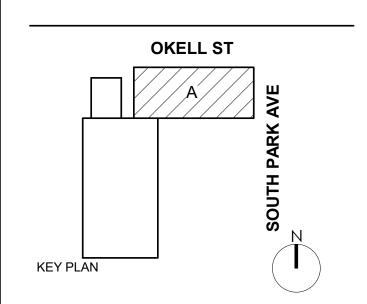

ARCHITECTS

BUFFALO | ROCHESTER www.cjsarchitects.com

DOFI PROPERTIES

SOUTH PARK MIXED USE

2221 SOUTH PARK AVE BUFFALO, NY 14220

REV.#	DESCRIPTION	DATE


JOB NO.	2508
SCALE	1/4" = 1'-0"
SSUE DATE	08/04/25
DRAWN BY	Author
CHECKED BY	Checker


THIS IS A SINGLE SHEET OF A COHESIVE SET OF CONSTRUCTION DOCUMENTS (INCLUDING DRAWINGS AND SPECIFICATIONS). INTERPRETATION OF THE INFORMATION AS PRESENTED SHOULD BE BASED ON THE ENTIRE SET OF DOCUMENTS.


DRAWING TITLE


SECOND FLOOR FINISH PLAN

A-602

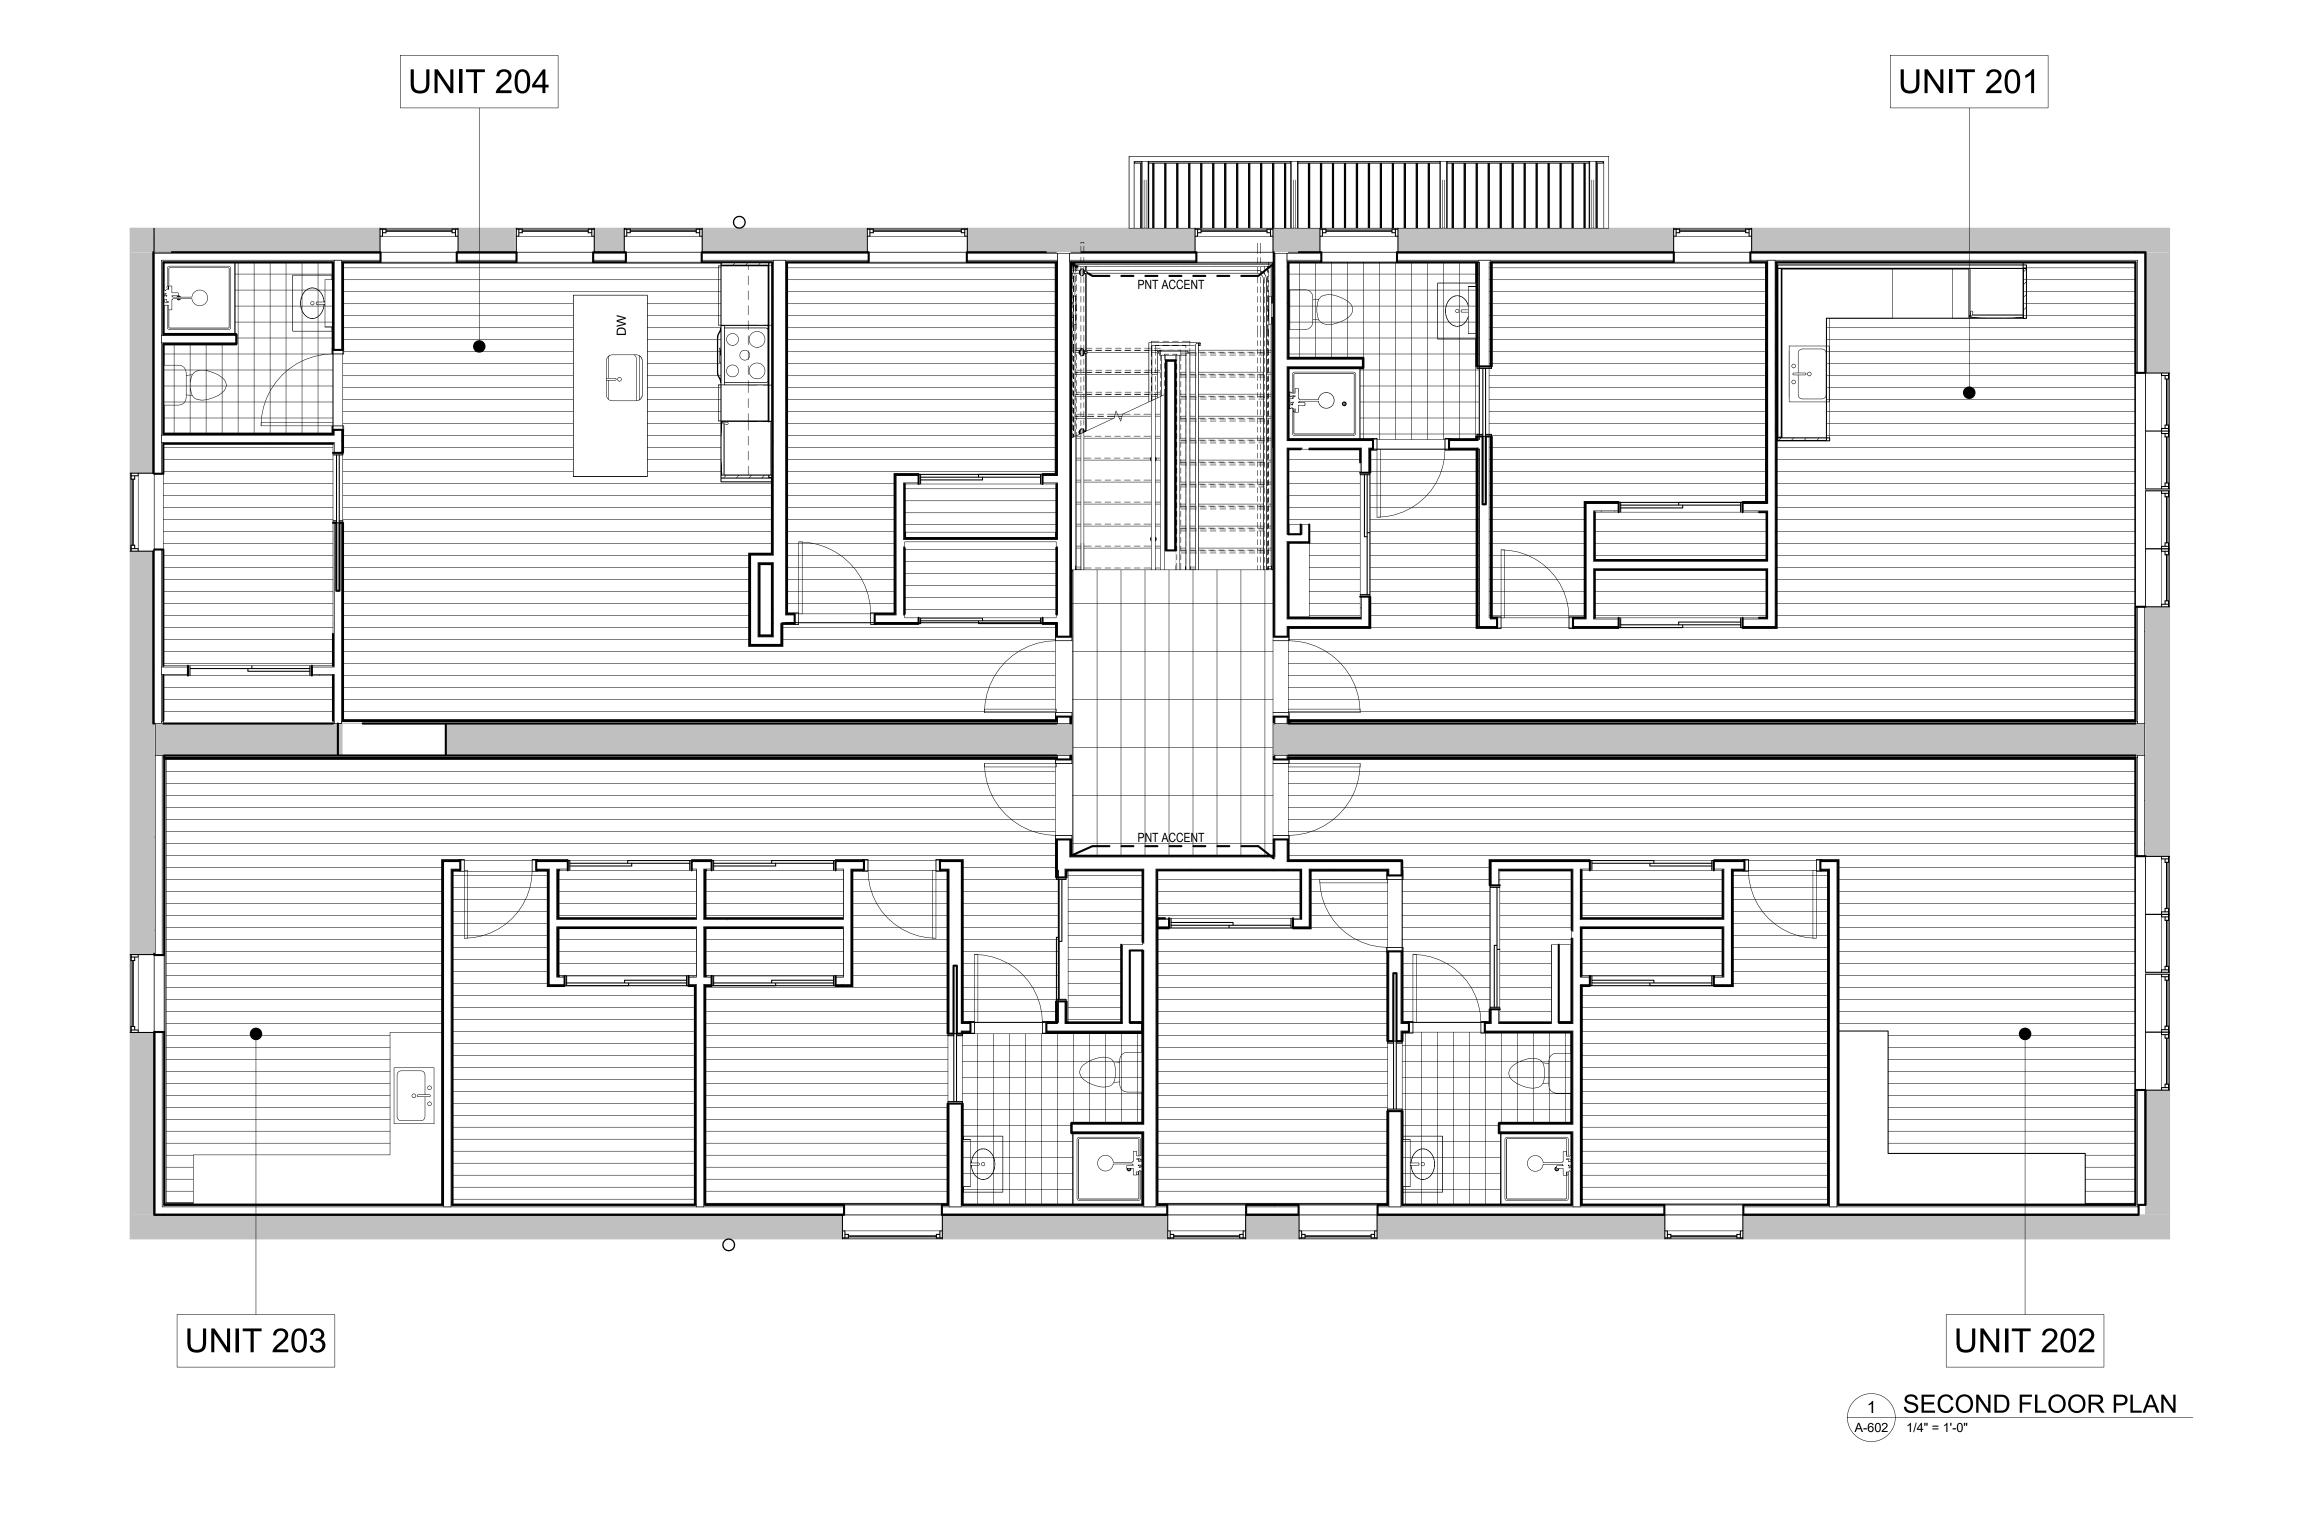

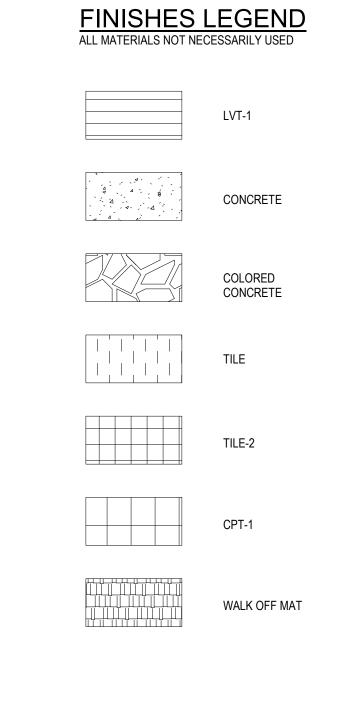

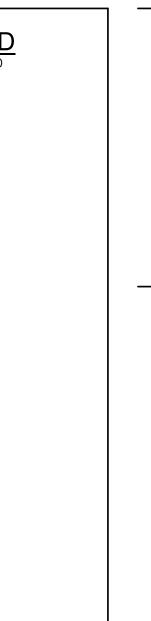

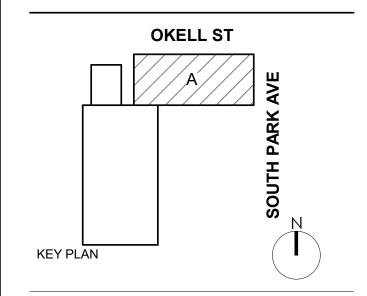

ARCHITECTS

BUFFALO | ROCHESTER www.cjsarchitects.com

DOFI PROPERTIES

SOUTH PARK MIXED USE

2221 SOUTH PARK AVE BUFFALO, NY 14220

REV.#	DESCRIPTION	DATE


JOB NO.	2508
SCALE	1/4" = 1'-0"
SSUE DATE	08/04/25
DRAWN BY	Author
CHECKED BY	Checker
	·


THIS IS A SINGLE SHEET OF A COHESIVE SET OF CONSTRUCTION DOCUMENTS (INCLUDING DRAWINGS AND SPECIFICATIONS). INTERPRETATION OF THE INFORMATION AS PRESENTED SHOULD BE BASED ON THE ENTIRE SET OF DOCUMENTS.

DRAWING TITLE

THIRD FLOOR FINISH PLAN


A-603

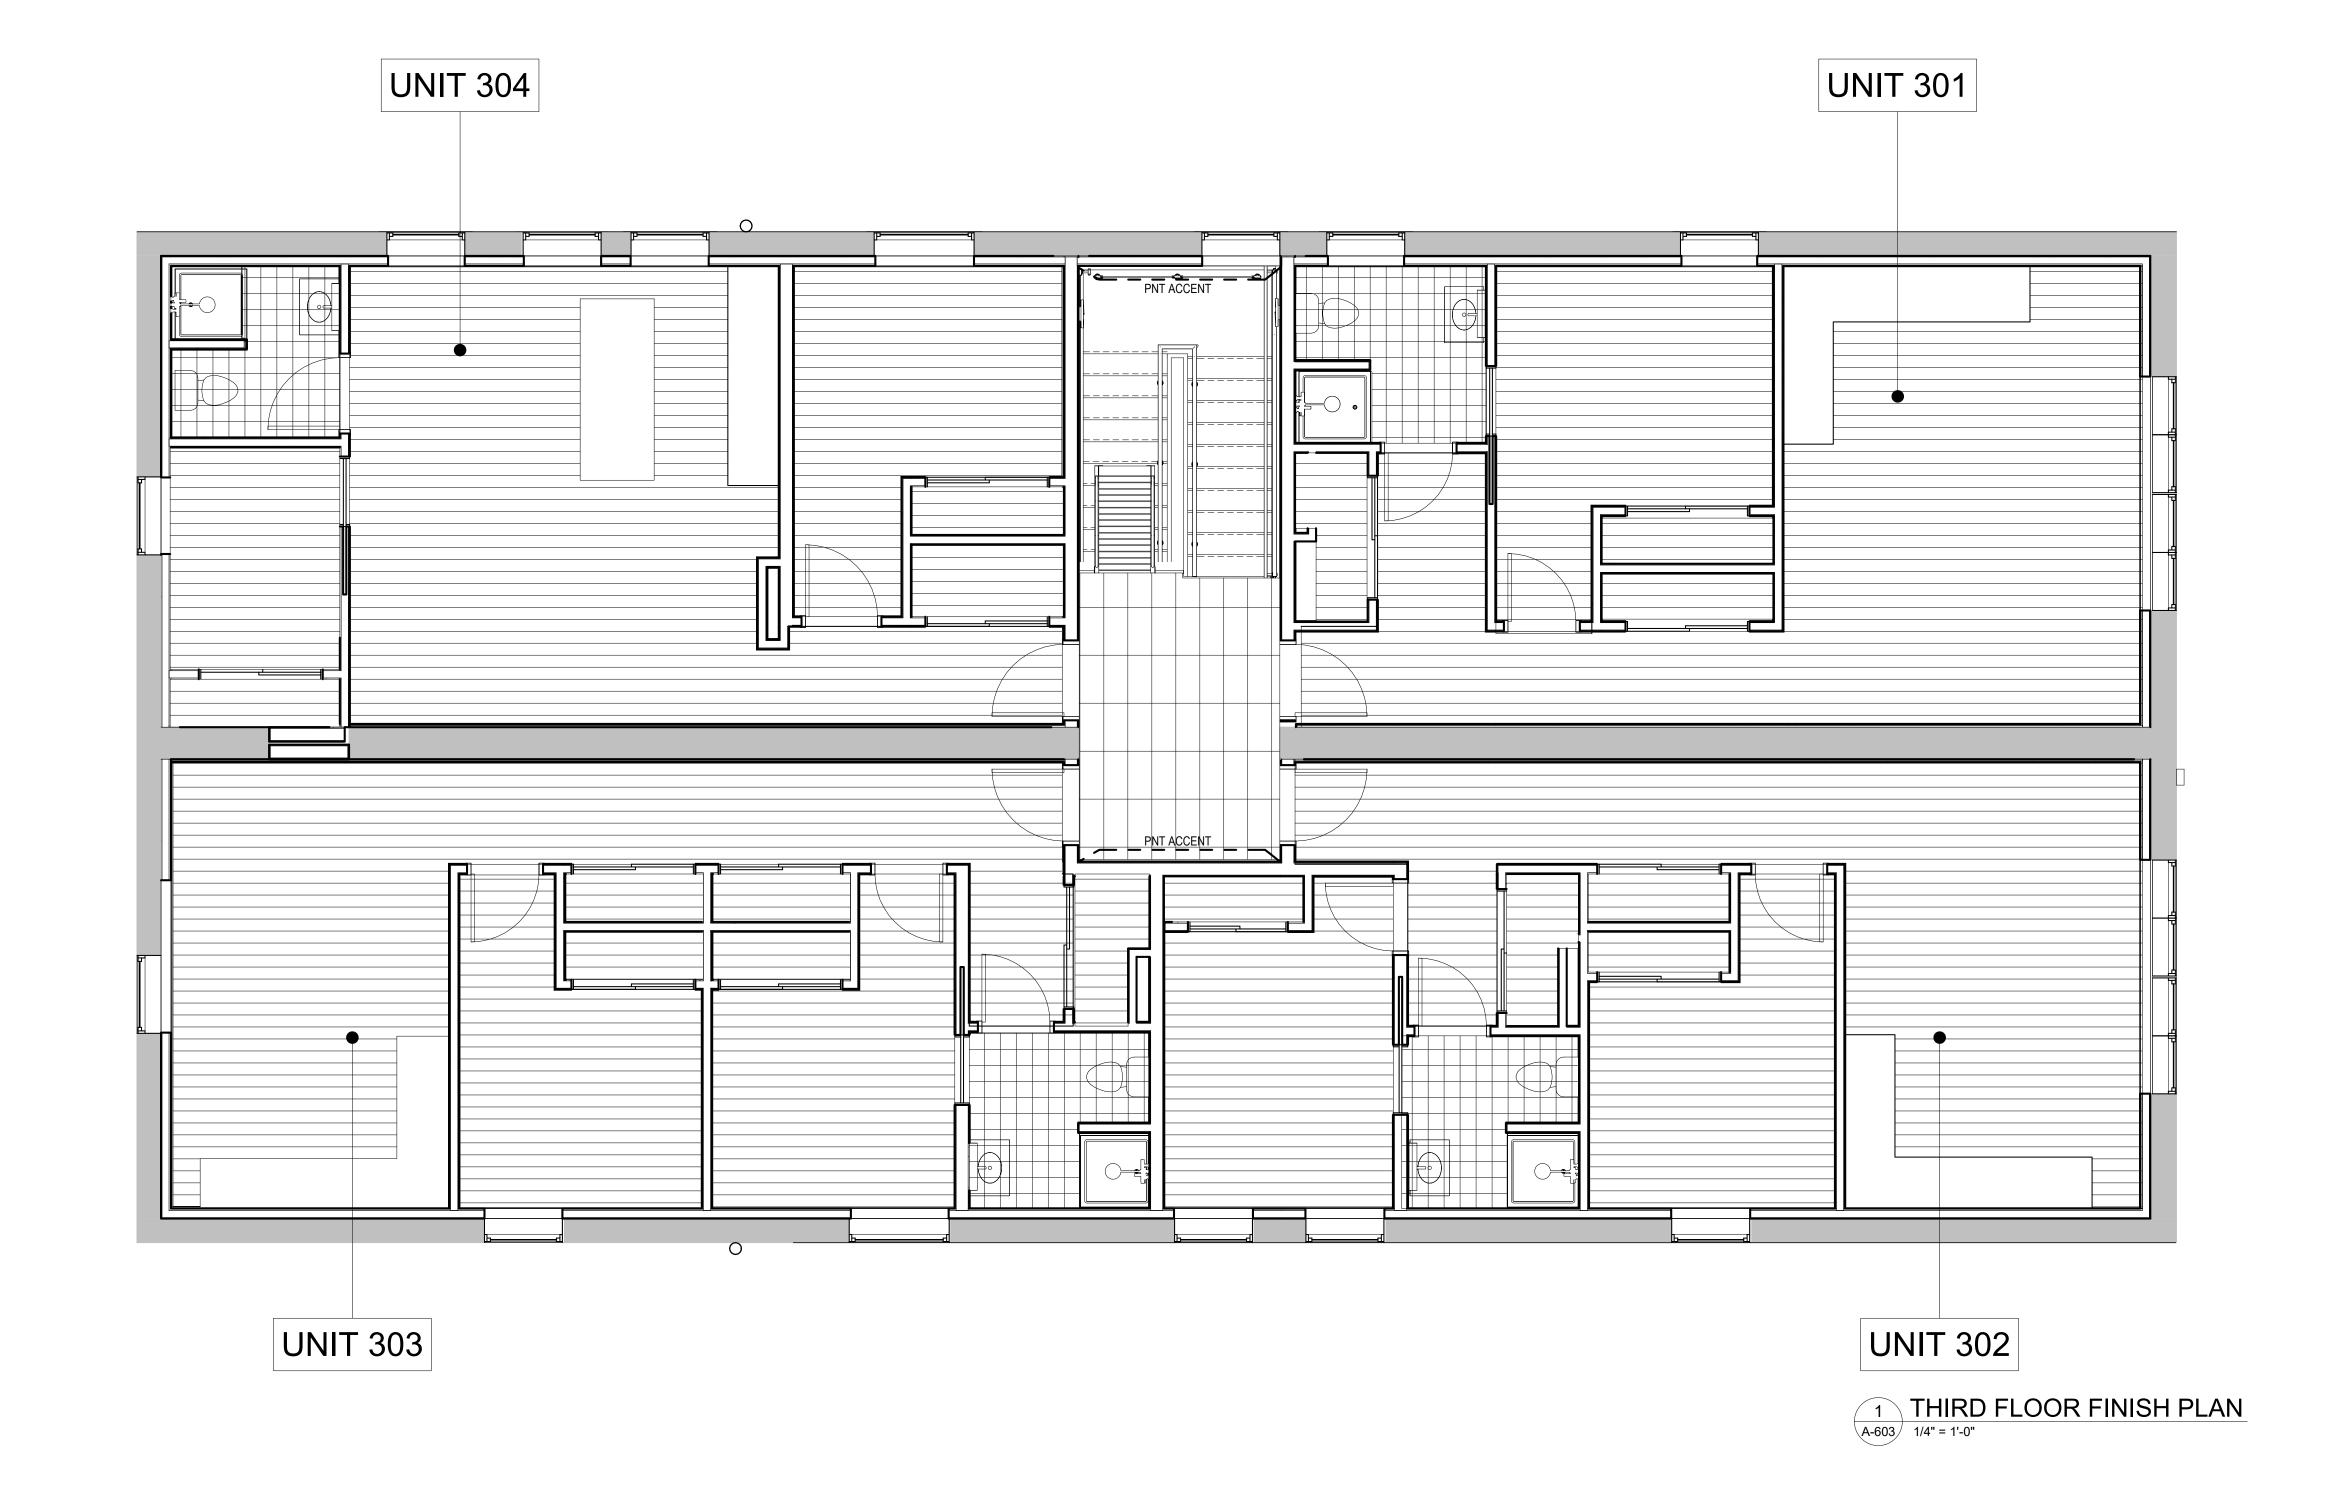

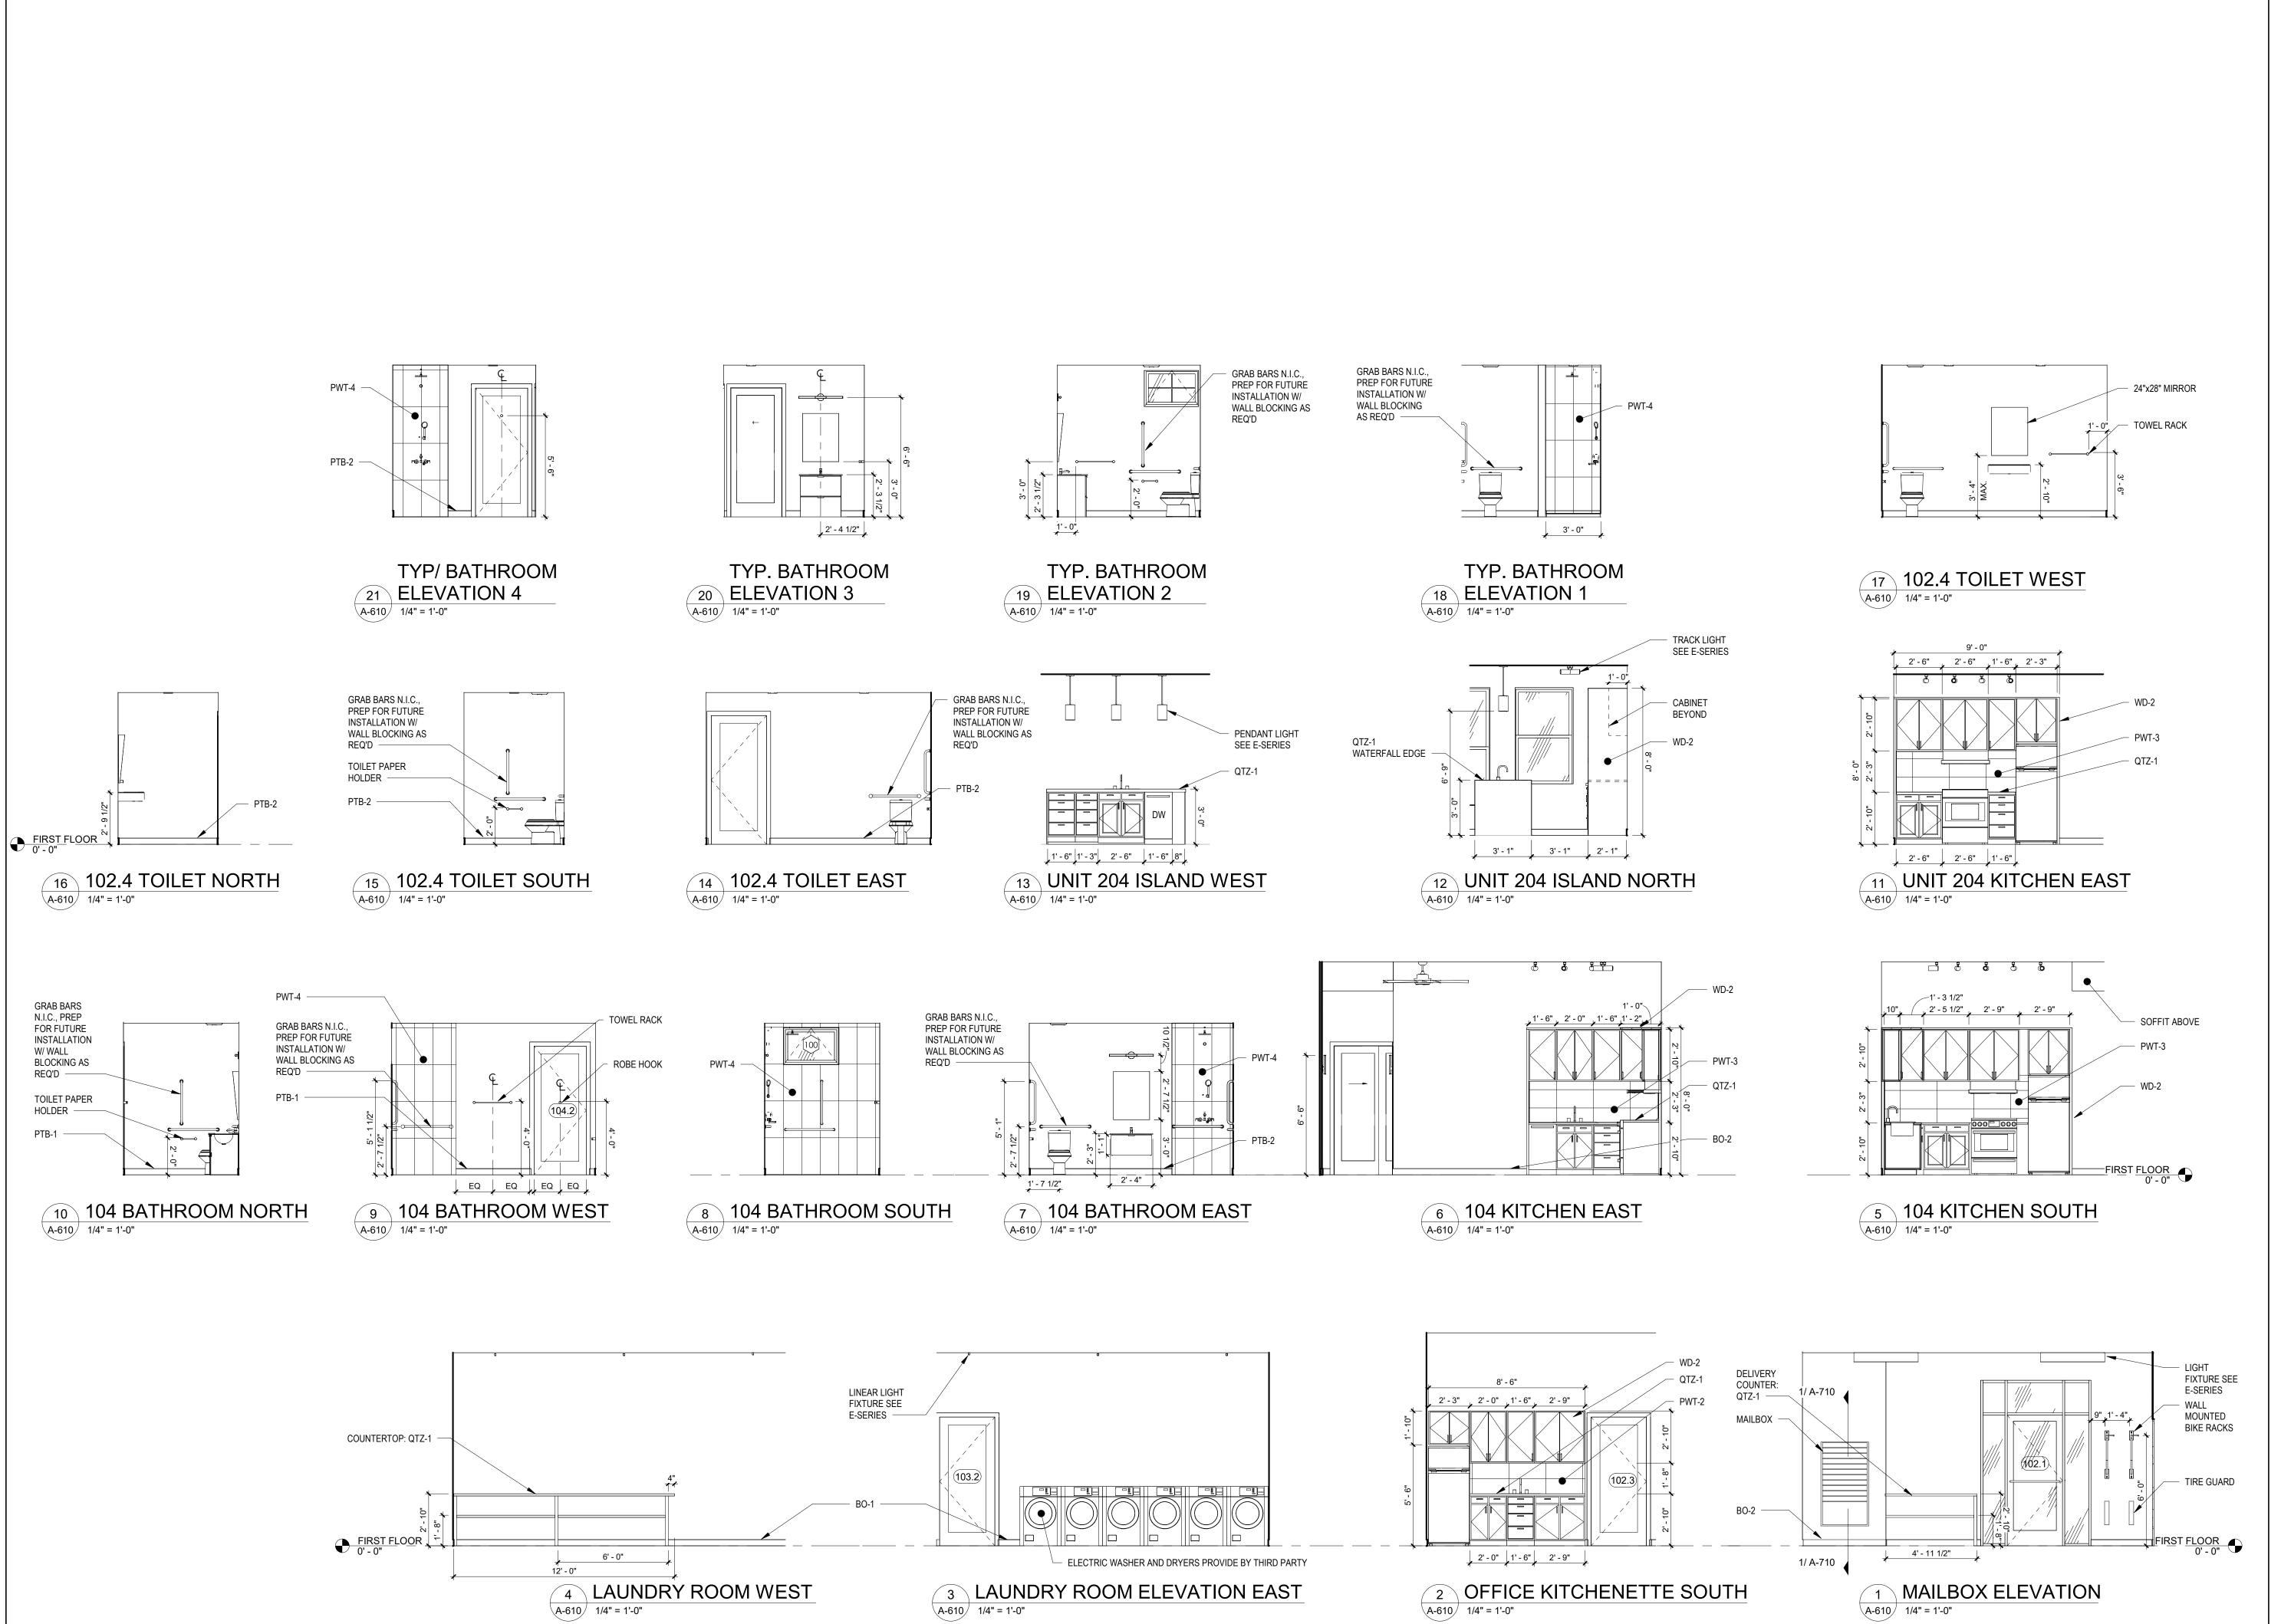





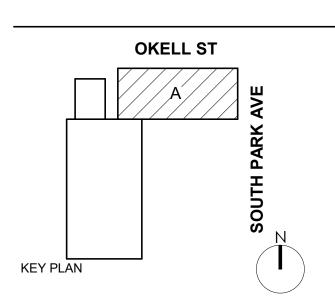

SOUTH PARK MIXED USE

2221 SOUTH PARK AVE BUFFALO, NY 14220

REV. # DESCRIPTION DATE

JOB NO.	2508
SCALE	1/4" = 1'-0'
ISSUE DATE	08/04/25
DRAWN BY	Gad
CHECKED BY	JMC
THIS IS A SINGLE SHEET OF A COHESIVE SET OF CONSTRUCTION DOCUMENTS	


THIS IS A SINGLE SHEET OF A COHESIVE SET OF CONSTRUCTION DOCUMENTS (INCLUDING DRAWINGS AND SPECIFICATIONS). INTERPRETATION OF THE INFORMATION AS PRESENTED SHOULD BE BASED ON THE ENTIRE SET OF DOCUMENTS.

DRAWING TITLE


INTERIOR ELEVATIONS


A-610




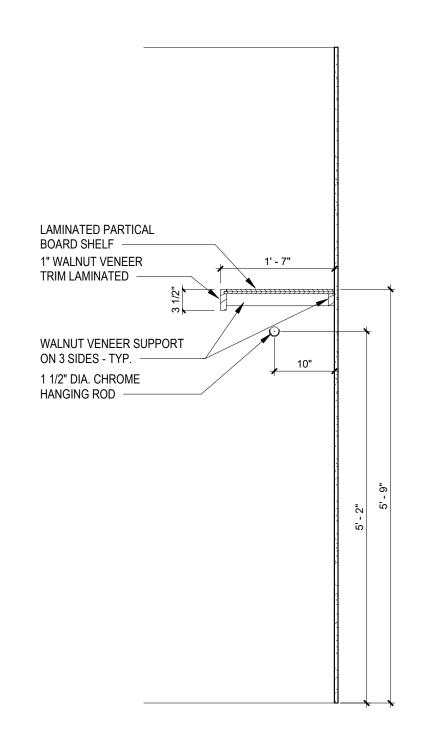


9 MILLWORK CLOSEST DETAIL
A-710 3/4" = 1'-0"

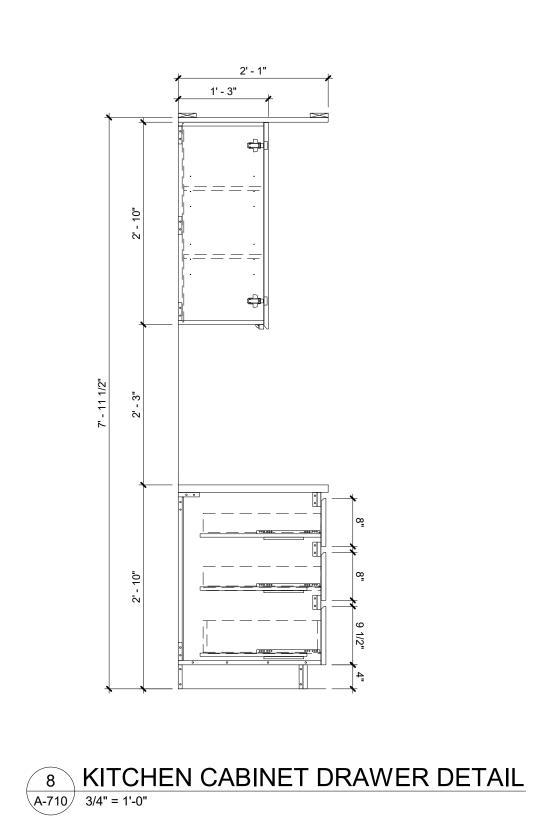


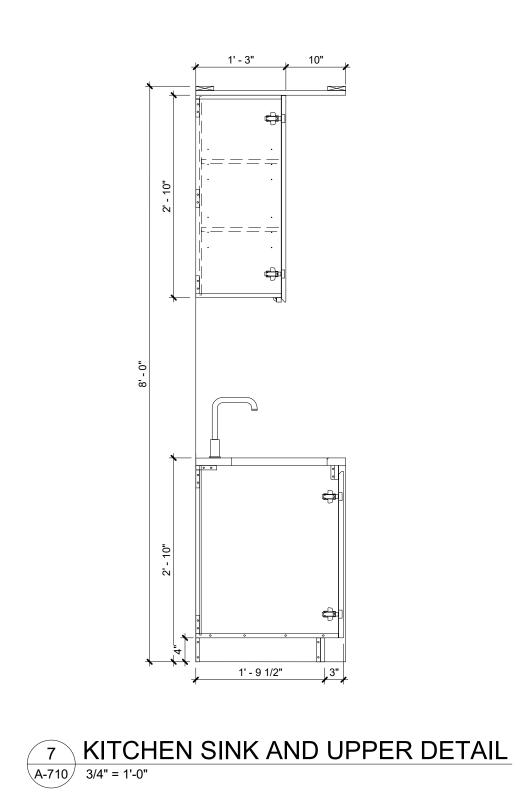

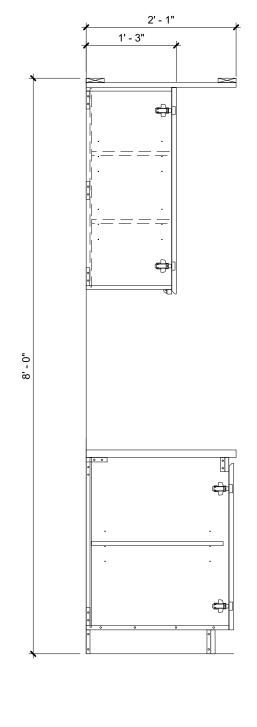


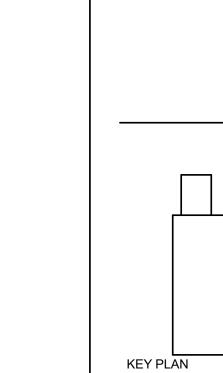



6 KITCHEN CABINET DETAIL
A-710 3/4" = 1'-0"

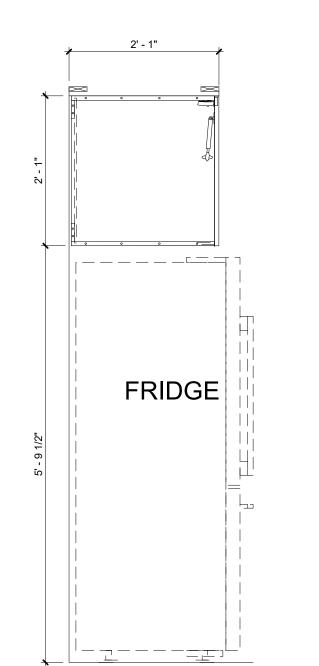



5 KITCHEN MILLWORK FRIDGE DETAIL
A-710 3/4" = 1'-0"

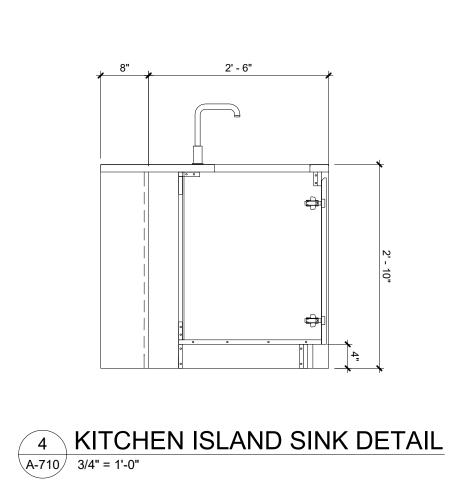

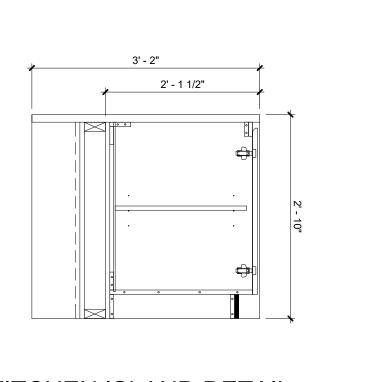

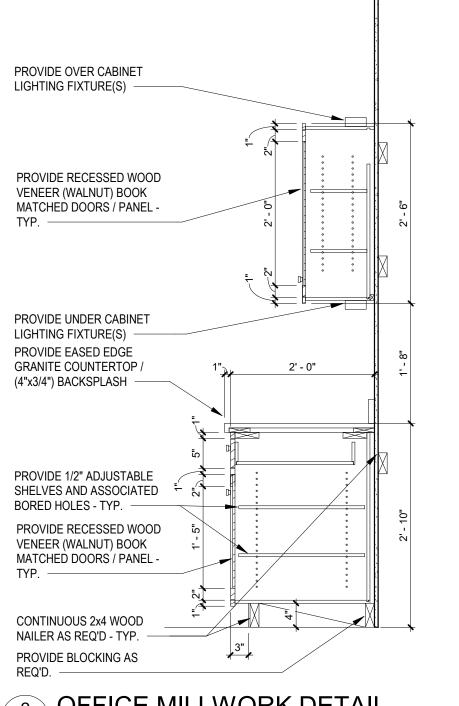

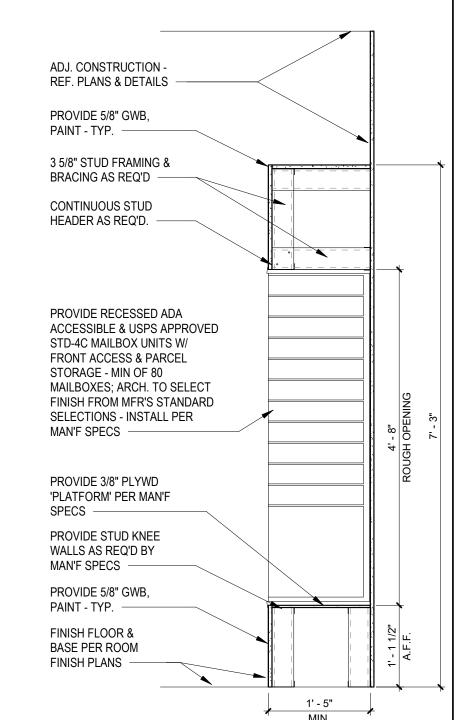

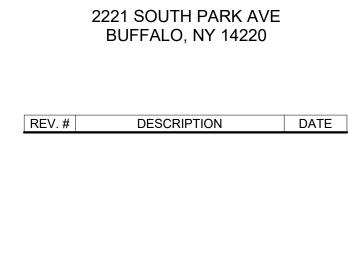

OKELL ST

DOFI PROPERTIES

SOUTH PARK

MIXED USE

JOB NO.	2508
SCALE	3/4" = 1'-0
ISSUE DATE	08/04/2
DRAWN BY	Autho
CHECKED BY	Checke
THIS IS A SINGLE SHEET OF A COHESIVE SET OF CONSTRUCTION DOCUMENTS (INCLUDING DRAWINGS AND SPECIFICATIONS' INTERPRETATION OF THE INFORMATION AS PRESENTED SHOULD BE BASED ON THE ENTIRE SET OF DOCUMENTS.).

DRAWING TITLE

MILLWORK **DETAILS**

A-710

OFFICE MILLWORK DETAIL

A-710 3/4" = 1'-0" 3 KITCHEN ISLAND DETAIL
A-710 3/4" = 1'-0" 1 RECESSED MAILBOX DETAIL A-710 3/4" = 1'-0" PERMIT SET

WALL TYPE NOTES

- 1. PROVIDE CONTINUOUS BEAD OF SEALANT AT TOP AND BOTTOM STUDS OF ALL PARTITION WALLS THAT SEPERATE A CORRIDOR. HALLWAY, TENANTS, MECHANICAL CLOSETS, COMMON SPACES, AND UTILITY SPACES FROM AN OCCUPIED SPACE. AT FIRE RATED PARTITIONS, PROVIDE FIRE RATED SEALANT.
- SEAL ALL OPENINGS, GAPS PENETRATIONS, AND JOINTS IN PARTITION TYPES AS FOLLOWS: FIRE RATED PARTITIONS: SEAL IN ACCORDANCE WITH THE
- REQUIREMENTS SPECIFIED FOR THROUGH PENETRATION FIRESTOP SYSTEMS AND FIRE RESISTIVE JOINT SYSTEMS. SMOKE TIGHT PARTITIONS: SEAL COMPLETELY WITH ELASTOMERIC SEALANT, FOR LOCATION AND EXTEND OF PARTITIONS. DESIGNATED AS "SMOKE TIGHT" REFER TO CODE COMPLIANCE DRAWINGS
- AND OTHER LOCATIONS AS INDICATED AND REQUIRED ELSEWHERE BY THE CONTRACT DOCUMENTS. FOR ALL JANITOR'S CLOSETS AND WALLS ADJACENT TO WET WALL LOCATIONS - PROVIDE 1 LAYER 5/8" MOISTURE RESISTANT G.W.B. ON WET SIDE OF WALL IN LIEU OF G.W.B. SHOWN ON PARTITION TYPE.
- BOARD. FOR WALL SCHEDULED TO RECIEVE CERAMIC TILE WALL FINISH, REPLACE GYPSUM WALL BOARD BEHIND CERAMIC TILE WITH CEMENT BACKER BOARD UNITS.

THIS NOTE DOES NOT APPLY TO PARTION TYPES USING CEMENT


SEE WALL SECTIONS FOR EXTERIOR WALL TYPES. ALL INTERIOR PARTITION GYPSUM BOARD TO EXTEND TO UNDERSIDE OF FLOOR SLAB OR ROOF DECK ABOVE ON BOTH SIDES UNLESS OTHERWISE NOTED.



ARCHITECTS

BUFFALO | ROCHESTER

www.cjsarchitects.com

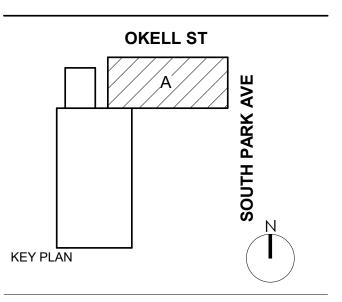

DOFI PROPERTIES

SOUTH PARK MIXED USE

2221 SOUTH PARK AVE BUFFALO, NY 14220

REV.#	DESCRIPTION	DATE
`		

JOB NO.	2508
SCALE	As indicated
SSUE DATE	08/04/25
DRAWN BY	NJM/JC
CHECKED BY	RES


THIS IS A SINGLE SHEET OF A COHESIVE SET OF CONSTRUCTION DOCUMENTS (INCLUDING DRAWINGS AND SPECIFICATIONS). INTERPRETATION OF THE INFORMATION AS PRESENTED SHOULD BE BASED ON THE ENTIRE SET OF DOCUMENTS.


DRAWING TITLE

PARTITION SCHEDULE

A-800

PERMIT SET

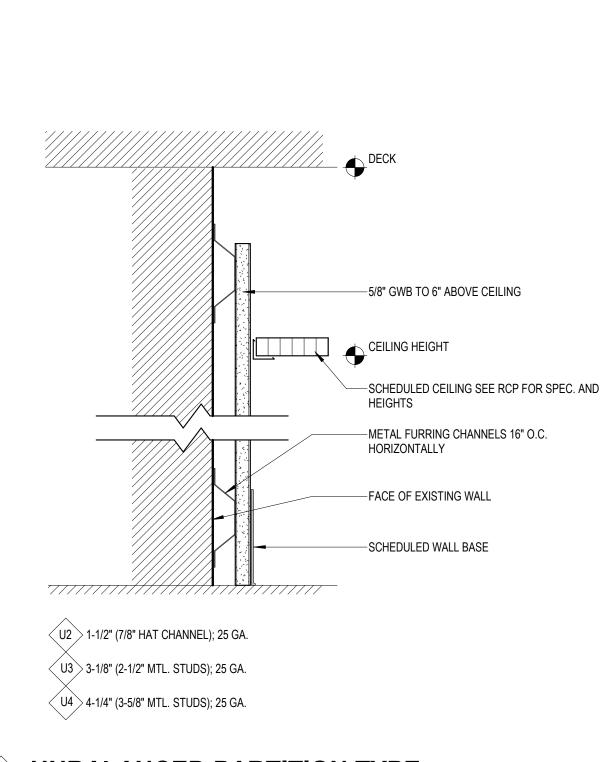

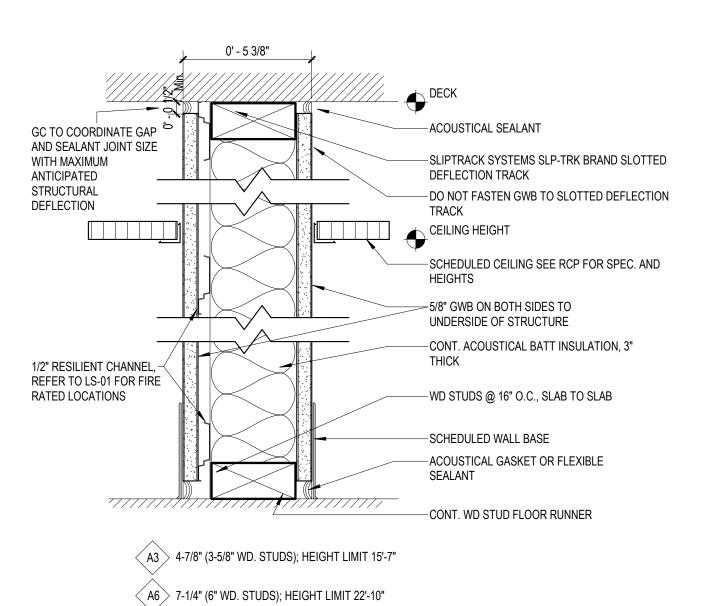

C CMU PARTITION TYPE
CONCRETE MASONRY UNIT

C8 7-5/8" CMU

9 1/8"

- 5/8" G.W.B. -SEE WALL TYPES BELOW

MORTAR

7/8" HAT CHANNEL AT 16" O.C. -SEE WALL TYPES BELOW

- 8 x 8 x 16" CONCRETE MASONARY UNIT -

NOTE: COMPRESSIVE FILLER W/ FIRE RESISTIVE JOINT SYSTEM AT TOP AND

WALL REINFORCING AND GROUTING AS SPECIFIED PER STRUCT. ENG.

BOTTOM OF C.M.U.

7 5/8"

UNBALANCED PARTITION TYPE Non-rated Furred Partition

*USE MR RATED DRYWALL IN BATHROOMS

*USE MR RATED DRYWALL IN BATHROOMS

METAL STUD INSULATED PARTITION TYPE

DOOR			Der	Desir		DOOR	CI ACC		FRAME			
NO.	WIDTH	HEIGHT	Door Type	Door Material	Hardware	FINISH	GLASS TYPE	FIRE RATING	TYPE	MATERIAL	FINISH	COMMENTS
BASEMENT												
001	3' - 0"	6' - 8"	F	НМ	2	PT2	-	-	1	HM	PT2	PREHUNG DOOR + FRAME
002	3' - 0"	7' - 0"	С	НМ	2	PT2	-	-	1	HM	PT2	PREHUNG DOOR + FRAME
003	3' - 0"	6' - 8"	F	НМ	2	PT2	-	-	1	HM	PT2	PREHUNG DOOR + FRAME
												1
FIRST FLOOF	2											
100.1	3' - 0"	8' - 0"	В	ALUM	11	CLR	2	15min	-	ALUM	CLR	
100.2	5' - 6"	7' - 0"	K		N/A	PT	-	15 min.			PT	FIRE SHUTTER
100.3	2' - 10"	7' - 0"	G	HM	10	PT2	-	15 min.	1	HM	PT	PREHUNG DOOR + FRAME
101.1	3' - 0"	8' - 0"	Α	ALUM	8	CLR	2	-	-	ALUM	CLR	
101.2	3' - 0"	8' - 0"	Α	ALUM	12	CLR	2	-	-	ALUM	CLR	
102.1	3' - 0"	7' - 1 1/4"	Α	ALUM	8	CLR	1	-	-	ALUM	CLR	
102.2	3' - 0"	7' - 0"	С	НМ	3	PT2	-	-	1	HM	PT2	PREHUNG DOOR + FRAME
102.3	3' - 0"	7' - 0"	С	WSC	3	PT2	-	-	2	WD	PT	PREHUNG DOOR + FRAME
102.4	4' - 0"	7' - 0"	D	WSC	5	PT2	-	-	2	WD	PT	PREHUNG DOOR + FRAME
103.1	3' - 0"	6' - 8"	F	НМ	7	PT2	-	-	1	HM	PT2	PREHUNG DOOR + FRAME
103.2	3' - 0"	7' - 0"	С	НМ	6	PT2	-	-	1	HM	PT2	PREHUNG DOOR + FRAME
104.1	3' - 0"	7' - 0"	С	WC	1	PT2	-	15 min.	1	HM	PT2	PREHUNG DOOR + FRAME
104.2	2' - 10"	7' - 0"	G	WSC	3	PT2	-	-	2	WD	PT	PREHUNG DOOR + FRAME
104.3A	2' - 10"	7' - 0"	G	WSC	2	PT2	-	-	2	WD	PT	PREHUNG DOOR + FRAME
104.3B	2' - 8"	6' - 8"	E	WSC	4	PT2	-	-	2	WD	PT	PREHUNG DOOR + FRAME
104.4A	2' - 10"	7' - 0"	G	WSC	2	PT2	-	-	2	WD	PT	PREHUNG DOOR + FRAME
104.4B	2' - 8"	6' - 8"	E	WSC	4	PT2	-	-	2	WD	PT	PREHUNG DOOR + FRAME
104.5	2' - 10"	7' - 0"	G	WSC	2	PT2	-	-	2	WD	PT	PREHUNG DOOR + FRAME
104.6	5' - 0"	7' - 0"	J	WSC	5	PT2	-	-	2	WD	PT	PREHUNG DOOR + FRAME
104.7	3' - 2"	7' - 11 1/4"	A	ALUM	9	CLR	2	-	-	ALUM	CLR	
105.1	3' - 0"	7' - 0"	С	WC	1	PT2	-	15 min.	1	HM	PT2	PREHUNG DOOR + FRAME
105.2A	2' - 10"	7' - 0"	G	WSC	3	PT2	_	-	2	WD	PT	PREHUNG DOOR + FRAME
105.2B	2' - 10"	7' - 0"	ı	WSC	4	PT2	_	-	-	-	_	POCKET DOOR
105.3A	2' - 10"	7' - 0"	G	WSC	2	PT2	_	-	2	WD	PT	PREHUNG DOOR + FRAME
105.3B	4' - 0"	7' - 0"	D	WSC	5	PT2	_	_	2	WD	PT	PREHUNG DOOR + FRAME
105.4	5' - 0"	7' - 0"	J	WSC	5	PT2	_	-	2	WD	PT	PREHUNG DOOR + FRAME
105.5	4' - 0"	7' - 0"	D	WSC	5	PT2	_	-	2	WD	PT	PREHUNG DOOR + FRAME
105.6	3' - 0"	7' - 11 1/4"	A	ALUM	9	CLR	2		-	ALUM	CLR	TRETIONS BOOK : TRAINE
106	3' - 0"	7' - 0"	C	ALOW	13	PT2	-	_	_	ALOW	OLIX	FENCE GATE DOOR
107	3' - 0"	7' - 0"	С		13	PT2	-	-				FENCE GATE DOOR
		,			1.0	· · -						
SECOND FLO	OR											
201.1	3' - 0"	7' - 0"	С	WC	1	PT2	_	15 min.	1	НМ	PT2	PREHUNG DOOR + FRAME
201.1 201.2A				VVO	•	1 12	_				_	I INCLIDING DOOR : I INAME
	7' - 10"	∣7' - ∩"	G		3	PT2	_	-				PREHLING DOOR + FRAME
	2' - 10"	7' - 0" 7' - 0"	G	WSC	3	PT2 PT2	-	-	2	WD -	_	
201.2B	2' - 10"	7' - 0"	I	WSC	4	PT2	-	-	2 -	WD -	- DT	POCKET DOOR
201.2B 201.3A	2' - 10" 2' - 10"	7' - 0" 7' - 0"	l G	WSC	4 2	PT2 PT2	-	- - -	2 - 2	WD - WD	- PT	POCKET DOOR PREHUNG DOOR + FRAME
201.2B 201.3A 201.3B	2' - 10" 2' - 10" 5' - 0"	7' - 0" 7' - 0" 7' - 0"	I	WSC WSC	4 2 5	PT2 PT2 PT2		- - - -	2 - 2 2	WD - WD WD	PT	PREHUNG DOOR + FRAME PREHUNG DOOR + FRAME
201.2B 201.3A 201.3B 201.4	2' - 10" 2' - 10" 5' - 0" 5' - 0"	7' - 0" 7' - 0" 7' - 0" 7' - 0"	I G H J	WSC WSC WSC	4 2 5 5	PT2 PT2 PT2 PT2	- - -	- - -	2 - 2 2 2	WD - WD WD WD	PT PT	POCKET DOOR PREHUNG DOOR + FRAME PREHUNG DOOR + FRAME PREHUNG DOOR + FRAME
201.2B 201.3A 201.3B 201.4 201.5	2' - 10" 2' - 10" 5' - 0" 5' - 0"	7' - 0" 7' - 0" 7' - 0" 7' - 0" 7' - 0"	G H J	WSC WSC WSC	4 2 5	PT2 PT2 PT2 PT2 PT2	- - - -	- - - - -	2 - 2 2 2 2	WD - WD WD WD WD	PT PT PT	POCKET DOOR PREHUNG DOOR + FRAME PREHUNG DOOR + FRAME PREHUNG DOOR + FRAME PREHUNG DOOR + FRAME
201.2B 201.3A 201.3B 201.4 201.5 202.1	2' - 10" 2' - 10" 5' - 0" 5' - 0" 5' - 0" 3' - 0"	7' - 0" 7' - 0" 7' - 0" 7' - 0" 7' - 0" 7' - 0"	G H J H	WSC WSC WSC WSC	4 2 5 5 5 1	PT2 PT2 PT2 PT2 PT2 PT2 PT2	- - - - -	- - - - - - 15 min.	2 - 2 2 2 2 2	WD - WD WD WD HM	PT PT PT PT2	POCKET DOOR PREHUNG DOOR + FRAME
201.2B 201.3A 201.3B 201.4 201.5 202.1 202.2A	2' - 10" 2' - 10" 5' - 0" 5' - 0" 5' - 0" 3' - 0" 2' - 10"	7' - 0" 7' - 0" 7' - 0" 7' - 0" 7' - 0" 7' - 0" 7' - 0"	G H J H C	WSC WSC WSC WC WSC	4 2 5 5 5 1 2	PT2 PT2 PT2 PT2 PT2 PT2 PT2 PT2 PT2	- - - - -	- - - - - - 15 min.	2 - 2 2 2 2 1 2	WD - WD WD WD HM WD	PT PT PT PT2 PT	POCKET DOOR PREHUNG DOOR + FRAME
201.2B 201.3A 201.3B 201.4 201.5 202.1 202.2A 202.2B	2' - 10" 2' - 10" 5' - 0" 5' - 0" 5' - 0" 3' - 0" 2' - 10" 5' - 0"	7' - 0" 7' - 0" 7' - 0" 7' - 0" 7' - 0" 7' - 0" 7' - 0"	I G H J H C G	WSC WSC WSC WC WSC WSC	4 2 5 5 5 1 2 5	PT2	- - - - - - -	- - - - - - 15 min. -	2 - 2 2 2 2 2 1 2	WD - WD	PT PT PT PT2 PT PT	POCKET DOOR PREHUNG DOOR + FRAME
201.2B 201.3A 201.3B 201.4 201.5 202.1 202.2A 202.2B 202.3A	2' - 10" 2' - 10" 5' - 0" 5' - 0" 5' - 0" 3' - 0" 2' - 10" 5' - 0"	7' - 0" 7' - 0"	G H J H C	WSC WSC WSC WC WSC WSC WSC WSC	4 2 5 5 5 1 2 5 3	PT2	- - - - - - -	- - - - - - 15 min. - -	2 2 2 2 2 1 2 2 2	WD - WD WD WD HM WD	PT PT PT PT2 PT	POCKET DOOR PREHUNG DOOR + FRAME
201.2B 201.3A 201.3B 201.4 201.5 202.1 202.2A 202.2B 202.3A 202.3B	2' - 10" 2' - 10" 5' - 0" 5' - 0" 5' - 0" 3' - 0" 2' - 10" 2' - 10" 2' - 10"	7' - 0" 7' - 0" 7' - 0" 7' - 0" 7' - 0" 7' - 0" 7' - 0" 7' - 0" 7' - 0" 7' - 0" 7' - 0"	I G H J H C G H	WSC WSC WSC WSC WSC WSC WSC WSC WSC	4 2 5 5 5 1 2 5 3 4	PT2	- - - - - - - -	- - - - - - 15 min. - - -	2 - 2 2 2 2 1 2 2 2 2	WD - WD WD WD HM WD WD WD	PT PT PT2 PT PT PT PT -	POCKET DOOR PREHUNG DOOR + FRAME POCKET DOOR
201.2B 201.3A 201.3B 201.4 201.5 202.1 202.2A 202.2B 202.3A 202.3B 202.4A	2' - 10" 2' - 10" 5' - 0" 5' - 0" 5' - 0" 3' - 0" 2' - 10" 2' - 10" 2' - 10" 2' - 10"	7' - 0" 7' - 0" 7' - 0" 7' - 0" 7' - 0" 7' - 0" 7' - 0" 7' - 0" 7' - 0" 7' - 0" 7' - 0" 7' - 0"	I G H J H C G H G	WSC	4 2 5 5 5 1 2 5 3 4 2	PT2	- - - - - - - - -	- - - - - 15 min. - - - -	2 - 2 2 2 2 1 2 2 2 - 2	WD - WD WD WD HM WD	PT PT PT2 PT PT PT PT PT PT	POCKET DOOR PREHUNG DOOR + FRAME
201.2B 201.3A 201.3B 201.4 201.5 202.1 202.2A 202.2B 202.3A 202.3B 202.4A 202.4B	2' - 10" 2' - 10" 5' - 0" 5' - 0" 5' - 0" 2' - 10" 2' - 10" 2' - 10" 2' - 10" 5' - 0"	7' - 0" 7' - 0" 7' - 0" 7' - 0" 7' - 0" 7' - 0" 7' - 0" 7' - 0" 7' - 0" 7' - 0" 7' - 0" 7' - 0" 7' - 0"	I G H J H C G H	WSC	4 2 5 5 5 1 2 5 3 4 2 5	PT2	- - - - - - - - - -	- - - - - 15 min. - - - -	2 - 2 2 2 2 1 2 2 - 2 2	WD - WD WD WD WD HM WD	PT PT PT2 PT PT PT PT PT - PT PT	POCKET DOOR PREHUNG DOOR + FRAME POCKET DOOR PREHUNG DOOR + FRAME PREHUNG DOOR + FRAME
201.2B 201.3A 201.3B 201.4 201.5 202.1 202.2A 202.2B 202.3A 202.3B 202.4A 202.4B 202.4B	2' - 10" 2' - 10" 5' - 0" 5' - 0" 5' - 0" 3' - 0" 2' - 10" 2' - 10" 2' - 10" 2' - 10" 5' - 0" 5' - 0"	7' - 0" 7' - 0" 7' - 0" 7' - 0" 7' - 0" 7' - 0" 7' - 0" 7' - 0" 7' - 0" 7' - 0" 7' - 0" 7' - 0" 7' - 0" 7' - 0"	I G H J H C G H G I G	WSC	4 2 5 5 5 1 2 5 3 4 2 5 5	PT2	- - - - - - - - - - -	- - - - - - 15 min. - - - - -	2 - 2 2 2 2 1 2 2 2 - 2 2 2	WD - WD WD WD WD HM WD	PT PT PT2 PT PT PT PT PT PT PT PT PT	POCKET DOOR PREHUNG DOOR + FRAME POCKET DOOR PREHUNG DOOR + FRAME
201.2B 201.3A 201.3B 201.4 201.5 202.1 202.2A 202.2B 202.3A 202.3B 202.4A 202.4B 202.5 202.6	2' - 10" 2' - 10" 5' - 0" 5' - 0" 5' - 0" 3' - 0" 2' - 10" 2' - 10" 2' - 10" 2' - 10" 5' - 0" 5' - 0" 5' - 0"	7' - 0" 7' - 0" 7' - 0" 7' - 0" 7' - 0" 7' - 0" 7' - 0" 7' - 0" 7' - 0" 7' - 0" 7' - 0" 7' - 0" 7' - 0" 7' - 0" 7' - 0"	I G H J H C G H G I G H	WSC	4 2 5 5 5 1 2 5 3 4 2 5	PT2		- - - - - - 15 min. - - - - - -	2 - 2 2 2 2 1 2 2 2 - 2 2 2 2	WD - WD	PT P	POCKET DOOR PREHUNG DOOR + FRAME
201.2B 201.3A 201.3B 201.4 201.5 202.1 202.2A 202.2B 202.3A 202.3B 202.4A 202.4B 202.5 202.6	2' - 10" 2' - 10" 5' - 0" 5' - 0" 5' - 0" 2' - 10" 2' - 10" 2' - 10" 2' - 10" 2' - 10" 5' - 0" 5' - 0" 5' - 0" 5' - 0"	7' - 0" 7' - 0" 7' - 0" 7' - 0" 7' - 0" 7' - 0" 7' - 0" 7' - 0" 7' - 0" 7' - 0" 7' - 0" 7' - 0" 7' - 0" 7' - 0" 7' - 0" 7' - 0"	I G H J H C G H G I G H J H	WSC	4 2 5 5 5 1 2 5 3 4 2 5 5 5 5	PT2	- - - - - - - - - - - - -	- - - - - - 15 min. - - - - - - - - 15 min.	2 - 2 2 2 2 1 2 2 - 2 2 2 2 2 1	WD - WD	PT PT PT2 PT	POCKET DOOR PREHUNG DOOR + FRAME
201.2B 201.3A 201.3B 201.4 201.5 202.1 202.2A 202.2B 202.3A 202.3B 202.4A 202.4B 202.4B 202.6 203.1	2' - 10" 2' - 10" 5' - 0" 5' - 0" 5' - 0" 2' - 10" 2' - 10" 2' - 10" 2' - 10" 5' - 0" 5' - 0" 5' - 0" 5' - 0" 5' - 0" 2' - 10"	7' - 0" 7' - 0" 7' - 0" 7' - 0" 7' - 0" 7' - 0" 7' - 0" 7' - 0" 7' - 0" 7' - 0" 7' - 0" 7' - 0" 7' - 0" 7' - 0" 7' - 0" 7' - 0" 7' - 0" 7' - 0"	I G H J H C G H G I G H	WSC	4 2 5 5 5 1 2 5 3 4 2 5 5 5 5 1 2 5	PT2		- - - - - - 15 min. - - - - - - - - 15 min.	2 - 2 2 2 2 1 2 2 - 2 2 2 2 2 2 2 2	WD - WD	PT P	POCKET DOOR PREHUNG DOOR + FRAME
201.2B 201.3A 201.3B 201.4 201.5 202.1 202.2A 202.2B 202.3A 202.3B 202.4A 202.4B 202.6 203.1 203.2A 203.2B	2' - 10" 2' - 10" 5' - 0" 5' - 0" 5' - 0" 3' - 0" 2' - 10" 2' - 10" 2' - 10" 2' - 10" 5' - 0" 5' - 0" 5' - 0" 5' - 0" 2' - 10" 2' - 10"	7' - 0" 7' - 0" 7' - 0" 7' - 0" 7' - 0" 7' - 0" 7' - 0" 7' - 0" 7' - 0" 7' - 0" 7' - 0" 7' - 0" 7' - 0" 7' - 0" 7' - 0" 7' - 0" 7' - 0" 7' - 0" 7' - 0"	I G H J H C G H G H J H C	WSC	4 2 5 5 5 1 2 5 3 4 2 5 5 5 1 3 4 2 5 5	PT2	- - - - - - - - - - - - -	- - - - - - 15 min. - - - - - - - - 15 min.	2 - 2 2 2 2 2 1 2 - 2 - 2 - 2 2	WD - WD	PT P	POCKET DOOR PREHUNG DOOR + FRAME
201.2B 201.3A 201.3B 201.4 201.5 202.1 202.2A 202.2B 202.3A 202.3B 202.4A 202.4B 202.5 202.6 203.1 203.2A 203.2A 203.2A	2' - 10" 2' - 10" 5' - 0" 5' - 0" 5' - 0" 3' - 0" 2' - 10" 2' - 10" 2' - 10" 5' - 0" 5' - 0" 5' - 0" 5' - 0" 5' - 10" 2' - 10" 2' - 10" 2' - 10" 2' - 10" 2' - 10"	7' - 0" 7' - 0" I G H J H C G H G H J H C G	WSC	4 2 5 5 5 1 2 5 3 4 2 5 5 5 5 1 3 4 2 5 5	PT2		- - - - - - 15 min. - - - - - - - - 15 min.	2 - 2 2 2 1 2 2 - 2 2 2 2 2 1 2 2 2 2 2	WD - WD - WD	PT P	POCKET DOOR PREHUNG DOOR + FRAME
201.2B 201.3A 201.3B 201.4 201.5 202.1 202.2A 202.2B 202.3A 202.3B 202.4A 202.4B 202.5 202.6 203.1 203.2A 203.2B 203.3A	2' - 10" 2' - 10" 5' - 0" 5' - 0" 5' - 0" 2' - 10" 2' - 10" 2' - 10" 2' - 10" 5' - 0" 5' - 0" 5' - 0" 2' - 10" 5' - 0" 5' - 0" 2' - 10" 2' - 10" 2' - 10" 2' - 10" 2' - 10"	7' - 0" 7' - 0" I G H J H C G H G I G H C G H	WSC	4 2 5 5 5 1 2 5 3 4 2 5 5 5 5 1 3 4 2 5 5 3 4 2 5 5 5 5 5 5 5 5 5 7 7 8 7 8 7 8 7 8 7 8	PT2		- - - - - - 15 min. - - - - - 15 min.	2 - 2 2 2 2 1 2 2 2 2 2 2 2 1 2 2 2 2 2	WD - WD	PT P	POCKET DOOR PREHUNG DOOR + FRAME
201.2B 201.3A 201.3B 201.4 201.5 202.1 202.2A 202.2B 202.3A 202.3B 202.4A 202.4B 202.5 202.6 203.1 203.2A 203.2B 203.3A 203.2B	2' - 10" 2' - 10" 5' - 0" 5' - 0" 5' - 0" 3' - 0" 2' - 10" 2' - 10" 2' - 10" 2' - 10" 5' - 0" 5' - 0" 5' - 0" 2' - 10" 2' - 10" 2' - 10" 2' - 10" 2' - 10" 2' - 10" 2' - 10" 2' - 10"	7' - 0" 7' - 0" I G H J H C G H G H J H C G H J H	WSC	4 2 5 5 5 1 2 5 3 4 2 5 5 5 1 3 4 2 5 5 5 2	PT2		15 min	2 - 2 2 2 1 2 2 2 2 2 2 2 2 2 2 2 2 2 2	WD - WD	PT P	POCKET DOOR PREHUNG DOOR + FRAME
201.2B 201.3A 201.3B 201.4 201.5 202.1 202.2A 202.2B 202.3A 202.3B 202.4A 202.4B 202.5 202.6 203.1 203.2A 203.2B 203.3A 203.3A 203.3B	2' - 10" 2' - 10" 5' - 0" 5' - 0" 5' - 0" 3' - 0" 2' - 10" 2' - 10" 2' - 10" 5' - 0" 5' - 0" 5' - 0" 5' - 0" 5' - 0" 2' - 10" 2' - 10" 2' - 10" 2' - 10" 2' - 10" 2' - 10" 2' - 10" 2' - 10" 5' - 0"	7' - 0" 7' - 0"	I G H J H C G H G I G H C G H	WSC	4 2 5 5 5 1 2 5 3 4 2 5 5 5 1 3 4 2 5 5 5 5 2 5 5 2 5 5 2 5 5 5 5 5 7 7 8 7 8 7 8 7 8 7 8 7 8 7 8	PT2		- - - - - 15 min. - - - - - 15 min. - - -	2 - 2 2 2 2 1 2 2 2 2 2 2 2 2 2 2 2 2 2	WD - WD	PT P	POCKET DOOR PREHUNG DOOR + FRAME
201.2B 201.3A 201.3B 201.4 201.5 202.1 202.2A 202.2B 202.3A 202.3B 202.4A 202.4B 202.4B 202.5 203.1 203.2A 203.2B 203.3A 203.3B 203.3A	2' - 10" 2' - 10" 5' - 0" 5' - 0" 5' - 0" 3' - 0" 2' - 10" 2' - 10" 2' - 10" 5' - 0" 5' - 0" 5' - 0" 2' - 10" 2' - 10" 2' - 10" 2' - 10" 2' - 10" 2' - 10" 2' - 10" 2' - 10" 5' - 0" 5' - 0" 5' - 0"	7' - 0" 7' - 0"	I G H J H C G H G H C G H J H C G H	WSC	4 2 5 5 5 1 2 5 3 4 2 5 5 5 1 3 4 2 5 5 5 5 5 5 5 5 5 5 5 5 5 5 5 5 5 5	PT2		15 min	2 - 2 2 2 2 2 2 2 2 2 2 2 2 2 2 2 2 2 2	WD - WD	PT P	POCKET DOOR PREHUNG DOOR + FRAME
201.2B 201.3A 201.3B 201.4 201.5 202.1 202.2A 202.2B 202.3A 202.3B 202.4A 202.4B 202.5 202.6 203.1 203.2A 203.2B 203.3A 203.2B 203.3A 203.4A 203.4B 203.4A	2' - 10" 2' - 10" 5' - 0" 5' - 0" 5' - 0" 3' - 0" 2' - 10" 2' - 10" 2' - 10" 2' - 10" 5' - 0" 5' - 0" 3' - 0" 2' - 10" 2' - 10" 2' - 10" 2' - 10" 2' - 10" 2' - 10" 5' - 0" 5' - 0" 5' - 0" 5' - 0" 5' - 0" 5' - 0" 5' - 0"	7' - 0" 7' - 0"	I G H J H C G H J H C G H J H C G H J H	WSC	4 2 5 5 5 1 2 5 3 4 2 5 5 5 1 3 4 2 5 5 5 5 5 5 5 5 5 5 5 5 5 5 5 5 5 5	PT2		15 min	2 - 2 2 2 2 2 2 2 2 2 2 2 2 2 2 2 2 2 2	WD - WD	PT P	POCKET DOOR PREHUNG DOOR + FRAME
201.2B 201.3A 201.3B 201.4 201.5 202.1 202.2A 202.2B 202.3A 202.3B 202.4A 202.4B 202.5 202.6 203.1 203.2A 203.2A 203.2B 203.3A 203.3B 203.4A 203.4B 203.4B 203.4B	2' - 10" 2' - 10" 5' - 0" 5' - 0" 5' - 0" 3' - 0" 2' - 10" 2' - 10" 2' - 10" 2' - 10" 5' - 0" 5' - 0" 3' - 0" 2' - 10" 2' - 10" 2' - 10" 2' - 10" 2' - 10" 5' - 0" 5' - 0" 5' - 0" 5' - 0" 5' - 0" 5' - 0" 5' - 0" 5' - 0" 5' - 0"	7' - 0" 7' - 0"	I G H J H C G H J H C G I G H J H C H H H H H H H H H H H H H H H H	WSC	4 2 5 5 5 1 2 5 3 4 2 5 5 5 1 3 4 2 5 5 5 5 5 5 5 5 5 5 5 5 5 5 5 5 5 5	PT2		15 min	2 - 2 2 2 2 2 2 2 2 2 2 2 2 2 2 2 2 2 2	WD - WD	PT P	POCKET DOOR PREHUNG DOOR + FRAME
201.2B 201.3A 201.3B 201.4 201.5 202.1 202.2A 202.2B 202.3A 202.3B 202.4A 202.4B 202.4B 202.5 203.1 203.2A 203.2B 203.3A 203.3B 203.3A 203.3B 203.4A 203.4B 203.4A	2' - 10" 2' - 10" 5' - 0" 5' - 0" 5' - 0" 3' - 0" 2' - 10" 2' - 10" 2' - 10" 2' - 10" 5' - 0" 5' - 0" 3' - 0" 2' - 10" 2' - 10" 2' - 10" 2' - 10" 2' - 10" 5' - 0" 5' - 0" 5' - 0" 5' - 0" 5' - 0" 5' - 0" 5' - 0" 5' - 0" 5' - 0"	7' - 0" 7' - 0"	I G H J H C G H J H C G I G H J H C G H C G H C G H C H C H C H C H C H	WSC	4 2 5 5 5 1 2 5 3 4 2 5 5 5 1 3 4 2 5 5 5 5 5 5 5 5 5 5 5 5 5 5 5 5 5 5	PT2		15 min	2 - 2 2 2 2 2 2 2 2 2 2 1 1 2 2 2 2 2 2	WD - WD	PT P	POCKET DOOR PREHUNG DOOR + FRAME
201.2B 201.3A 201.3B 201.4 201.5 202.1 202.2A 202.2B 202.3A 202.3B 202.4A 202.4B 202.4B 202.5 202.6 203.1 203.2A 203.2B 203.3A 203.3B 203.4A 203.3B 203.4A 203.3B	2' - 10" 2' - 10" 5' - 0" 5' - 0" 5' - 0" 3' - 0" 2' - 10" 2' - 10" 2' - 10" 2' - 10" 5' - 0" 5' - 0" 5' - 0" 2' - 10" 2' - 10" 2' - 10" 2' - 10" 2' - 10" 5' - 0" 5' - 0" 5' - 0" 5' - 0" 5' - 0" 3' - 0" 3' - 0" 3' - 0" 3' - 0"	7' - 0" 7' - 0"	I G H J H C G H J H C G H J H C G H C C	WSC	4 2 5 5 5 1 2 5 3 4 2 5 5 5 1 3 4 2 5 5 5 5 5 5 5 5 5 5 5 5 5 5 5 5 5 5	PT2		15 min	2 - 2 2 2 2 2 2 2 2 2 2 2 2 2 2 2 2 2 2	WD	PT P	POCKET DOOR PREHUNG DOOR + FRAME
201.2B 201.3A 201.3B 201.4 201.5 202.1 202.2A 202.2B 202.3A 202.3B 202.4A 202.4B 202.4B 202.5 202.6 203.1 203.2A 203.2B 203.3A 203.3B 203.4A 203.3B 203.4A 203.3B	2' - 10" 2' - 10" 5' - 0" 5' - 0" 5' - 0" 3' - 0" 2' - 10" 2' - 10" 2' - 10" 2' - 10" 5' - 0" 5' - 0" 3' - 0" 2' - 10" 2' - 10" 2' - 10" 2' - 10" 2' - 10" 5' - 0" 5' - 0" 5' - 0" 5' - 0" 5' - 0" 5' - 0" 5' - 0" 5' - 0" 5' - 0"	7' - 0" 7' - 0"	I G H J H C G H J H C G I G H J H C G H C G H C G H C H C H C H C H C H	WSC	4 2 5 5 5 1 2 5 3 4 2 5 5 5 1 3 4 2 5 5 5 5 5 5 5 5 5 5 5 5 5 5 5 5 5 5	PT2		15 min	2 - 2 2 2 2 2 2 2 2 2 2 1 1 2 2 2 2 2 2	WD - WD	PT P	POCKET DOOR PREHUNG DOOR + FRAME
201.2B 201.3A 201.3B 201.4 201.5 202.1 202.2A 202.2B 202.3A 202.3B 202.4A 202.4B 202.5 202.6 203.1 203.2A 203.2B 203.3A 203.3B 203.3A 203.3B 203.4A 203.4B 203.4B 203.4A 203.4B 203.4B	2' - 10" 2' - 10" 5' - 0" 5' - 0" 5' - 0" 3' - 0" 2' - 10" 2' - 10" 2' - 10" 2' - 10" 5' - 0" 5' - 0" 5' - 0" 2' - 10" 2' - 10" 2' - 10" 2' - 10" 2' - 10" 5' - 0" 5' - 0" 5' - 0" 5' - 0" 5' - 0" 3' - 0" 3' - 0" 3' - 0" 3' - 0"	7' - 0" 7' - 0"	I G H J H C G H J H C G H J H C G H C C	WSC	4 2 5 5 5 1 2 5 3 4 2 5 5 5 1 3 4 2 5 5 5 5 5 5 5 5 5 5 5 5 5 5 5 5 5 5	PT2		15 min	2 - 2 2 2 2 2 2 2 2 2 2 2 1 2 2 2 2 2 2	WD	PT P	POCKET DOOR PREHUNG DOOR + FRAME
201.2B 201.3A 201.3B 201.4 201.5 202.1 202.2A 202.2B 202.3A 202.3B 202.4A 202.4B 202.4B 203.1 203.2A 203.2A 203.2B 203.3A 203.3B 203.3A 203.3B 203.4A 203.4B 203.4A 203.4B 203.4B 203.4B 203.4B	2' - 10" 2' - 10" 5' - 0" 5' - 0" 5' - 0" 3' - 0" 2' - 10" 2' - 10" 2' - 10" 2' - 10" 5' - 0" 5' - 0" 3' - 0" 2' - 10" 2' - 10" 5' - 0" 5' - 0" 5' - 0" 5' - 0" 5' - 0" 5' - 0" 5' - 0" 5' - 0" 5' - 0" 5' - 0" 5' - 0" 5' - 0" 5' - 0" 5' - 0" 5' - 0" 5' - 0" 5' - 0" 5' - 0" 5' - 0"	7' - 0" 7' - 0"	I G H J H C G H J H C G I G H J H C G H C H C H C H C H C H C H H C H H H H	WSC	4 2 5 5 5 1 2 5 3 4 2 5 5 5 1 3 4 2 5 5 5 5 5 5 5 5 5 5 5 5 5 5 5 5 5 5	PT2		15 min	2 - 2 2 2 2 2 2 2 2 2 2 2 2 2 2 2 2 2 2	WD - WD	PT P	POCKET DOOR PREHUNG DOOR + FRAME
201.2B 201.3A 201.3B 201.4 201.5 202.1 202.2A 202.2B 202.3A 202.3B 202.4A 202.4B 202.6 203.1 203.2A 203.2B 203.3A 203.3B 203.4A 203.4B 203.4A 203.4B 203.4A 203.4B 203.4A 203.4B 203.4A 203.4B 203.4B	2' - 10" 2' - 10" 5' - 0" 5' - 0" 5' - 0" 2' - 10" 2' - 10" 2' - 10" 2' - 10" 2' - 10" 5' - 0" 5' - 0" 3' - 0" 2' - 10" 2' - 10" 2' - 10" 2' - 10" 2' - 10" 5' - 0" 5' - 0" 5' - 0" 5' - 0" 5' - 0" 5' - 0" 5' - 0" 5' - 0" 5' - 0" 5' - 0" 5' - 0" 5' - 0" 5' - 0" 5' - 0" 5' - 0" 5' - 0" 5' - 0" 5' - 0"	7' - 0" 7' - 0"	I G H J H C G H J H C G I G H J H C G H C H C H C H C H C H C H H C H H H H	WSC	4 2 5 5 5 1 2 5 3 4 2 5 5 5 1 3 4 2 5 5 5 5 5 5 5 5 5 5 5 5 5 5 5 5 5 5	PT2		15 min	2 - 2 2 2 2 2 2 2 2 2 2 2 2 2 2 2 2 2 2	WD - WD	PT P	POCKET DOOR PREHUNG DOOR + FRAME
201.2B 201.3A 201.3B 201.4 201.5 202.1 202.2A 202.2B 202.3A 202.3B 202.4A 202.4B 202.5 203.1 203.2A 203.2A 203.2B 203.3A 203.3B 203.4A 203.3B 203.4A 203.4B 203.4B 203.4B 203.4B 203.4B 203.4B 203.4B 203.4B 203.4B 203.4B 203.4B 203.4B 203.4B 203.4B 203.4B 203.4B 203.4B	2' - 10" 2' - 10" 5' - 0" 5' - 0" 5' - 0" 3' - 0" 2' - 10" 2' - 10" 2' - 10" 2' - 10" 5' - 0" 5' - 0" 5' - 0" 2' - 10" 2' - 10" 2' - 10" 2' - 10" 2' - 10" 2' - 10" 3' - 0" 2' - 10" 5' - 0" 5' - 0" 5' - 0" 5' - 0" 5' - 0" 5' - 0" 5' - 0" 5' - 0" 5' - 0" 5' - 0" 5' - 0" 5' - 0" 5' - 0" 5' - 0" 5' - 0" 5' - 0" 5' - 0"	7' - 0" 7' - 0"	G	WSC	4 2 5 5 5 1 2 5 3 4 2 5 5 5 1 3 4 2 5 5 5 5 1 2 5 5 5 5 1 2 5 5 5 1 2 5 5 5 5	PT2		15 min	2 - 2 2 2 2 2 2 2 2 2 2 2 2 2 2 2 2 2 2	WD - WD	PT P	POCKET DOOR PREHUNG DOOR + FRAME
201.2B 201.3A 201.3B 201.4 201.5 202.1 202.2A 202.2B 202.3A 202.3B 202.4A 202.4B 202.5 203.1 203.2A 203.2A 203.2B 203.3A 203.3B 203.4A 203.4B 203.4B 203.4B 203.4B 203.4B 203.4B 203.4B 203.4B 203.4B 203.4B 203.4B 203.4B 203.4B 203.4B 203.4B 203.4B 203.4B 203.4B	2' - 10" 2' - 10" 5' - 0" 5' - 0" 5' - 0" 3' - 0" 2' - 10" 2' - 10" 2' - 10" 2' - 10" 5' - 0" 5' - 0" 3' - 0" 2' - 10" 2' - 10" 5' - 0" 5' - 0" 7' - 0" 7' - 0"	G	WSC	4 2 5 5 5 1 2 5 3 4 2 5 5 5 1 3 4 2 5 5 5 5 1 2 5 5 5 5 1 2 5 5 5 1 2 5 5 5 5	PT2			2 - 2 2 2 2 2 2 2 2 2 2 2 2 2 2 2 2 2 2	WD - WD	PT P	POCKET DOOR PREHUNG DOOR + FRAME
201.2B 201.3A 201.3B 201.4 201.5 202.1 202.2A 202.2B 202.3A 202.3B 202.4A 202.4B 202.4B 203.2B 203.2A 203.2B 203.3A 203.3B 203.4A 203.4B 203.4A 203.4B 203.4A 203.4B 203.4B 203.4B 203.4B 203.4B 203.4B 203.4B 203.4B 203.4B 203.5 203.4B 203.4B 203.4B 203.4B 203.4B 203.4B 203.5	2' - 10" 2' - 10" 5' - 0" 5' - 0" 5' - 0" 3' - 0" 2' - 10" 2' - 10" 2' - 10" 2' - 10" 5' - 0" 5' - 0" 3' - 0" 2' - 10" 2' - 10" 2' - 10" 2' - 10" 2' - 10" 5' - 0" 3' - 0" 2' - 10" 5' - 0" 5' - 0" 7' - 0" 7' - 0"	G	WSC	4 2 5 5 5 1 2 5 3 4 2 5 5 5 1 3 4 2 5 5 5 5 1 2 5 5 5 5 1 2 5 5 5 1 2 5 5 5 5	PT2			2 - 2 2 2 2 2 2 2 2 2 2 2 2 2 2 2 2 2 2	WD - WD	PT P	POCKET DOOR PREHUNG DOOR + FRAME
201.2B 201.3A 201.3B 201.4 201.5 202.1 202.2A 202.2B 202.3A 202.3B 202.4A 202.4B 202.5 203.1 203.2A 203.2B 203.3A 203.3B 203.3B 203.4A 203.4B 203.4B 203.4B 203.4B 203.5 203.6 203.7 204.1 204.2A 204.2B 204.2B 204.4A 204.4B 204.4B	2' - 10" 2' - 10" 5' - 0" 5' - 0" 5' - 0" 3' - 0" 2' - 10" 2' - 10" 2' - 10" 2' - 10" 5' - 0" 5' - 0" 3' - 0" 2' - 10" 2' - 10" 2' - 10" 2' - 10" 2' - 10" 5' - 0" 3' - 0" 2' - 10" 5' - 0" 5' - 0" 7' - 0" 7' - 0"	G	WSC	4 2 5 5 5 1 2 5 3 4 2 5 5 5 1 3 4 2 5 5 5 5 1 2 5 5 5 5 1 2 5 5 5 1 2 5 5 5 5	PT2			2 - 2 2 2 2 2 2 2 2 2 2 2 2 2 2 2 2 2 2	WD - WD	PT P	POCKET DOOR PREHUNG DOOR + FRAME
201.2B 201.3A 201.3B 201.4 201.5 202.1 202.2A 202.2B 202.3A 202.3B 202.4A 202.4B 202.5 203.1 203.2A 203.2B 203.3A 203.3B 203.3A 203.4A 203.4B 203.4A 203.4B 203.4B 203.5 203.7 204.1 204.2A 204.2B 204.3 204.4B 204.4B	2' - 10" 2' - 10" 5' - 0" 5' - 0" 5' - 0" 3' - 0" 2' - 10" 2' - 10" 2' - 10" 5' - 0" 5' - 0" 3' - 0" 2' - 10" 2' - 10" 5' - 0" 5' - 0" 7' - 0" 7' - 0"	I G H J H C G H G H J H C G H G H C G H G H J H C G H G H D H H C H H H H H H H H H H H H H H H	WSC	4 2 5 5 5 1 2 5 3 4 2 5 5 5 1 3 4 2 5 5 5 5 1 2 5 5 5 5 1 2 5 5 5 1 2 5 5 5 5	PT2		15 min	2 - 2 2 2 2 2 2 2 2 2 2 2 2 2 2 2 2 2 2	WD - WD	PT P	POCKET DOOR PREHUNG DOOR + FRAME
201.2B 201.3A 201.3B 201.4 201.5 202.1 202.2A 202.2B 202.3A 202.3B 202.4A 202.4B 202.5 202.6 203.1 203.2A 203.2B 203.3A 203.3B 203.4A 203.4B 203.4A 203.4B 203.5 203.6 203.7 204.1 204.2A 204.2B 204.3 204.4A 204.4B 204.4B 204.5	2' - 10" 2' - 10" 5' - 0" 5' - 0" 5' - 0" 2' - 10" 2' - 10" 2' - 10" 2' - 10" 2' - 10" 5' - 0" 5' - 0" 3' - 0" 2' - 10" 2' - 10" 2' - 10" 2' - 10" 5' - 0" 5' - 0" 7' - 0" 7' - 0"	I G H J H C G I G H G H J H C C I H C C I H J C C	WSC	4 2 5 5 5 1 2 5 3 4 2 5 5 5 1 3 4 2 5 5 5 5 5 5 5 5 5 5 5 5 5 5 5 5 5 5	PT2		15 min	2 - 2 2 2 2 2 2 2 2 2 2 2 2 2 2 2 2 2 2	WD	PT P	POCKET DOOR PREHUNG DOOR + FRAME
201.2B 201.3A 201.3B 201.4 201.5 202.1 202.2A 202.2B 202.3A 202.3B 202.4A 202.4B 202.5 203.1 203.2A 203.2B 203.3A 203.3B 203.3A 203.3B 203.4A 203.4B 203.4A 203.4B 203.5 203.6 203.7 204.1 204.2A 204.2B 204.3 204.4A 204.4B 204.4B 204.4B 204.5 THIRD FLOOF 301.1 301.2A 301.2B	2' - 10" 2' - 10" 5' - 0" 5' - 0" 5' - 0" 3' - 0" 2' - 10" 2' - 10" 2' - 10" 5' - 0" 5' - 0" 5' - 0" 2' - 10" 2' - 10" 2' - 10" 2' - 10" 5' - 0" 2' - 10" 5' - 0" 2' - 10" 5' - 0" 2' - 10" 5' - 0" 5' - 0" 7' - 0" 7' - 0"	I G H J H C G I G H G H J H C C I H C C I H J C C	WSC	4 2 5 5 5 1 2 5 3 4 2 5 5 5 5 1 3 4 2 5 5 5 5 5 5 5 5 5 5 5 5 5 5 5 5 5 5	PT2			2 - 2 2 2 2 2 2 2 2 2 2 2 2 2 2 2 2 2 2	WD	PT P	POCKET DOOR PREHUNG DOOR + FRAME
201.2B 201.3A 201.3B 201.4 201.5 202.1 202.2A 202.2B 202.3A 202.3B 202.4A 202.4B 202.5 203.1 203.2A 203.2B 203.3A 203.3B 203.3A 203.3B 203.4A 203.4B 203.4B 203.5 203.6 203.7 204.1 204.2A 204.2B 204.3 204.4B 204.4B 204.4B 204.5 THIRD FLOOF 301.1 301.2A 301.2B 301.3A	2' - 10" 2' - 10" 5' - 0" 5' - 0" 5' - 0" 2' - 10" 2' - 10" 2' - 10" 2' - 10" 2' - 10" 5' - 0" 5' - 0" 3' - 0" 2' - 10" 2' - 10" 2' - 10" 2' - 10" 5' - 0" 5' - 0" 7' - 0" 7' - 0"	I G H J H C G I G H G H J H C C I H J H C C I H C I H J H C C I H C I H J C C I H C I H J C C I H C I H J C C I H C I H J C C I H C I H J C C I H C I H J C C I H C I H J C C I H C I H J C C I I H J C C I I I I I I I I I I I I I I I I I	WSC	4 2 5 5 5 1 2 5 3 4 2 5 5 5 1 3 4 2 5 5 5 5 5 1 2 5 5 5 5 5 5 5 5 5 5 5 5	PT2			2 - 2 2 2 2 2 2 2 2 2 2 2 2 2 2 2 2 2 2	WD	PT P	POCKET DOOR PREHUNG DOOR + FRAME
201.2B 201.3A 201.3B 201.4 201.5 202.1 202.2A 202.2B 202.3A 202.3B 202.4A 202.4B 202.5 203.1 203.2A 203.2A 203.2B 203.3A 203.3B 203.4A 203.4B 203.4B 203.4B 203.4B 203.4B 203.4B 203.4B 203.4B 203.4B 203.4B 203.4B 203.4B 203.5 203.6 203.7 204.1 204.2B 204.2B 204.3 204.4A 204.4B 204.5 THIRD FLOOF 301.1 301.2A 301.3B	2' - 10" 2' - 10" 5' - 0" 5' - 0" 5' - 0" 2' - 10" 2' - 10" 2' - 10" 2' - 10" 2' - 10" 5' - 0" 3' - 0" 2' - 10" 2' - 10" 2' - 10" 5' - 0" 3' - 0" 2' - 10" 5' - 0" 5' - 0" 7' - 0" 7' - 0"	I G H J H C G I G H G H J H C C I H J H C C I H J C C I H C I C I H J C C I H C I C I C I C I C I C I C I C I	WSC	4 2 5 5 5 1 2 5 3 4 2 5 5 5 1 3 4 2 5 5 5 5 1 2 5 5 5 5 5 1 2 5 5 5 5 5 5	PT2			2 - 2 2 2 2 2 2 2 2 2 2 2 2 2 2 2 2 2 2	WD	PT P	POCKET DOOR PREHUNG DOOR + FRAME
201.2B 201.3A 201.3B 201.4 201.5 202.1 202.2A 202.2B 202.3A 202.3B 202.4A 202.4B 202.5 203.1 203.2A 203.2B 203.3A 203.3B 203.3A 203.3B 203.4A 203.4B 203.5 203.6 203.7 204.1 204.2A 204.2B 204.2B 204.3 204.4A 204.4B 204.5 THIRD FLOOF 301.1 301.2A 301.3B 301.3A	2' - 10" 2' - 10" 5' - 0" 5' - 0" 5' - 0" 2' - 10" 2' - 10" 2' - 10" 2' - 10" 2' - 10" 5' - 0" 3' - 0" 2' - 10" 2' - 10" 2' - 10" 2' - 10" 2' - 10" 5' - 0" 3' - 0" 2' - 10" 5' - 0" 5' - 0" 7' - 0" 7' - 0"	I G H J H C G I G H J H C C I H J C G I G H J H C C I H J C C I H J C C I H J C C I H J C C I H J C C I H J C C I H J C C I H C C I H J C C I H J C C I H J C C I H J C C I H J C C I H J C C I I H J C C I I H J C C I I H J C C I I H J C C I I H J C C I I I I I I I I I I I I I I I I I	WSC	4 2 5 5 5 1 2 5 3 4 2 5 5 5 1 3 4 2 5 5 5 5 5 5 5 5 5 5 5 5 5 5 5 5 5 5	PT2			2 - 2 2 2 2 2 2 2 2 2 2 2 2 2 2 2 2 2 2	WD - WD	PT P	POCKET DOOR PREHUNG DOOR + FRAME
201.2B 201.3A 201.3B 201.4 201.5 202.1 202.2A 202.2B 202.3A 202.3B 202.4A 202.4B 202.5 203.1 203.2A 203.2B 203.3A 203.3B 203.3A 203.3B 203.4A 203.4B 203.5 203.6 203.7 204.1 204.2A 204.2B 204.2B 204.3 204.4B 204.2B 204.3 204.4B 204.5 THIRD FLOOF 301.1 301.2A 301.2B 301.3B 301.4	2' - 10" 2' - 10" 5' - 0" 5' - 0" 5' - 0" 2' - 10" 2' - 10" 2' - 10" 2' - 10" 2' - 10" 5' - 0" 5' - 0" 5' - 0" 2' - 10" 2' - 10" 2' - 10" 2' - 10" 2' - 10" 2' - 10" 5' - 0" 5' - 0" 7' - 0" 7' - 0"	I G H J H C G I G H G H J H C C I H J H C G I G H J H C C I H C I H J H C C I H J H C C I H J H L C C I H J H J H C C I H J H L C C I H J H J H L C C I H J H J H L C C I H J H J H L C C I H J H J H L C C I H J H J H L C C I H J H J H L C C I H J H J H L C C I H J H J H L C C I H J J H L C C I H J J H J H L C C I H J J H J H L C C I H J J H J H J H J H J H J H J H J H J	WSC	4 2 5 5 5 1 2 5 3 4 2 5 5 5 1 3 4 2 5 5 5 5 1 2 5 5 5 5 5 1 2 5 5 5 5 5 5	PT2			2 - 2 2 2 2 2 2 2 2 2 2 2 2 2 2 2 2 2 2	WD	PT P	POCKET DOOR PREHUNG DOOR + FRAME
201.2B 201.3A 201.3B 201.4 201.5 202.1 202.2A 202.2B 202.3A 202.3B 202.4A 202.4B 202.5 203.1 203.2A 203.2B 203.3A 203.3B 203.4A 203.4B 203.4B 203.4B 203.4B 203.4B 203.4B 203.4B 203.4B 203.4B 203.4B 203.5 204.1 204.2B 204.2B 204.2B 204.3 204.4A 204.4B 204.5 THIRD FLOOF 301.1 301.2A 301.3B 301.3A 301.3B 301.3B 301.3B 301.5 302.1	2' - 10" 2' - 10" 5' - 0" 5' - 0" 5' - 0" 2' - 10" 2' - 10" 2' - 10" 2' - 10" 5' - 0" 5' - 0" 5' - 0" 5' - 0" 2' - 10" 2' - 10" 2' - 10" 2' - 10" 2' - 10" 2' - 10" 5' - 0" 5' - 0" 7' - 0" 7' - 0"	G	WSC	4 2 5 5 5 1 2 5 3 4 2 5 5 5 1 3 4 2 5 5 5 5 1 2 5 5 5 5 5 1 2 5 5 5 5 5 5	PT2			2 - 2 2 2 2 2 2 2 2 2 2 2 2 2 2 2 2 2 2	WD	PT P	POCKET DOOR PREHUNG DOOR + FRAME
201.2B 201.3A 201.3B 201.4 201.5 202.1 202.2A 202.2B 202.3A 202.3B 202.4A 202.4B 202.5 203.1 203.2A 203.2B 203.3A 203.3B 203.3A 203.4A 203.4B 203.5 203.6 203.7 204.1 204.2A 204.2B 204.3 204.4A 204.4B 204.5 THIRD FLOOF 301.1 301.2A 301.2A 301.3B 301.3A 301.3B 301.3B 301.4 301.5 302.1	2' - 10" 2' - 10" 5' - 0" 5' - 0" 5' - 0" 2' - 10" 2' - 10" 2' - 10" 2' - 10" 2' - 10" 5' - 0" 5' - 0" 3' - 0" 2' - 10" 2' - 10" 2' - 10" 2' - 10" 5' - 0" 5' - 0" 7' - 0" 7' - 0"	I G H J H C G H G H J H C C H C I H J H C G H G H J H C C G H C I H J C G G H C G G H C G G H C G G G G G G G	WSC	4 2 5 5 5 1 2 5 3 4 2 5 5 5 1 3 4 2 5 5 5 5 5 5 5 5 5 5 5 5 5 5 5 5 5 5	PT2			2 - 2 2 2 2 2 2 2 2 2 2 2 2 2 2 2 2 2 2	WD - WD	PT P	POCKET DOOR PREHUNG DOOR + FRAME
201.2B 201.3A 201.3B 201.4 201.5 202.1 202.2A 202.2B 202.3A 202.3B 202.4A 202.4B 202.5 203.1 203.2A 203.2B 203.3A 203.3B 203.4A 203.4B 203.4A 203.4B 203.5 203.6 203.7 204.1 204.2A 204.2B 204.3 204.4B 204.2B 204.3 204.4B 204.3 204.4B 204.5 THIRD FLOOF 301.1 301.2A 301.2B 301.3A 301.2B 301.3A 301.2B 301.3A 301.2B 302.2A 302.2B	2' - 10" 2' - 10" 5' - 0" 5' - 0" 5' - 0" 2' - 10" 2' - 10" 2' - 10" 2' - 10" 2' - 10" 5' - 0" 5' - 0" 5' - 0" 2' - 10" 2' - 10" 2' - 10" 2' - 10" 2' - 10" 5' - 0" 5' - 0" 7' - 0" 7' - 0"	I G H J H C G H G H J H C C I H J H C G D D	WSC	4 2 5 5 5 1 2 5 3 4 2 5 5 5 1 3 4 2 5 5 5 5 5 5 5 5 5 5 5 5 5 5 5 5 5 5	PT2			2 - 2 2 2 2 1 2 2 2 2 2 2 2 2 2 2 2 2 2	WD	PT P	POCKET DOOR PREHUNG DOOR + FRAME
201.2B 201.3A 201.3B 201.4 201.5 202.1 202.2A 202.2B 202.3A 202.3B 202.4A 202.4B 202.5 203.1 203.2A 203.2B 203.3A 203.3B 203.3A 203.4A 203.4B 203.5 203.6 203.7 204.1 204.2A 204.2B 204.3 204.4B 204.4B 204.5 THIRD FLOOF 301.1 301.2A 301.2B 301.3B 301.3B 301.3B 301.3B 301.3B 301.4 301.5 302.1	2' - 10" 2' - 10" 5' - 0" 5' - 0" 5' - 0" 2' - 10" 2' - 10" 2' - 10" 2' - 10" 2' - 10" 5' - 0" 5' - 0" 3' - 0" 2' - 10" 2' - 10" 2' - 10" 2' - 10" 5' - 0" 5' - 0" 7' - 0" 7' - 0"	I G H J H C G H G H J H C C H C I H J H C G H G H J H C C G H C I H J C G G H C G G H C G G H C G G G G G G G	WSC	4 2 5 5 5 1 2 5 3 4 2 5 5 5 1 3 4 2 5 5 5 5 5 5 5 5 5 5 5 5 5 5 5 5 5 5	PT2			2 - 2 2 2 2 2 2 2 2 2 2 2 2 2 2 2 2 2 2	WD - WD	PT P	POCKET DOOR PREHUNG DOOR + FRAME

						DOOR SCHED	ULE - ALL					
DOOR						DOOR			FRAME			
NO.	WIDTH	HEIGHT	Door Type	Door Material	Hardware	FINISH	GLASS TYPE	FIRE RATING	TYPE	MATERIAL	FINISH	COMMENTS
302.4B	5' - 0"	7' - 0"	Н	WSC	5	PT2	_	-	2	WD	PT	PREHUNG DOOR + FRAME
302.5	5' - 0"	7' - 0"	J	WSC	5	PT2	-	-	2	WD	PT	PREHUNG DOOR + FRAME
302.6	5' - 0"	7' - 0"	Н	WSC	5	PT2	-	-	2	WD	PT	PREHUNG DOOR + FRAME
303.1	3' - 0"	7' - 0"	С	WC	1	PT2	-	15 min.	1	НМ	PT2	PREHUNG DOOR + FRAME
303.2A	2' - 10"	7' - 0"	G	WSC	4	PT2	-	-	2	WD	PT	PREHUNG DOOR + FRAME
303.2B	2' - 10"	7' - 0"	I	WSC	4	PT2	-	-	-	-	-	POCKET DOOR
303.3A	2' - 10"	7' - 0"	G	WSC	2	PT2	-	-	2	WD	PT	PREHUNG DOOR + FRAME
303.3B	5' - 0"	7' - 0"	Н	WSC	5	PT2	-	-	2	WD	PT	PREHUNG DOOR + FRAME
303.4A	2' - 10"	7' - 0"	G	WSC	2	PT2	-	-	2	WD	PT	PREHUNG DOOR + FRAME
303.4B	5' - 0"	7' - 0"	Н	WSC	5	PT2	-	-	2	WD	PT	PREHUNG DOOR + FRAME
303.5	5' - 0"	7' - 0"	J	WSC	5	PT2	-	-	2	WD	PT	PREHUNG DOOR + FRAME
303.6	5' - 0"	7' - 0"	Н	WSC	5	PT2	-	-	2	WD	PT	PREHUNG DOOR + FRAME
303.7	5' - 0"	7' - 0"	Н	WSC	5	PT2	-	-	2	WD	PT	PREHUNG DOOR + FRAME
304.1	3' - 0"	7' - 0"	С	WC	1	PT2	-	15 min.	1	НМ	PT2	PREHUNG DOOR + FRAME
304.2A	3' - 0"	7' - 0"	С	WSC	2	PT2	-	-	2	WD	PT	PREHUNG DOOR + FRAME
304.2B	5' - 0"	7' - 0"	Н	WSC	5	PT2	-	-	2	WD	PT	PREHUNG DOOR + FRAME
304.3	3' - 0"	7' - 0"	С	WSC	4	PT2	-	-	2	WD	PT	PREHUNG DOOR + FRAME
304.4A	2' - 10"	7' - 0"	I	WSC	4	PT2	-	-	-	-	-	POCKET DOOR
304.4B	5' - 0"	7' - 0"	Н	WSC	5	PT2	-	-	2		PT	PREHUNG DOOR + FRAME
304.5	5' - 0"	7' - 0"	J	WSC	5	PT2	-	-	2	WD	PT	PREHUNG DOOR + FRAME

DOOR HARDWARE SETS **GENERAL NOTE:** SET # DESCRIPTION COMPONENTS (PER DOOR LEAF) QUANTITY SET # DESCRIPTION COMPONENTS (PER DOOR LEAF) QUANTITY PATIO DOOR MANUFACTURERS STANDARD HARDWARE UNIT ENTRY HINGES DOORS MORTISE LOCKSET WITH KEYED LOCKING MECHANISM FROM CONTINUOUS SEAL EXTERIOR MORTISE DROPDOWN SWEEP ALUM. SADDLE THRESHOLD JAMB MOUNT CLOSER DOOR SWEEP DOOR STOP 10. STAIR DOOR HINGES PASSAGE HINGES (APARTMENTS) PASSAGE LOCKSET TO BASEMENT STOREFRONT LOCKSET** DOOR SILENCER DOOR STOP DOOR STOP CLOSER CONTINUOUS SMOKE SEAL PRIVACY (APARTMENTS) PASSAGE LOCKSET 11. STAIR ENTRY CONTINUOUS HINGE DOOR SILENCER DOOR -EXTERIOR LOCKSET/LEVER GL-3 FIRE RATED GLASS PANIC DEVICE STAIR SIDE DOOR STOP DOOR CLOSER POCKET STANDARD POCKET DOOR HARDWARE CONTINUOUS WEATHERSTRIPPING (APARTMENTS) ALUM. SADDLE THRESHOLD DOOR SWEEP STANDARD SLIDING DOOR HARDWARE SLIDING PAINTED - PREFINISHED PT2 PAINTED - FIELD PAINTED (APARTMENTS) STL STEEL 12. COMMERCIAL CONTINUOUS HINGE EXTERIOR LOCKSET/LEVER 6. STOREFRONT HINGES STOREFRONT LOCKSET EXTERIOR PULL PANIC DEVICE STAIR SIDE DOOR SILENCER DOOR CLOSER DOOR STOP CONTINUOUS WEATHERSTRIPPING PASSAGE ALUM. SADDLE THRESHOLD HINGES DOOR SWEEP STOREFRONT LOCKSET PATHWAY FOR FUTURE ELEC. DOOR SILENCER DOOR STOP CONNECTIONS 13. FENCE GATE STANDARD GATE DOOR HARDWARE DOOR 8. STOREFRONT CONTINUOUS HINGES EXTERIOR LOCKSET/LEVER W/ ELEC. LATCH RETRACTION PANIC DEVICE DOOR CLOSER CONTINUOUS WEATHERSTRIPPING (EXT DOORS) ALUM. SADDLE THRESHOLD (EXT DOORS) **FREE EGRESS FROM BASEMENT SIDE DOOR SWEEP (EXTERIOR DOORS) DOOR STOP ***BASIS OF DESIGN (TO BE MODIFIED FOR ELECTRIFIED DOOR STRIKE (EXT. FUTURE TENANT NEEDS) BUZZER INTERCOM*

*TIE INTO DOOR STRIKE

A-801 1/4" = 1'-0"

1. REFER TO LS-01 FOR ENERGY CODE REQUIREMENTS

DOOR/ FRAME FINISH LEGEND

1 PRIMED AND PAINTED - COLOR BY ARCHITECT 2 STAIN AND CLEAR COAT - FINISH BY ARCHITECT

GLAZING TYPES

GL-1 3/16" CLEAR CERAMIC FIRE RATED SAFETY GLASS GL-2 1" INSULATED GLAZING UNIT W/ ARGON GAS AND FULLY TEMPERED


WSC WOOD - SOLID CORE WC WOOD COMPOSITE

HM HOLLOW METAL ALUM ALUMINUM CLR CLEAR ANODIZED

GENERAL DOOR/ FRAME/ HARDWARE NOTES

- HARDWARE MFR AND PRODUCTS T.B.D. REFER TO HARDWARE SETS FOR GENERAL DESCRIPTION OF HARDWARE FUNCTION AND COMPONENTS. SUCCESSFUL BIDDER ON DOOR HARDWARE SCOPE OF WORK TO SUBMIT HARDWARE SETS AND PRODUCT DATA FOR REVIEW AND APPROVAL BY ARCHITECT, OWNER AND CONSTRUCTION MANAGER.
- 2. ALL HARDWARE TO BE ADA & BCNYS COMPLIANT.
- 3. UNIT ENTRY DOORS TO RECEIVE HARDWARE WITH A DEADBOLT INTERCONNECTED WITH THE DOOR LEVER TO ALLOW FOR EGRESS.
- 4. ALL FIRE RATED DOORS TO BE ADEQUATELY SMOKE SEALED PER BCNYS REQUIREMENTS.
- 5. ALL FIRE RATED DOORS TO BE SELF CLOSING/LATCHING
- 6. PROVIDE MAGNETIC HOLD OPENS TIED INTO FIRE ALARM, DOOR TO CLOSE UPON ACTIVATION OF
- 7. DOORS SERVING EGRESS FROM ANY SPACE SHALL NOT LOCK OR PREVENT EXITING FROM THE
- 8. ALL GLAZING WITHIN 'HAZARDOUS LOCATIONS' REQUIRE SAFETY GLAZING.


A-801 1/4" = 1'-0"

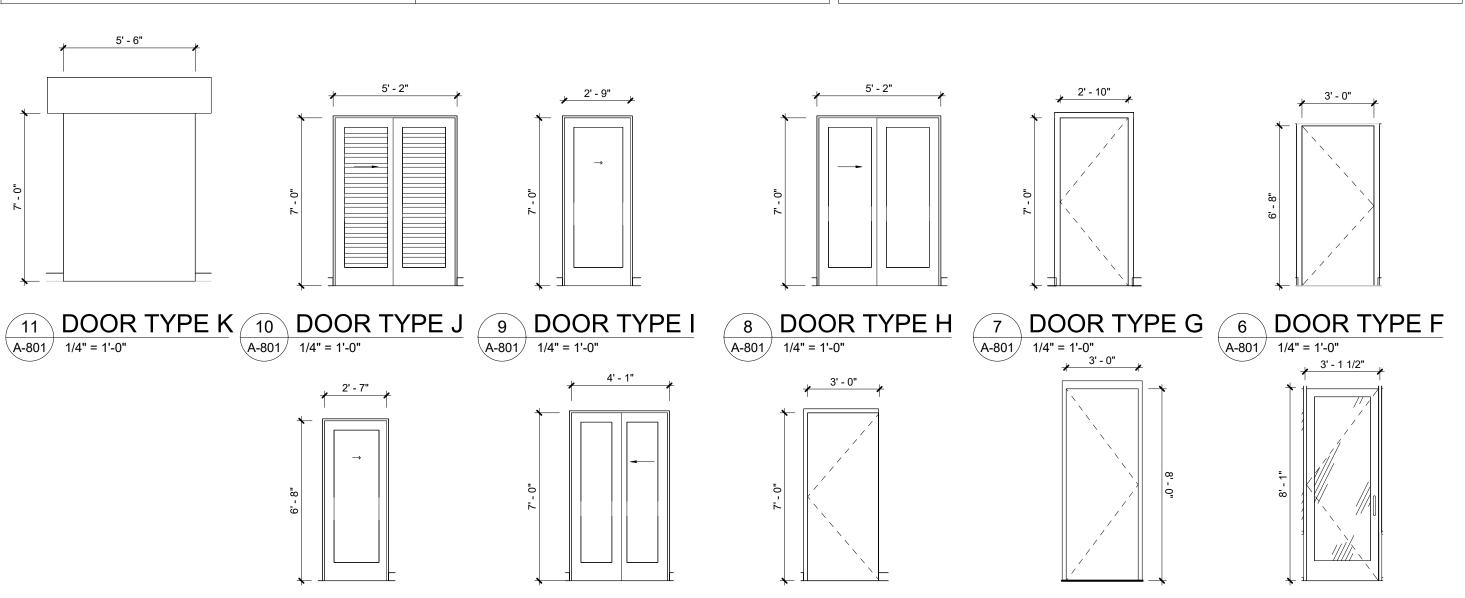


5 DOOR TYPE E 4 DOOR TYPE D 3 DOOR TYPE C 2 DOOR TYPE B 1

A-801 1/4" = 1'-0"



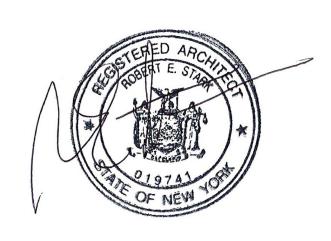

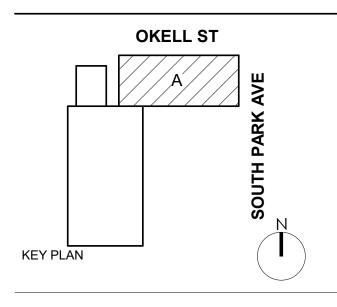

DOFI PROPERTIES

SOUTH PARK MIXED USE

2221 SOUTH PARK AVE BUFFALO, NY 14220

DESCRIPTION DATE

JOB NO.	2508
SCALE	1/4" = 1'-0"
ISSUE DATE	08/04/25
DRAWN BY	Gac
CHECKED BY	JMC
THIS IS A SINGLE SHEET OF A COHESIVE	

SET OF CONSTRUCTION DOCUMENTS
(INCLUDING DRAWINGS AND SPECIFICATIONS).
INTERPRETATION OF THE INFORMATION AS PRESENTED SHOULD BE BASED ON THE ENTIRE SET OF DOCUMENTS.

DRAWING TITLE

DOOR TYPE A

DOOR SCHEDULE


A-801


				Wir	ndow Sc	hedule			
Mark	Type Mark	Head Height	Sill Height	Nominal Height	Nominal Width	Rough Height	Rough Width	Glass Type	Comment
FIRST FLOO	OR								
100	W1	8' - 0"	6' - 0"			2' - 0 1/2"	3' - 0 1/2"		
101	W8	8' - 5 1/2"	6' - 0"			2' - 6"	4' - 0"		
102	W1	7' - 4"	5' - 4"			2' - 0 1/2"	3' - 0 1/2"		
103	W1	7' - 4"	5' - 4"			2' - 0 1/2"	3' - 0 1/2"		
104	W1	8' - 0"	6' - 0"			2' - 0 1/2"	3' - 0 1/2"		
SECOND FL									
200	W5	8' - 1"	1' - 5"			6' - 8 1/2"	3' - 3 1/2"		
201	W5	8' - 1"	1' - 5"			6' - 8 1/2"	3' - 3 1/2"		
202	W5	8' - 1"	1' - 5"			6' - 8 1/2"	3' - 3 1/2"		
203.1	W4	8' - 1"	2' - 8"			5' - 5 1/2"	2' - 5 1/2"		
203.2	W4	8' - 1"	2' - 8"			5' - 5 1/2"	2' - 5 1/2"		
203.3	W4	8' - 1"	2' - 8"			5' - 5 1/2"	2' - 5 1/2"		
203.4	W4	8' - 1" 8' - 1"	2' - 8" 2' - 8"			5' - 5 1/2" 5' - 5 1/2"	2' - 5 1/2" 2' - 5 1/2"		
204.1	W4	8' - 1"	2' - 8"						
204.2 204.3	W4 W4	8' - 1"	2' - 8"			5' - 5 1/2" 5' - 5 1/2"	2' - 5 1/2" 2' - 5 1/2"		
204.3 204.4	W4	8' - 1"	2' - 8"			5' - 5 1/2"	2' - 5 1/2"		
204.4	W2	8' - 1"	1' - 7"			6' - 6 1/2"	3' - 3 1/2"		
206	W2	8' - 1"	1' - 7"			6' - 6 1/2"	3' - 3 1/2"		
207	W2	8' - 1"	1' - 7"			6' - 6 1/2"	3' - 3 1/2"		
208	W3	8' - 1"	2' - 7"			5' - 6 1/2"	4' - 2 1/2"		
209	W5	8' - 3"	1' - 7"			6' - 8 1/2"	3' - 3 1/2"		
210	W5	8' - 3"	1' - 7"			6' - 8 1/2"	3' - 3 1/2"		
211	W6	8' - 0 1/2"	2' - 8 1/2"			5' - 4 1/2"	3' - 3 1/2"		
212	W5	8' - 1"	1' - 5"			6' - 8 1/2"	3' - 3 1/2"		
213	W6	8' - 0 1/2"	2' - 8 1/2"			5' - 4 1/2"	3' - 3 1/2"		
214	W7	8' - 1"	1' - 5"			6' - 8 1/2"	4' - 2 1/2"		
THIRD FLO	OR	•		•					
300	W5	8' - 3"	1' - 7"			6' - 8 1/2"	3' - 3 1/2"		
301	W5	8' - 3"	1' - 7"			6' - 8 1/2"	3' - 3 1/2"		
302	W5	8' - 3"	1' - 7"			6' - 8 1/2"	3' - 3 1/2"		
303.1	W4	8' - 1 3/4"	2' - 8 3/4"			5' - 5 1/2"	2' - 5 1/2"		
303.2	W4	8' - 1 3/4"	2' - 8 3/4"			5' - 5 1/2"	2' - 5 1/2"		
303.3	W4	8' - 1 3/4"	2' - 8 3/4"			5' - 5 1/2"	2' - 5 1/2"		
303.4	W4	8' - 1 3/4"	2' - 8 3/4"			5' - 5 1/2"	2' - 5 1/2"		
304.1	W4	8' - 3"	2' - 10"			5' - 5 1/2"	2' - 5 1/2"		
304.2	W4	8' - 3"	2' - 10"	-		5' - 5 1/2"	2' - 5 1/2"		
304.3	W4	8' - 3"	2' - 10"			5' - 5 1/2"	2' - 5 1/2"		
304.4	W4	8' - 3"	2' - 10"			5' - 5 1/2"	2' - 5 1/2"		
305	W2	8' - 1"	1' - 7"	-		6' - 6 1/2"	3' - 3 1/2"		
306 307	W2 W2	8' - 1" 8' - 1"	1' - 7" 1' - 7"			6' - 6 1/2" 6' - 6 1/2"	3' - 3 1/2" 3' - 3 1/2"		
30 <i>7</i> 308	W3	8' - 1"	2' - 7"			5' - 6 1/2"	4' - 2 1/2"		
309	W2	8' - 1"	1' - 7"	+		6' - 6 1/2"	3' - 3 1/2"		
310	W5	8' - 3"	1' - 7"	+		6' - 8 1/2"	3' - 3 1/2"		
311	W5	8' - 3"	1' - 7"			6' - 8 1/2"	3' - 3 1/2"		
312	W6	8' - 2 1/2"	2' - 10 1/2"	+		5' - 4 1/2"	3' - 3 1/2"		
313	W5	8' - 3"	1' - 7"			6' - 8 1/2"	3' - 3 1/2"		
314	W6	8' - 2 1/2"	2' - 10 1/2"			5' - 4 1/2"	3' - 3 1/2"		
315	W7	8' - 3"	1' - 7"			6' - 8 1/2"	4' - 2 1/2"		

GENERAL WINDOW NOTES

- 1. ALL PROPOSED WINDOW DETAILS ARE DRAWN BY WINDOW MFR WEATHER SHIELD (BASIS OF DESIGN). ALL PROPOSED WINDOWS TO BE FROM MFR'S 'PREMIUM SERIES' - ALUM CLAD WOOD WINDOWS WITH FACTORY AAMA 2605 FINISH ON THE EXTERIOR. INTERIOR TO BE PINE FACTORY PRIMED & PAINTED, COLOR TBD BY ARCHITECT.
- DRAWINGS ARE FOR COMPARING WINDOW PROFILES ONLY AND DOES NOT DETAIL METHOD FOR ATTACHMENT INTO ADJACENT CONSTRUCTION. COORDINATE WITH WINDOW MFR FOR ALL BUILDING CONSTRUCTION
- REFER TO LS-01 FOR ENERGY CODE REQUIREMENTS



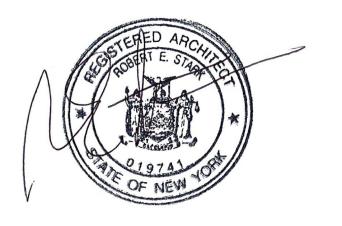

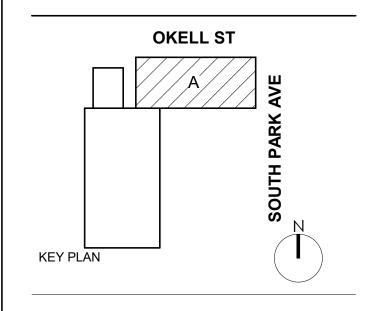

DOFI PROPERTIES

- J BEAD

1/2" SOLID SURFACE WINDOW SILL

- J BEAD

3' - 5 1/2"

SHIM, BACKER ROD + SEALANT

SOUTH PARK MIXED USE

2221 SOUTH PARK AVE BUFFALO, NY 14220

REV.#	DESCRIPTION	DATE

2508	JOB NO.	IG SECTION DETAIL	8 DOUBLE HUN
As indicated	SCALE		A-805 1 1/2" = 1'-0"
08/04/25	ISSUE DATE		
Gac	DRAWN BY		
JMC	CHECKED BY		01 01
ON DOCUMENTS ND SPECIFICATIONS). THE INFORMATION	THIS IS A SINGLE SHEET SET OF CONSTRUCTIOI (INCLUDING DRAWINGS ANI INTERPRETATION OF TH AS PRESENTED SHOULI	3' - 5 1/2"	3'-3"

THE ENTIRE SET OF DOCUMENTS.

DRAWING TITLE


WINDOW SCHEDULE, TYPES + DETAILS


A-805


J BEAD SHIM, BACKER ROD + SEALANT	J BEAD
J BEAD	SHIM, BACKER ROD + SEALANT







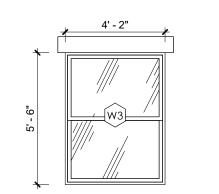


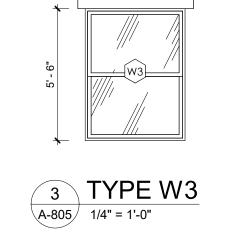


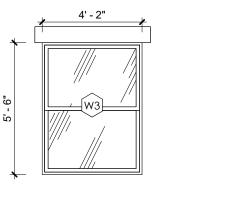

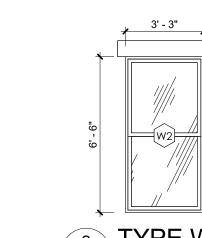


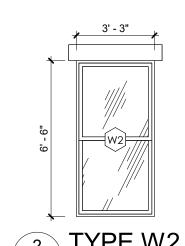


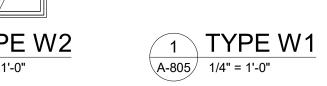


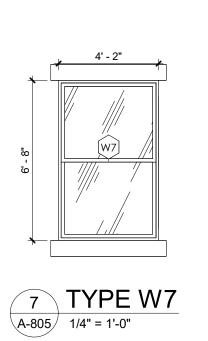



11 AWNING PLAN DETAIL
A-805 1 1/2" = 1'-0"

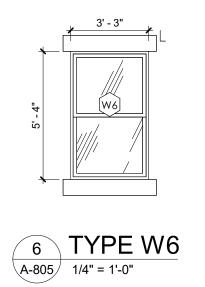

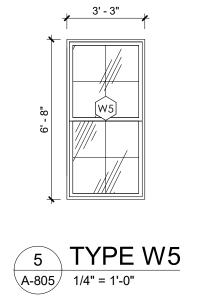

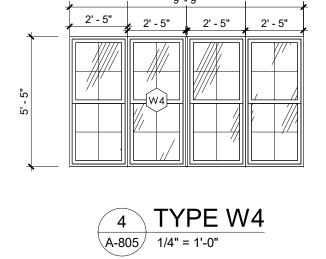


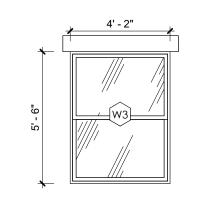


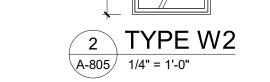

- 1. ALL EXTERIOR GLAZING TO BE 1" THICK INSULATED GLAZING, ARGON FILLED,
- W/ LOW-E- COATING
 REFER TO LS-01 FOR ENERGY CODE REQUIREMENTS
 UTILIZE TEMPERED GLAZING IN HAZARDOUS LOCATIONS (ADJACENT TO DOORS + WITHIN 18" OFA WALKING SURFACE).



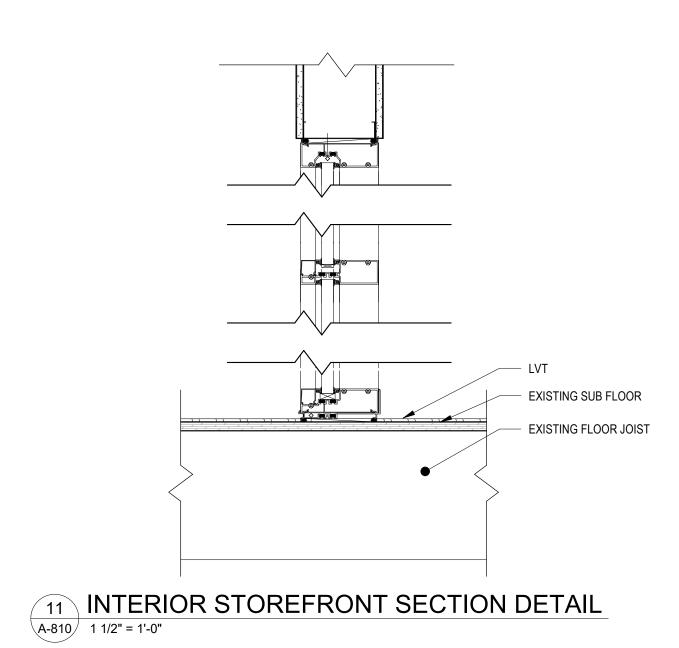


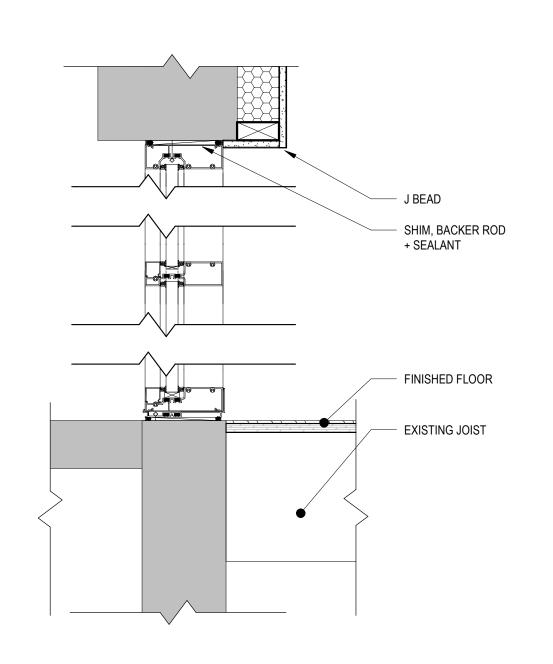




3' - 1 1/2" EQ.

8 STOREFRONT 08 A-810 1/4" = 1'-0"

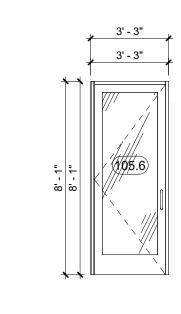




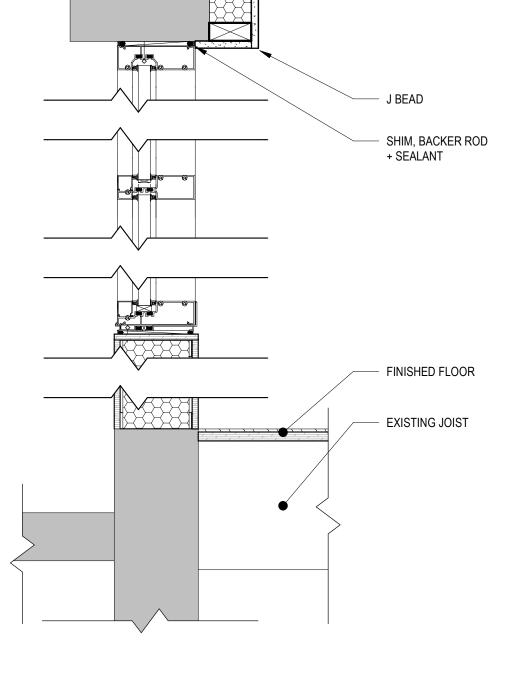


9 EXTERIOR STOREFRONT SECTION DETAIL 1
A-810 1 1/2" = 1'-0"



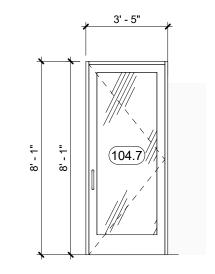


6 STOREFRONT 06 A-810 1/4" = 1'-0"

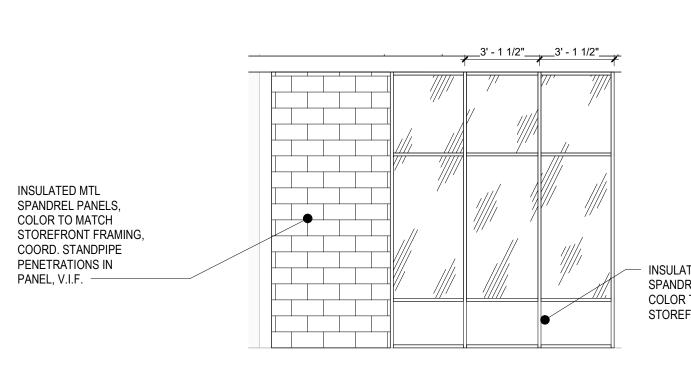


A-810 1/4" = 1'-0"


5 STOREFRONT 05

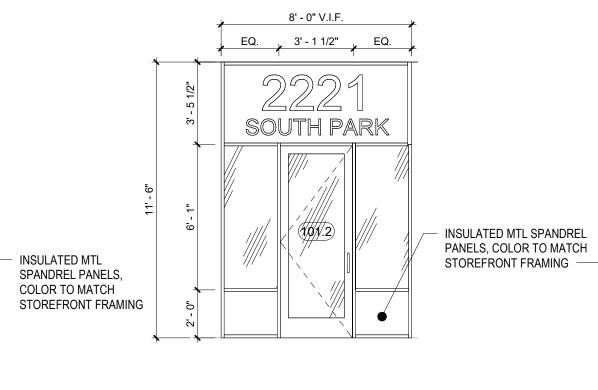


A-810 1/4" = 1'-0"


4 STOREFRONT 04

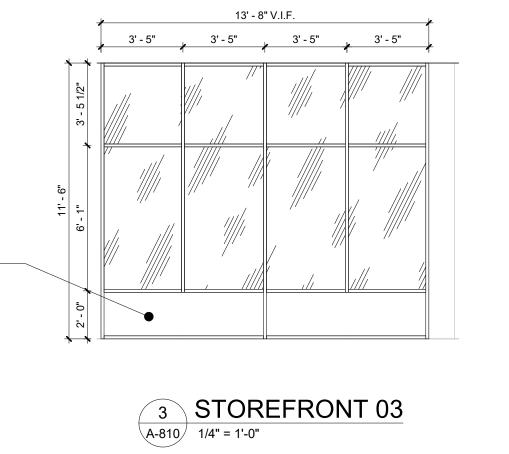


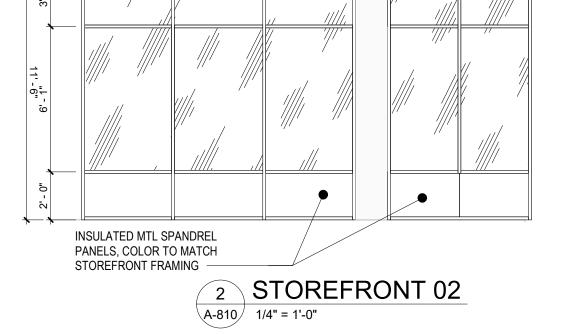

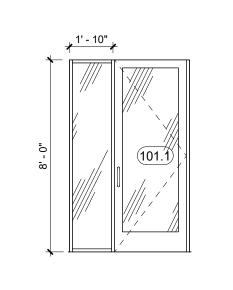

1 STOREFRONT 01 A-810 1/4" = 1'-0"

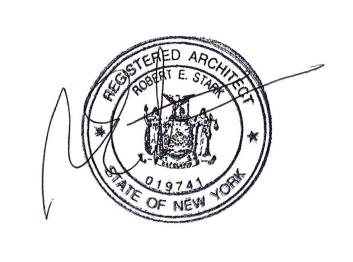

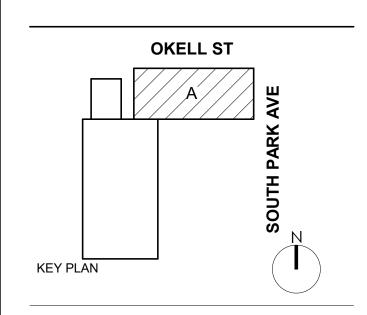

DOFI PROPERTIES

SOUTH PARK MIXED USE

2221 SOUTH PARK AVE BUFFALO, NY 14220

DATE REV.# DESCRIPTION

JOB N	10.		250
SCAL	E	As indi	cate
ISSUE	DATE	08/	04/2
DRAV	VN BY		Ga
CHEC	CKED BY		JM
	THIS IS A SINGLE SHEET SET OF CONSTRUCTIO (INCLUDING DRAWINGS AN INTERPRETATION OF TH	N DOCUMENTS D SPECIFICATIONS).	

AS PRESENTED SHOULD BE BASED ON THE ENTIRE SET OF DOCUMENTS.

DRAWING TITLE

STOREFRONT TYPES AND **DETAILS**

A-810