

DEMOLITION KEYNOTES:

- 1. COMPONENTS OF THE ROOF SYSTEM HAS BEEN IDENTIFIED AS ASBESTOS CONTAINING MATERIAL AND ANY REMOVALS ARE TO BE COORDINATED WITH THE HAZARDOUS MATERIAL DRAWINGS. THE ENTIRE ROOF SYSTEM, ANY PIPE PENETRATIONS, ROOF DRAINS, AND EXISTING WOOD DECKING TO BE REMOVED AND PROPERLY DISPOSED OF IN THEIR ENTIRETY.
- 2. EXISTING ASPHALT SHINGLE ROOF TO BE REMOVED DOWN TO EXISTING ROOF SHEATHING AND PROPERLY DISPOSED OF IN ITS ENTIRETY.
- 3. REMOVE AND PROPERLY DISPOSE OF ALL GUTTERS AND DOWNSPOUTS IN THEIR
- 4. EXISTING CAMELBACK COPING TO REMAIN TO THE FULLEST EXTENT POSSIBLE. CAREFULLY REMOVE CAMELBACK UNITS WHERE THE EXTERIOR WALL IS TO BE RECONSTRUCTED FOR REINSTALLATION.
- 5. EXISTING MASONRY CHIMNEY TO REMAIN.



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CERTIFICATE OF AUTHORIZATION NUMBER: PROFESSIONAL ENGINEERING: 018281 LAND SURVEYING: 017976 GEOLOGICAL: 018750

It is a violation of New York Education Law Art. 145 Sec. 7209 & Art. 147 Sec. 7307, for any person, unless acting under the direction of a licensed architect, professional engineer, or land surveyor, to alter an item in any way. If an item bearing the seal of an architect, engineer, or land surveyor is altered; the altering architect, engineer, or land surveyor shall affix to the item their seal and notation "altered by" followed by their signature and date of such alteration, and a specific description of the alteration.

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5795 LEWISTON ROAD NIAGARA UNIVERSITY, NEW YORK 14109





EDA PROJECT No. 01-01-15369 HUD PROJECT No. B-23-CP-NY-1083 NEW YORK STATE OF OPPORTUNITY. Development

ESD PROJECT No. 135,035

ACADEMIC INNOVATION HUB - WORK FORCE DEVELOPMENT TRAINING

822 CLEVELAND AVENUE NIAGARA FALLS, NEW YORK 14305

NO:	DATE:	DESCRIPTION:
Revisions		
PROJECT I	NUMBER:	2221723
DRAWN B	Y:	JMR
REVIEWED	BY:	TBD
ISSUED FO	DR:	BID
DATE:		APRIL 11, 2024

ROOF DEMOLITION PLAN


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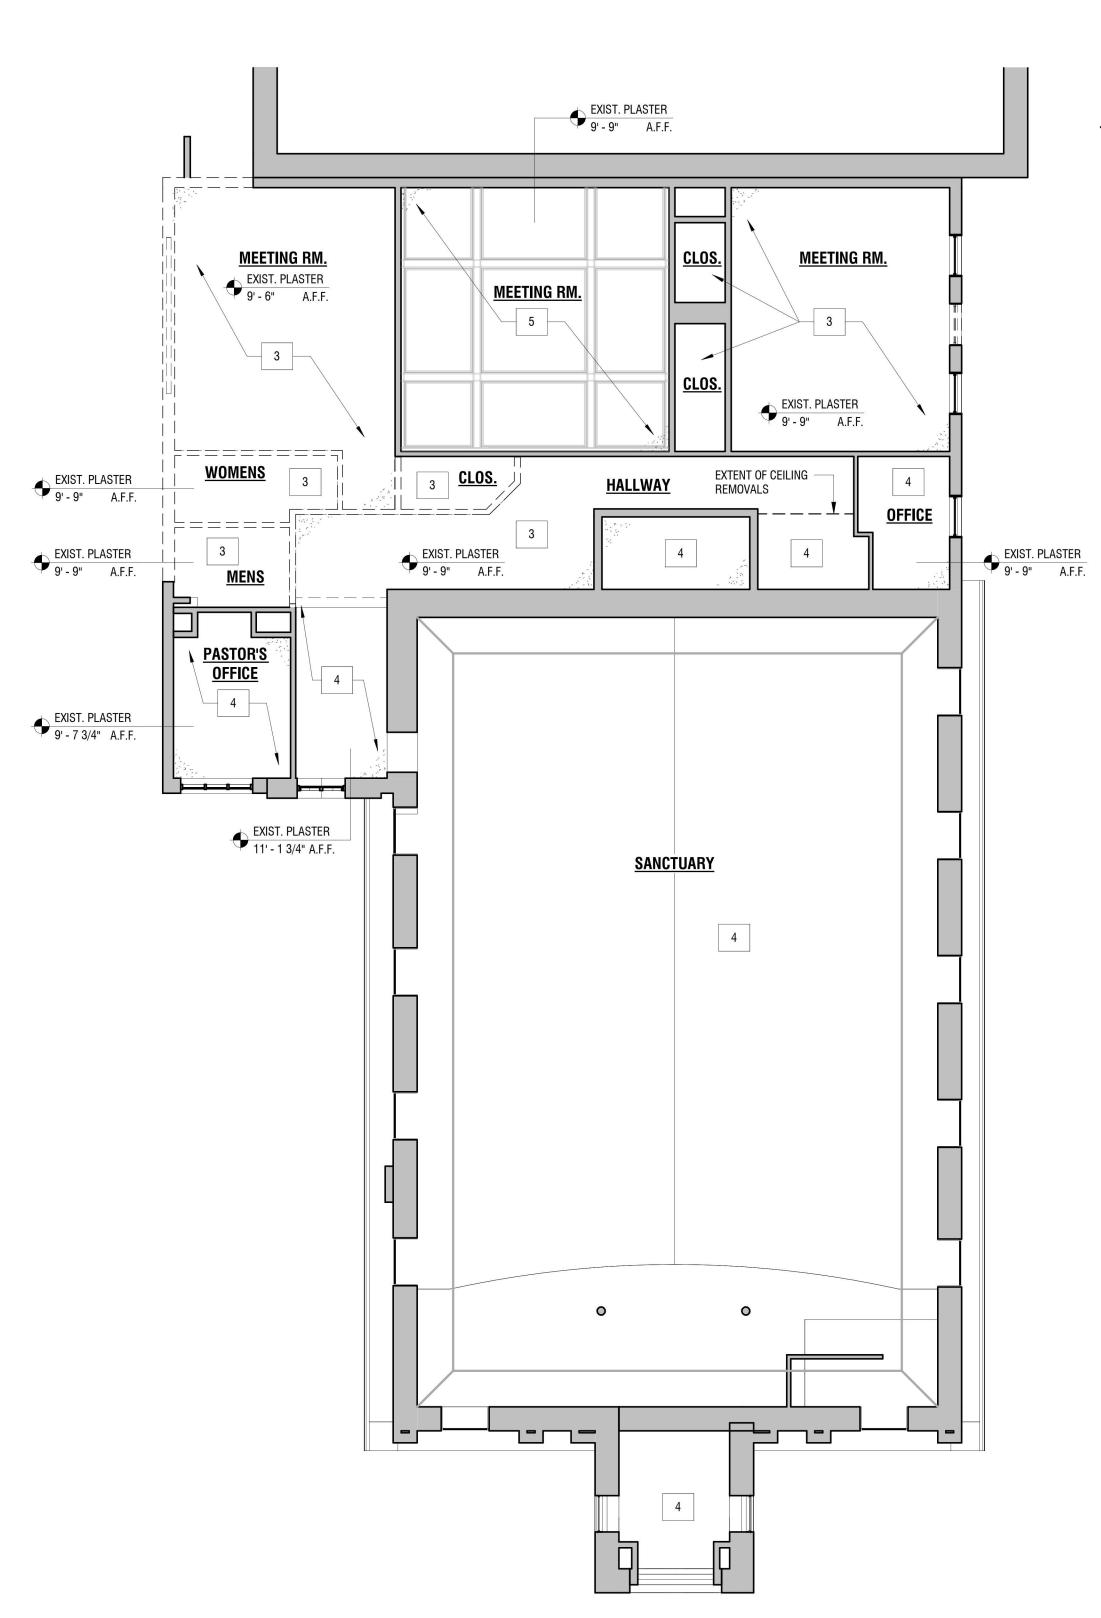
DRAWING NAME:

AD103

DEMOLITION ROOF PLAN

1/8" = 1'-0"



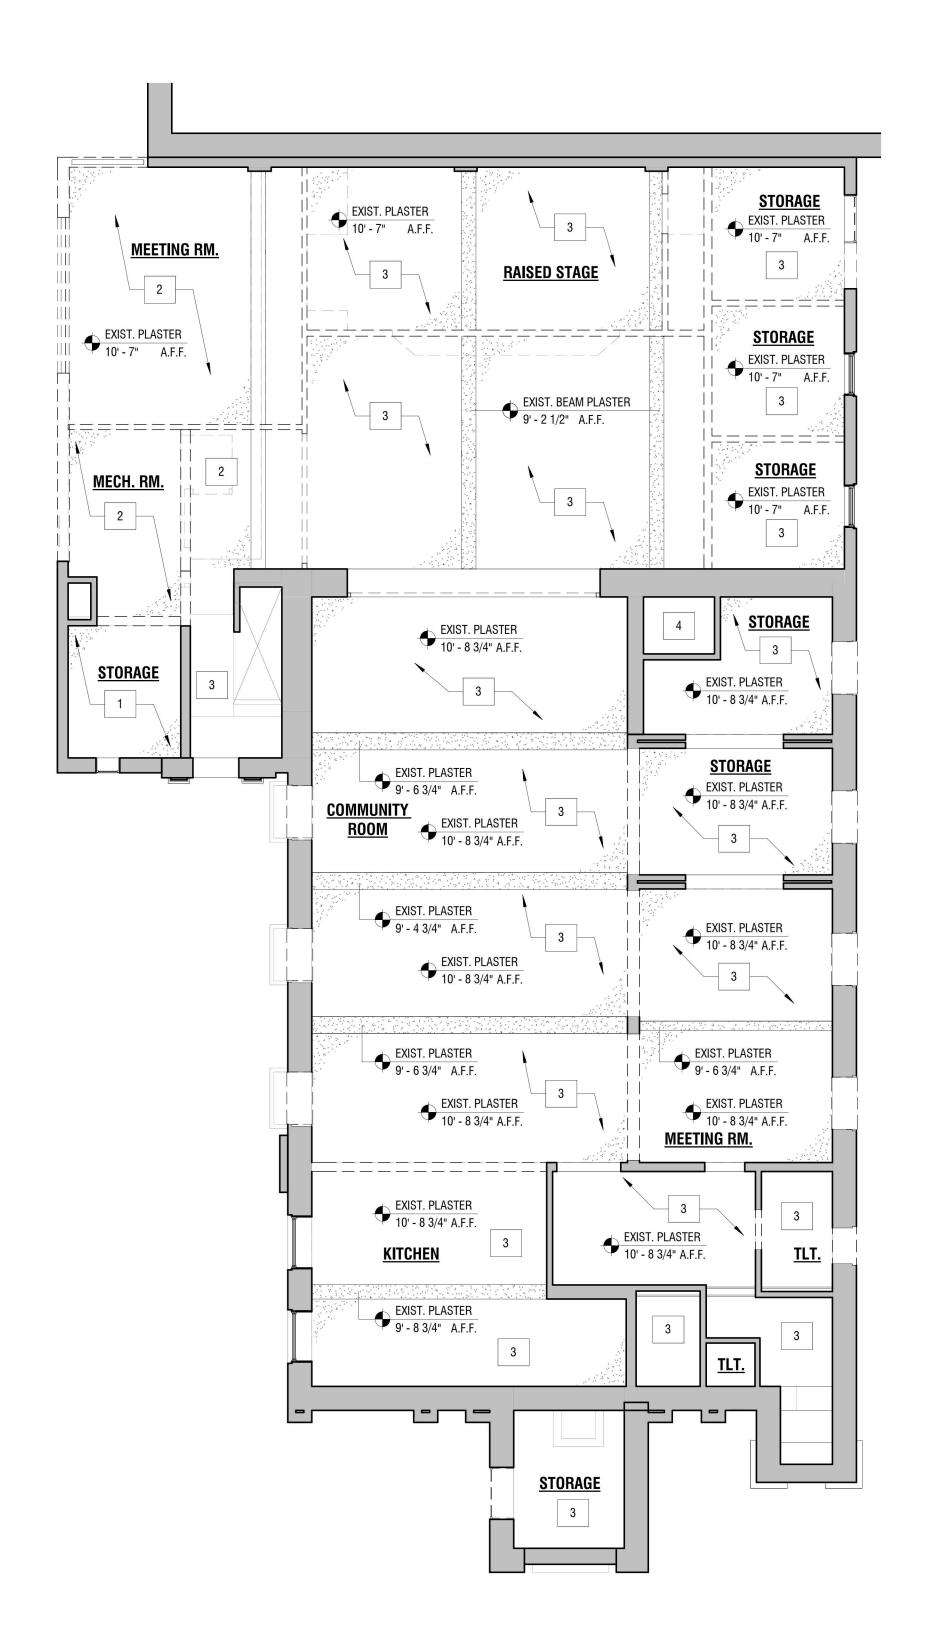

1 LOWER LEVEL REFLECTED CEILING DEMOLITION PLAN

1/8" = 1'-0"

MAIN LEVEL REFLECTED CEILING DEMOLITION PLAN AD111 SCALE: 1/8" = 1'-0"



- 1. DEMOLISH AND PROPERLY DISPOSE OF EXISTING PLASTER AND LATH CEILING TO EXPOSE UNDERSIDE OF FLOOR JOIST FRAMING. COMPLETELY REMOVE EXISTING FASTENERS WHERE FLOOR FRAMING IS TO REMAIN. COORDINATE REMOVALS
- FASTENERS WHERE FLOOR FRAMING IS TO REMAIN. COORDINATE REMOVALS
- 3. DEMOLISH AND PROPERLY DISPOSE OF EXISTING PLASTER AND LATH CEILING TO EXPOSE FLOOR/ROOF FRAMING. COMPLETELY REMOVE EXISTING FASTENERS

DEMOLITION KEYNOTES:

- WITH STRUCTURAL DRAWINGS.

 2. DEMOLISH AND PROPERLY DISPOSE OF EXISTING GYPSUM BD. CEILING TO
- EXPOSE UNDERSIDE OF FLOOR JOIST FRAMING. COMPLETELY REMOVE EXISTING WITH STRUCTURAL DRAWINGS.
- WHERE REQUIRED.
- 4. EXISTING CEILING TO REMAIN. NO WORK IN THIS AREA/ROOM. 5. CAREFULLY DISMANTLE COFFERED WOOD CEILING, STORE AND PROTECT FOR REINSTALLATION. AFTER COFFERED CEILING HAS BEEN REMOVED, DEMOLISH AND PROPERLY DISPOSE OF EXISTING PLASTER AND LATH CEILING TO EXPOSE ROOF



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EDA PROJECT No. 01-01-15369 HUD PROJECT No. B-23-CP-NY-1083

ACADEMIC INNOVATION HUB - WORK FORCE DEVELOPMENT TRAINING

822 CLEVELAND AVENUE NIAGARA FALLS, NEW YORK 14305

NO: DATE:		DESCRIPTION:			
Revisions					
PROJECT	NUMBER:	2221723			
DRAWN BY:		JMR			
REVIEWED BY:		JAK			
ISSUED FOR:		BID			
DATE:		APRIL 11, 2024			

REFLECTED CEILING **DEMOLITION PLANS**


DRAWING NUMBER:

GENERAL ARCHITECTURAL NOTES

- 1. UNLESS OTHERWISE NOTED, ALL MASONRY DIMENSIONING IS NOMINAL TO FACE OF MASONRY, ALL NON-MASONRY DIMENSIONING IS TO FACE OF PARTITIONS OR WALLS AND ALL CONCRETE DIMENSIONING IS FACE TO FACE OF WALL.
- 2. ALL DIMENSIONS ARE TO THE OUTSIDE FINISH SURFACE OF WALLS OR TO COLUMN CENTERLINES
- 3. ALL DIMENSIONS ARE FINISHES DIMENSIONS FROM FINISH FACE OF GYPSUM BOARD OR SCHEDULED WALL FINISH UNLESS OTHERWISE NOTED.
- 4. PROVIDE CONCEALED BLOCKING IN ALL STUD PARTITIONS AND WALLS BEHIND SURFACE FOR SEMI-RECESSED, FULLY RECESSED OR SURFACE MOUNTED ACCESSORIES AND MILLWORK.
- 5. DIMENSIONS NOTED AS "CLEAR" ARE TO FINISHED SURFACE AND ARE CRITICAL FOR ACCESSIBILITY REQUIREMENTS OR BUILT-IN FURNISHINGS
- 6. CONTRACTOR SHALL FIELD VERIFY FINISHED DIMENSIONS AND CLEARANCES IN SPACES INDICATED TO RECEIVE BUILT-IN FURNISHINGS OR CASEWORK PRIOR TO FABRICATION.
- 7. ALL VERTICAL CONCRETE SURFACES WHICH WILL BE EXPOSED TO VIEW UPON COMPLETION OF WORK SHALL RECEIVE A SMOOTH RUBBED FINISH.
- 8. ALL ENDS OF MASONRY WALLS THAT WILL BE EXPOSED TO VIEW UPON COMPLETION OF WORK SHALL BE PLAIN END UNITS.
- 9. FINISHED DOOR OPENINGS SHALL BE NOMINAL 6" FROM FINISHED CORNER OF ROOM EXCEPT WHERE DIMENSIONED OTHERWISE.
- 10. SEALANT SHALL BE PROVIDED AT THE INTERIOR AND EXTERIOR PERIMETER OF ALL WINDOWS, DOOR FRAMES, LOUVERS OR OTHER ITEMS INSERTED IN AN EXTERIOR WALL.
- 11. SUSPENDED GRID CEILINGS SHALL BE ARRANGED SO THAT A GRID IS SPACED EQUALLY FROM EACH MOST REMOTE WALL, IN EACH DIRECTION, WITH NO TILES LESS THAN 6" UNLESS OTHERWISE
- 12. WOOD USED FOR BLOCKING OR OTHER PURPOSES ON OR ABOVE THE ROOF DECK, WITHIN 2'-0" OF GRADE AND IN OTHER LOCATIONS OUTSIDE THE BUILDING ENVELOPE WHERE EXPOSED TO THE
- WEATHER SHALL BE PRESSURE TREATED LUMBER OR PLYWOOD. 13. INSTALL ALL WORK AS INDICATED AND VERIFY EXACT LOCATION AND ELEVATIONS ON THE JOB.
- 14. DO NOT SCALE DRAWINGS. REFER TO DIMENSIONS AND SPECIFIED MATERIALS. CONTACT THE ARCHITECT IF ADDITIONAL DIMENSIONS ARE REQUIRED.
- 15. COORDINATE ALL DOOR HARDWARE, TRIM AND FINISHES TO MEET INTENT AND COMPLIANCE.
- 16. FIRST FLOOR LEVEL DATUM ELEVATION (0'-0") IS EQUAL TO ACTUAL ELEVATION (XX'-XX"). ARCHITECTURAL ELEVATIONS U.O.N. ARE TAKEN FROM FINISHED FIRST FLOOR LEVEL DATUM ELEVATION (0'-0").
- 17. INTERIOR WALL AND CEILING FINISH MINIMAL REQUIREMENTS (FINISH CLASSIFICATIONS IN ACCORDANCE WITH ASTM E84) ARE AS FOLLOWS: VERTICAL EXITS AND EXIT PASSAGEWAYS - CLASS B EXIT ACCESS CORRIDORS AND OTHER EXIT WAYS - CLASS C

ROOMS AND ENCLOSED SPACES - CLASS C

- 18. TRUSS IDENTIFICATION SIGNS SHALL BE PROVIDED IN ACCORDANCE WITH TITLE 19 NYCRR PART 1264 AND APPENDIX H OF THE FIRE CODE OF NEW YORK STATE 2010. TRUSS IDENTIFICATION SIGNS SHALL BE LOCATED AT BUILDING ENTRANCE DOORS, EXTERIOR DISCHARGE DOORS AND FIRE DEPARTMENT HOSE CONNECTIONS.
- A. ATTACH SIGN TO FACE OF DOOR. OR ATTACHED TO A SIDELIGHT OR FACE OF THE BUILDING NOT MORE THAN 12 INCHES HORIZONTALLY FROM THE LATCH SIDE OF THE DOOR JAMB. AND NOT LESS THAN 42 INCHES NOR MORE THAN 60 INCHES ABOVE THE ADJOINING WALKING SURFACES.
- ATTACH SIGN AT EACH END OF A ROW OF DOORS AT A MAXIMUM HORIZONTAL DISTANCE OF 12 FEET BETWEEN SIGNS, AND NOT LESS THAN 42 INCHES NOR MORE THAN 60 INCHES ABOVE THE ADJOINING WALKING SURFACE.
- AT FIRE DEPARTMENT HOSE CONNECTIONS ATTACH TO THE FACE OF BUILDING, NOT MORE THAN 12 INCHES HORIZONTALLY FROM THE CENTER LINE OF THE FIRE DEPARTMENT HOSE CONNECTION, AND NOT LESS THAN 42 INCHES NOR MORE THAN 60 INCHES ABOVE THE ADJOINING WALKING SURFACE.
- SIGNS IDENTIFYING THE EXISTENCE OF TRUSS CONSTRUCTION SHALL CONSIST OF A CIRCLE 6 INCHES IN DIAMETER. WITH A STROKE WIDTH OF 1/2 INCH. THE SIGN BACKGROUND SHALL BE REFLECTIVE WHITE IN COLOR. THE CIRCLE AND CONTENTS SHALL BE REFLECTIVE RED IN COLOR, CONFORMING TO PANTONE MATCHING SYSTEM (PMS) # 187. WHERE A SIGN IS DIRECTLY APPLIED TO A DOOR OR SIDELIGHT, IT MAY BE A PERMANENT STICKER OR DECAL, SIGNS NOT DIRECTLY APPLIED TO DOORS OR SIDELIGHTS SHALL BE STURDY, NON-FADING, WEATHER RESISTANT MATERIAL.
- F. SIGNS SHALL CONTAIN THE ROMAN ALPHANUMERIC DESIGNATION OF THE CONSTRUCTION TYPE OF THE BUILDING, IN ACCORDANCE WITH THE PROVISIONS FOR THE CLASSIFICATION OF TYPES SET FORTH IN SECTION 602 OF THE BUILDING CODE OF NEW YORK STATE 2010, AND AN ALPHABETIC DESIGNATION FOR THE STRUCTURAL COMPONENTS THAT ARE OF TRUSS CONSTRUCTION AS FOLLOWS:
 - "F" SHALL MEAN FLOOR FRAMING, INCLUDING GIRDERS AND BEAMS
 - "R" SHALL MEAN ROOF FRAMING
 - "FR" SHALL MEAN FLOOR AND ROOF FRAMING
- G. THE CONSTRUCTION TYPE DESIGNATION SHALL BE PLACED AT TWELVE O'CLOCK POSITION OVER THE STRUCTURAL COMPONENT DESIGNATION, WHICH SHALL BE PLACED AT THE SIX O'CLOCK POSITION. REFER TO FOLLOWING SYMBOL FOR THIS BUILDING:

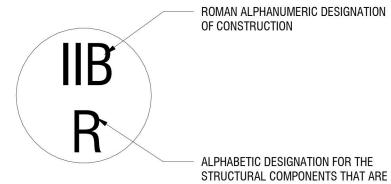

TRUSS CONSTRUCTION

LINE TYPES

VISIBLE ITEMS

CENTER LINE OR COLUMN GRID

HIDDEN OR NOT IN CONTRACT BREAK LINE

---- OVERHEAD

WALL/ PARTITION DESIGNATIONS


BRICK FACE

C.M.U. WALL / PARTITION - SEE PARTITION TYPES

METAL STUD PARTITION - SEE PARTITION TYPES

EXISTING WALL CONSTRUCTION

ARCHITECTURAL ABBREVIATIONS

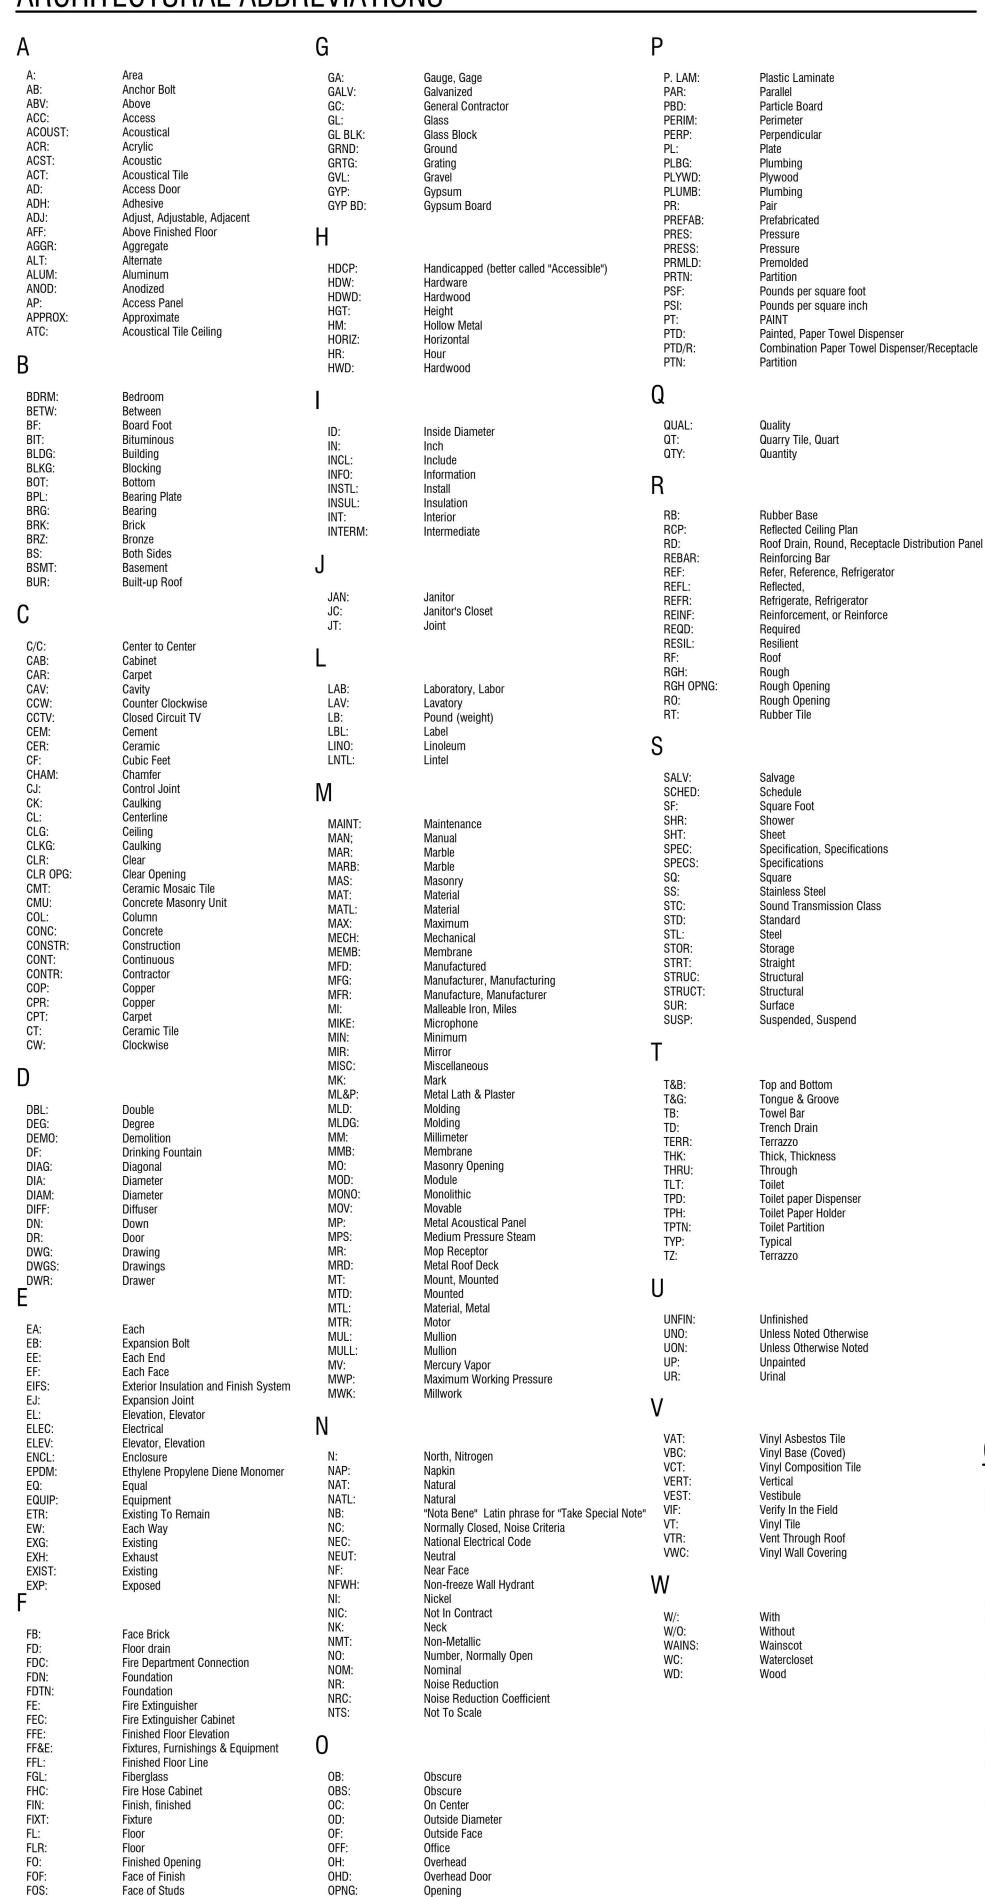

OPP:

Opposite

Opposite Hand

Fireproof

Fire Retardant

Footing, Fitting

Furnish, Furniture

Foot, Feet,


Furring

MATERIAL SYMBOLS


CONCRETE MASONRY UNITS WOOD (FINISHED) RIGID INSULATION CONCRETE WOOD (ROUGH) BATT. OR LOOSE INSULATION WOOD (BLOCKING) CEMENT, SAND, GROUT, PLASTER PARTICLE BOARD CARPET OR GYPSUM WALL BOARD STONE, GRAVEL, OR POROUS

PLYW00D

ARCHITECTURAL DRAWINGS SYMBOLS

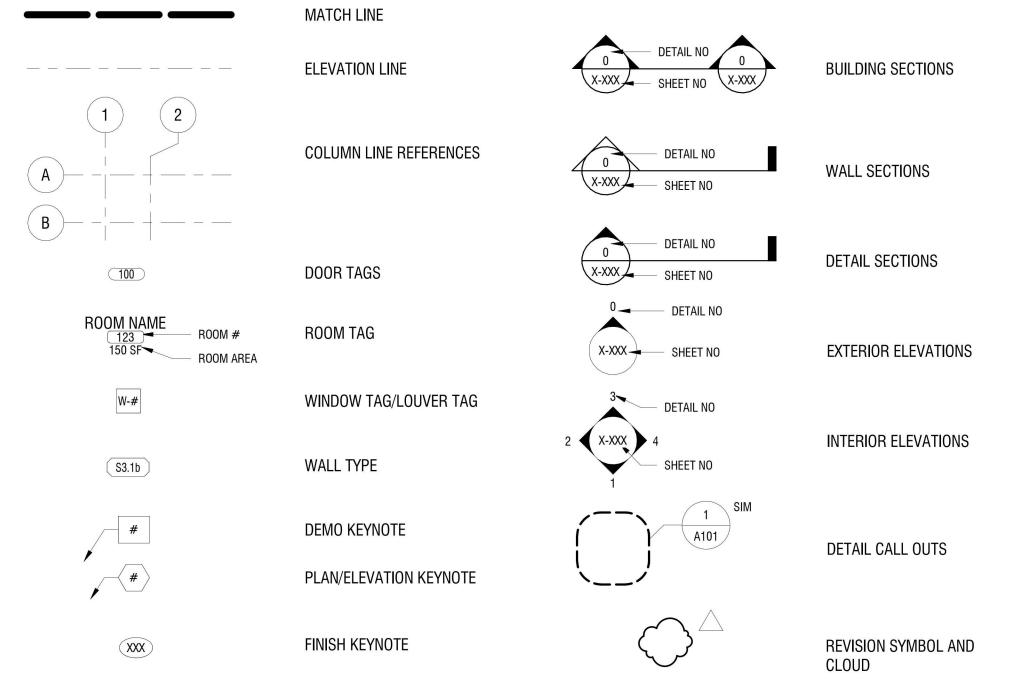

TYPICAL PLAN DIMENSIONING

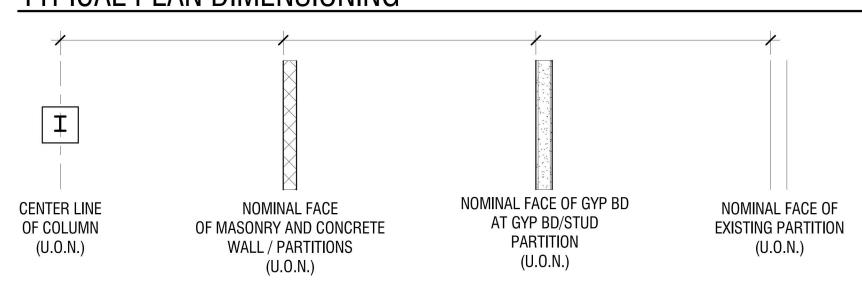

GENERAL REMOVAL NOTES:

- DASHED LINES INDICATE ITEMS TO BE REMOVED.
- ELEMENTS TO REMAIN IN PLACE SHALL BE PROTECTED FROM DAMAGE, DUST AND DEBRIS. DUST CONTROL SHALL BE THE FULL RESPONSIBILITY OF THE CONTRACTOR. CONTRACTOR SHALL PERFORM CLEAN UP OF ALL REFUSE, RUBBISH, SCRAP MATERIALS AND DEBRIS CAUSED BY THE WORK ON A DAILY BASIS. CLEANING OF AREA SURROUNDING THE WORK AREA WHERE
- CONSTRUCTION DEBRIS OR DUST ACCUMULATES WILL BE THE RESPONSIBILITY OF THE CONTRACTOR. REFER TO CIVIL, STRUCTURAL, MECHANICAL, ELECTRICAL, PLUMBING AND FIRE PROTECTIONS DRAWINGS FOR DEMOLITION OF ADDITIONAL ITEMS. REFER TO ABATEMENT DRAWINGS FOR HAZARDOUS MATERIAL DEMOLITION ITEMS.
- CONTRACTOR TO MAINTAIN WATER TIGHT INTEGRITY OF BUILDING AT ALL TIMES. EXISTING CONDITIONS ARE TAKEN FROM FIELD OBSERVATIONS AND PRIOR CONSTRUCTION DOCUMENTS WHEN AVAILABLE AND ARE NOT GUARANTEED. CONTRACTORS ARE RESPONSIBLE FOR EXAMINING THE BUILDING AND VERIFYING EXISTING CONDITIONS AND ARE TO CONTACT THE OWNER
- REPRESENTATIVE REGARDING ANY DISCREPANCIES. 7. DEMOLITION WORK SHALL INCLUDE REMOVAL OF ALL ITEMS INDICATED TO BE REMOVED AND/OR SALVAGED, AND LEGAL DISPOSAL OF ITEMS NOT INTENDED FOR SALVAGE. WORK SHALL ALSO INCLUDE REMOVAL OF ALL MINOR SUPPORTS, BRACKETS, FASTENERS, CONDUITS, PIPING, AND SIMILAR ITEMS WHICH ARE NOT INDICATED TO REMAIN.
- 8. ALL FLOOR AND WALL CONDITIONS WHICH ARE TO RECEIVE NEW CONSTRUCTION ARE TO BE
- DEMOLISHED AS INDICATED AND PROPERLY PREPPED TO RECEIVE NEW FINISHES, U.N.O. ALL FLOOR, WALL. AND CEILING CONDITIONS THAT ARE DISTURBED BY DEMOLITION ARE TO BE PATCHED, REPAIRED AND/OR PAINTED, WITH SIMILAR MATERIALS AND COLORS. REFER TO NEW
- WORK FLOOR PLANS, REFLECTED CEILING PLANS, AND FINISH SCHEDULE. 10. AT WALL REMOVAL FOR MECHANICAL PENETRATIONS, OPENING TO BE APPROXIMATELY 6" LARGER
- THAN DUCT SIZE ON ALL SIDES, COORDINATE WITH MECHANICAL DRAWINGS 11. ALL EMBOSSED DECORATIVE DOOR KNOBS TO BE SALVAGED AND TURNED OVER TO OWNER. 12. FOR ADDITIONAL REMOVAL INFORMATION REFER TO SECTIONS AND DETAILS.

GENERAL CONSTRUCTION NOTES:

THOSE SHOWN ON THE DOCUMENTS.

- A. CONSTRUCTION SHALL CONFORM TO THE "NEW YORK STATE UNIFORM FIRE PROTECTION AND BUILDING CODE", LATEST REVISION, THE NEW YORK STATE ENERGY CODE AND ANY OTHER CODES GOVERNED BY THE JURISDICTION IN WHICH THE PROJECT IS BEING CONSTRUCTED.
- CONSTRUCTION SHALL COMPLY WITH ALL LOCAL, STATE AND FEDERAL CODES AND REGULATIONS. C. ALL DRAWINGS ARE GRAPHIC REPRESENTATIONS OF APPROXIMATE LOCATIONS OF NEW MATERIALS. IT IS THE CONTRACTOR'S RESPONSIBILITY TO FIELD VERIFY ALL CONDITIONS PRIOR TO COMMENCEMENT OF
- CONTRACTORS ARE RESPONSIBLE FOR ALL MATERIALS, CONSTRUCTION METHODS AND CRAFTSMANSHIP. CONTRACTORS ARE TO VERIFY ALL EXISTING CONDITIONS, REQUIREMENTS, NOTES, CODES AND DIMENSIONS, PRIOR TO THE START OF CONSTRUCTION AND SHALL NOTIFY THE ARCHITECT IF CONDITIONS VARY FROM
- F. CONTRACTORS ARE TO PROVIDE ADEQUATE SUPPORT OF EXISTING FOUNDATION WALLS, LOAD BEARING WALLS AND PARTITIONS DURING DEMOLITION AND CONSTRUCTION.
- G. THOROUGHLY COORDINATE WORK WITH OTHER TRADES AND DETERMINE THE EXACT ROUTE AND LOCATION OF UTILITIES, MATERIALS AND EQUIPMENT BEFORE FABRICATION AND INSTALLATION. H. WHEN EXISTING CONSTRUCTION IS REMOVED, DISTURBED, DAMAGED, REPLACED OR RENOVATED IN ANY WAY, CONTRACTORS SHALL PROVIDE PATCHING, PAINTING AND MATERIALS OF SAME TYPE AND QUALITY AS
- TO MATCH ADJACENT EXISTING SURFACES, UNLESS OTHERWISE NOTED. I. CONTRACTORS PROVIDE ALL BLOCKING, FURRING AND SHIMMING FOR INSTALLATION AND COMPLETION OF J. ALL NEW WORK SHALL BE PLUMB, LEVEL AND SQUARE. SCRIBE AND MAKE FIT ALL NEW TO EXISTING.
- K. CONTRACTORS VERIFY ALL DIMENSIONS BEFORE ORDERING MATERIAL OR DOING WORK. NO EXTRA COMPENSATION OR CHARGES WILL BE ACCEPTED DUE TO DIFFERENCES BETWEEN THE ACTUAL MEASUREMENTS AND MEASUREMENTS INDICATED ON THE DRAWINGS.
- L. ALL DETAILS ARE SUBJECT TO CHANGE DUE TO EXISTING FIELD CONDITIONS. CONTRACTOR MUST NOTIFY
- M. NO SITE VISITS WILL BE MADE BY THE ARCHITECT. THE CONTRACTOR SHALL ASSUME RESPONSIBILITY FOR CHANGES TO THESE DRAWINGS AND COMPLETION OF COMPLIANT WORK. N. ARCHITECT TO COORDINATE ALL DOOR HARDWARE, TRIM AND FINISHES TO MEET INTENT AND COMPLIANCE O. THESE DRAWINGS DO NOT PURPORT TO SHOW ALL ITEMS AND PROCEDURES REQUIRED FOR A COMPLETE
- INSTALLATION. THE INTENT IS TO INDICATE THE GENERAL SCOPE OF THE PROJECT IN TERMS OF THE GENERAL ARCHITECTURAL DESIGN CONCEPT, THE LOCATION/DIMENSIONS OF THE CONSTRUCTION AND MAJOR ELEMENTS OF CONSTRUCTION P. CONTRACTORS ARE RESPONSIBLE FOR OBTAINING AND PAYING FOR ALL PERMITS ASSOCIATED WITH THE
- WORK OF THEIR CONTRACT.
- Q. ITEMS NOTED AS 'BY OWNER" ARE TO BE FURNISHED AND INSTALLED BY THE OWNER OR THE OWNER'S



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EDA PROJECT No. 01-01-15369 HUD PROJECT No. B-23-CP-NY-1083



ESD PROJECT No. 135,035


ACADEMIC INNOVATION HUB - WORK FORCE DEVELOPMENT TRAINING

822 CLEVELAND AVENUE NIAGARA FALLS, NEW YORK 14305

NO: DATE: DESCRIPTION: PROJECT NUMBER: 2221723 DRAWN BY: **JMR REVIEWED BY:** ISSUED FOR: BID DATE: APRIL 11, 2024


> **NOTES, SYMBOLS AND ABBREVIATIONS**

DRAWING NUMBER:

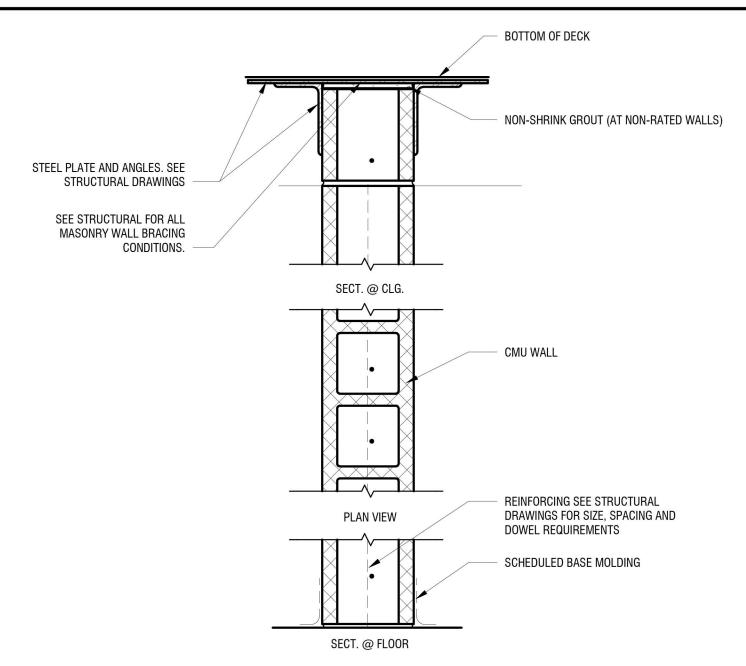


WALL TYPE M (CONCRETE MASONRY UNITS)

MARK	BLOCK SIZE	GAUGE	PARTITION WIDTH	FIRE TEST DESIGN NO.	FIRE RATING	STC
M4.0	4" NOMINAL	N/A	3 5/8"	N/A	NON-RATED	-
M6.0	6" NOMINAL	N/A	5 5/8"	N/A	NON-RATED	
M6.1	6" NOMINAL	N/A	5 5/8"	UL 906	1 HR	
M6.2	6" NOMINAL	N/A	5 5/8"	UL 906	2 HR	-
M8.0	8" NOMINAL	N/A	7 5/8"	N/A	NON-RATED	
M8.1	8" NOMINAL	N/A	7 5/8"	UL U905	1 HR	
M8.2	8" NOMINAL	N/A	7 5/8"	UL U905	2 HR	
M12.0	12" NOMINAL	N/A	11 5/8"	N/A	NON-RATED	

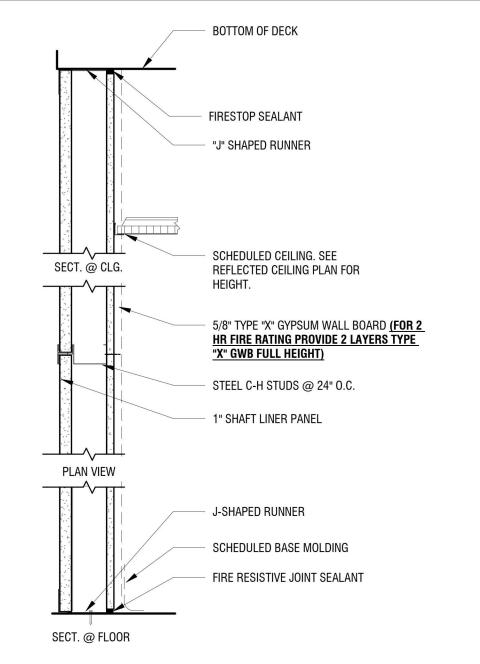


WALL TYPE SH (SHAFT ASSEMBLY, METAL C STUDS)

MARK	STUD SIZE	GAUGE	PARTITION WIDTH	FIRE TEST DESIGN NO.	FIRE RATING	STC
SH1.1	2 1/2" C-H	25 GA	3-1/8"	UL-U469	1 HR	

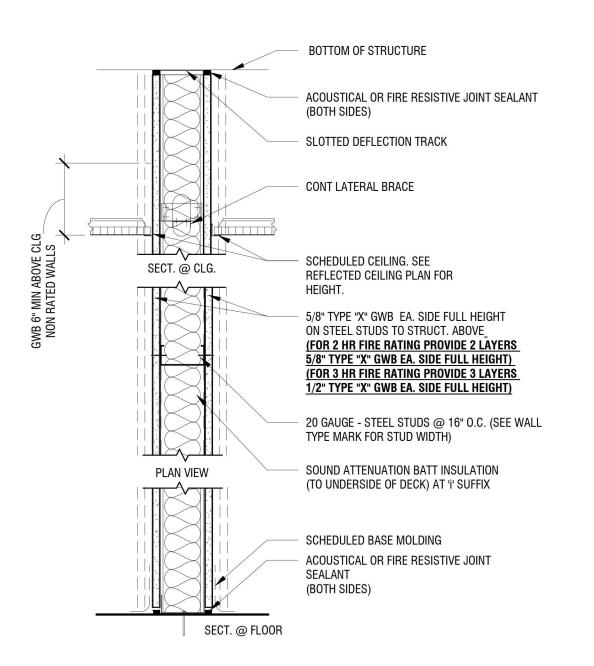


WALL TYPE S (METAL STUD)

MARK	STUD SIZE	GAUGE	PARTITION WIDTH	FIRE TEST DESIGN NO.	FIRE RATING	STC	GYPSUM LAYERS EACH SIDE
\$3.0	3 5/8"	20 GA	4 7/8"		NON-RATED		1x 5/8" + 1x 5/8"
S3.0d	3 5/8"	20 GA	6 1/8"		NON-RATED		2x 5/8" + 2x 5/8"
S3.1	3 5/8"	20 GA	4 7/8"	UL U419	1 HR		1x 5/8" + 1x 5/8"
S3.2	3 5/8"	20 GA	6 1/8"	UL U419	2 HR		2x 5/8"+ 2x 5/8"
S6.0	6"	20 GA	7 1/4"		NON-RATED		1x 5/8" + 1x 5/8"
S6.0a	6"	20 GA	7 1/4"		NON-RATED		1x 5/8" + 1x 5/8"
S6.0d	6"	20 GA	8 1/2"		NON-RATED		2x 5/8" + 2x 5/8"
S6.1	6"	20 GA	7 1/4"	UL U419	1 HR		1x 5/8"+ 1x 5/8"
S6.2	6"	20 GA	8 1/2"	UL U419	2 HR		2x 5/8"+ 2x 5/8"
S8.0	8"	20 GA	9 1/4"		NON-RATED	r==	1x 5/8" + 1x 5/8"
S8.0a	8"	20 GA	9 1/4"		NON-RATED		1x 5/8" + 1x 5/8"

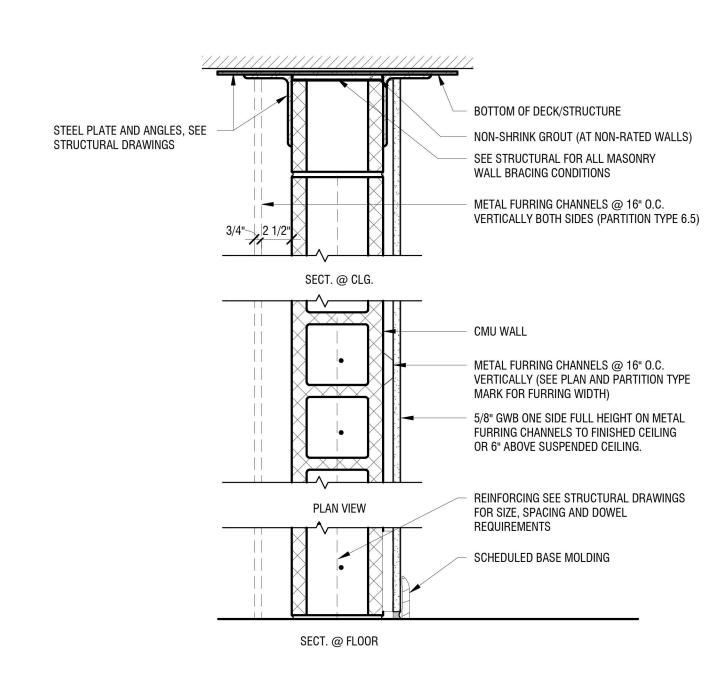


WALL TYPE MF (CONCRETE MASONRY UNITS WITH FURRING)

MARK	BLOCK SIZE	GAUGE	PARTITION WIDTH	FIRE TEST DESIGN NO.	FIRE RATING	FURRING/G.W.B
MF6.0	6" NOMINAL	N/A	7 1/8"	N/A	1-HR	7/8" HC / 5/8" G.W.B.
MF6.1	6" NOMINAL	N/A	8 3/4"	N/A	NON-RATED	2 1/2" MS / 5/8" G.W.B.
MF6.2	6" NOMINAL	N/A	8 3/4"	N/A	1-HR	2 1/2" MS / 5/8" G.W.B.
MF6.3	6" NOMINAL	N/A	9 7/8"	N/A	NON-RATED	3 5/8" MS / 5/8" G.W.B.
MF6.4	6" NOMINAL	N/A	9 7/8"	N/A	1-HR	3 5/8" MS / 5/8" G.W.B.
MF6.5	6" NOMINAL	N/A	10 1/4"	N/A	1-HR	7/8" HC / 5/8" G.W.B. 2 1/2" MS / 5/8" G.W.B.
MF8.0	8" NOMINAL	N/A	9 1/8"	N/A	NON-RATED	7/8" HC / 5/8" G.W.B.
MF8.1	8" NOMINAL	N/A	10 3/4"	N/A	NON-RATED	2 1/2" MS / 5/8" G.W.B.
MF8.2	8" NOMINAL	N/A	10 3/4"	N/A	1-HR	2 1/2" MS / 5/8" G.W.B.
MF8.3	8" NOMINAL	N/A	11 7/8"	N/A	NON-RATED	3 5/8" MS / 5/8" G.W.B.
MF8.4	8" NOMINAL	N/A	11 7/8"	N/A	1-HR	3 5/8" MS / 5/8" G.W.B.

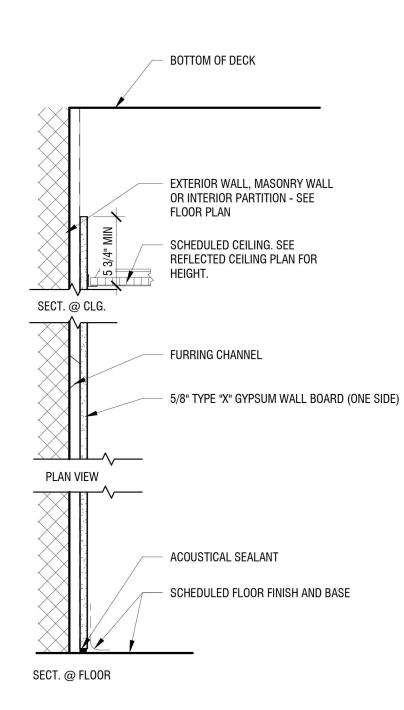

WALL TYPE F


MARK	FURRING CHANNEL SIZE	PARTITION WIDTH	FIRE TEST DESIGN NO.	FIRE RATING	STC
F0.0	7/8"	1-1/2"		NON-RATED	
F1.0	1 5/8"	2-1/4"		NON-RATED	I

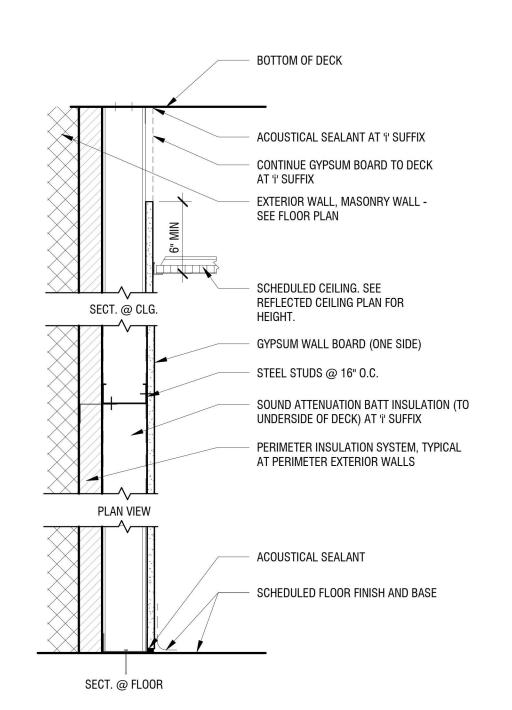

WALL TYPE F

MARK	STUD SIZE	GAUGE	PARTITION WIDTH	FIRE TEST DESIGN NO.	FIRE RATING	STC
F2.0	2 1/2"	18 GA	3 1/8"		NON-RATED	
F3.0	3 5/8"	18 GA	4 1/4"		NON-RATED	
F3.0i	3 5/8"	18 GA	4 1/4"		NON-RATED	43-45
F6.0	6"	18 GA	6 5/8"		NON-RATED	

PARTITION TYPE LEGEND

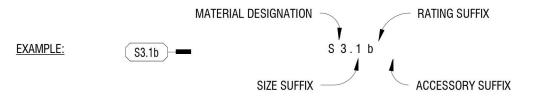

MATERIAL DESIGNATION

- METAL STUDS @ 16" O.C., x REFER TO SPEC'S FOR GA./MIL THICKNESS
- M CONCRETE MASONRY UNITS (CMU)
- MS CONCRETE MASONRY UNITS SECURE (SECURITY CMU)
- METAL STUDS @ 12" O.C./ FURRING CHANNELS / HAT CHANNELS/ Z- FURRING CHANNELS x REFER TO SPECS FOR GA./MIL THICKNESS
- SHAFT ASSEMBLY, METAL C-STUDS
- TEMPORARY BARRIERS. METAL STUDS x REFER TO SPEC'S FOR GA./MIL THICKNESS

SIZE SUFFIX

- 1 5/8" METAL STUDS, OR 7/8" / 1 1/2" HAT CHANNELS (SEE REMARKS)
- 2 1/2" METAL STUDS OR 2" / 2 1/2" Z FURRING CHANNELS (SEE REMARKS)
- 3 5/8" METAL STUDS
- 4" CONCRETE MASONRY UNIT (CMU) OR 4" METAL STUDS
- 6 6" CONCRETE MASONRY UNIT (CMU) OR 6" METAL STUDS
- 8" CONCRETE MASONRY UNIT (CMU) OR 8" METAL STUDS
- 10" CONCRETE MASONRY UNIT (CMU)
- 12" CONCRETE MASONRY UNIT (CMU)

RATING SUFFIX

- 0 NON-RATED CMU OR METAL STUD PARTITION
- 1 HR RATED CMU OR METAL STUD PARTITION (PER UL DESIGN NO.)
- 2 HR RATED CMU OR METAL STUD PARTITION (PER UL DESIGN NO.)
- 3 HR RATED CMU OR METAL STUD PARTITION (PER UL DESIGN NO.)

ACCESSORIES SUFFIX

- a SOUND ATTENUATION FIBERGLASS BATT INSULATION, FRICTION FIT, FULL HEIGHT OF PARTITION
- b SOUND ATTENUATION FIBERGLASS BATT INSULATION, FRICTION FIT, FULL HEIGHT OF PARTITION; ACOUSTICAL SEALANT AT TOP OF PARTITION AT GYPSUM BOARD CEILING AND WOOD COFFER BEAMS.
- c GYPSUM WALL BOARD TO 8" ABOVE CEILING ON BOTH SIDES
- d (2) LAYERS OF GYPSUM WALL BOARD ON BOTH SIDES
- s SMOKE PARTITION

GENERAL PARTITION NOTES

- A. ALL PARTITION EXTEND TO BOTTOM OF CONCRETE FLOOR TO METAL DECK ABOVE UNLESS OTHERWISE INDICATED.
- B. FILL FLUTES IN METAL DECK ABOVE PARTITION WITH FIRE SAFING INSULATION AND FIRE STOP ENTIRE PERIMETER AT RATED PARTITIONS, AND EXTERIOR WALLS
- C. WITH A UL LISTED JOINT SYSTEM FIRESTOP ASSEMBLY.
- D. PROVIDE DEFLECTION TRACKS AT METAL STUD PARTITIONS THAT TERMINATE AT THE UNDERSIDE OF STRUCTURE/
- E. ALL NON-BEARING PARTITIONS SHALL BE CONSTRUCTED TO LIMIT DEFLECTION TO L/360 OF THE SPAN WITH UNIFORM 5 PSF HORIZONTAL LOADING.
- F. ALL PENETRATIONS IN FIRE RATED PARTITIONS TO BE FIRE STOPPED AND SEALED.
- G. ALL PARTITIONS SHALL BE SEALED TO PREVENT PASSAGE OF SMOKE.
- H. CONTRACTOR TO REFER TO CODE/LIFE SAFETY DRAWINGS FOR RATED PARTITIONS.
- I. PROVIDE MOISTURE RESISTANT GYPSUM BOARD AT ALL WET LOCATIONS AND AREAS TO RECEIVE WALL TILE, REFER TO SPECIFICATION IN PROJECT MANUAL.
- J. REFER TO STRUCTURAL DRAWINGS FOR MASONRY WALL REINFORCEMENT.
- K. PROVIDE DOUBLE FRAMING AT ALL DOOR, WINDOW AND CASED OPENINGS JAMBS AND HEAD CONDITIONS.
- L. FOR ALL PARTITIONS, COORDINATE AND PROVIDE BLOCKING FOR ALL BUT NOT LIMITED TO WALL MOUNTED ARCHITECTURAL WOODWORK, FINISH CARPENTRY, TOILET PARTITIONS AND ACCESSORIES, EQUIPMENT, HANDRAILS, HARDWARE AND SIMILAR MOUNTED ITEMS.



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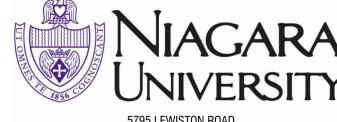


CERTIFICATE OF AUTHORIZATION NUMBER: PROFESSIONAL ENGINEERING: 018281 LAND SURVEYING: 017976

GEOLOGICAL: 018750

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EDA PROJECT No. 01-01-15369 HUD PROJECT No. B-23-CP-NY-1083



ESD PROJECT No. 135,035

ACADEMIC INNOVATION HUB - WORK FORCE DEVELOPMENT TRAINING

822 CLEVELAND AVENUE NIAGARA FALLS, NEW YORK 14305

NO: DATE: DESCRIPTION:

Revisions

PROJECT NUMBER:

2221723

DRAWN BY: JMR

REVIEWED BY: TBD


ISSUED FOR: BID

DATE: APRIL 11, 2024

PARTITION TYPES

DRAWING NUMBER:

DRAWING NAME:

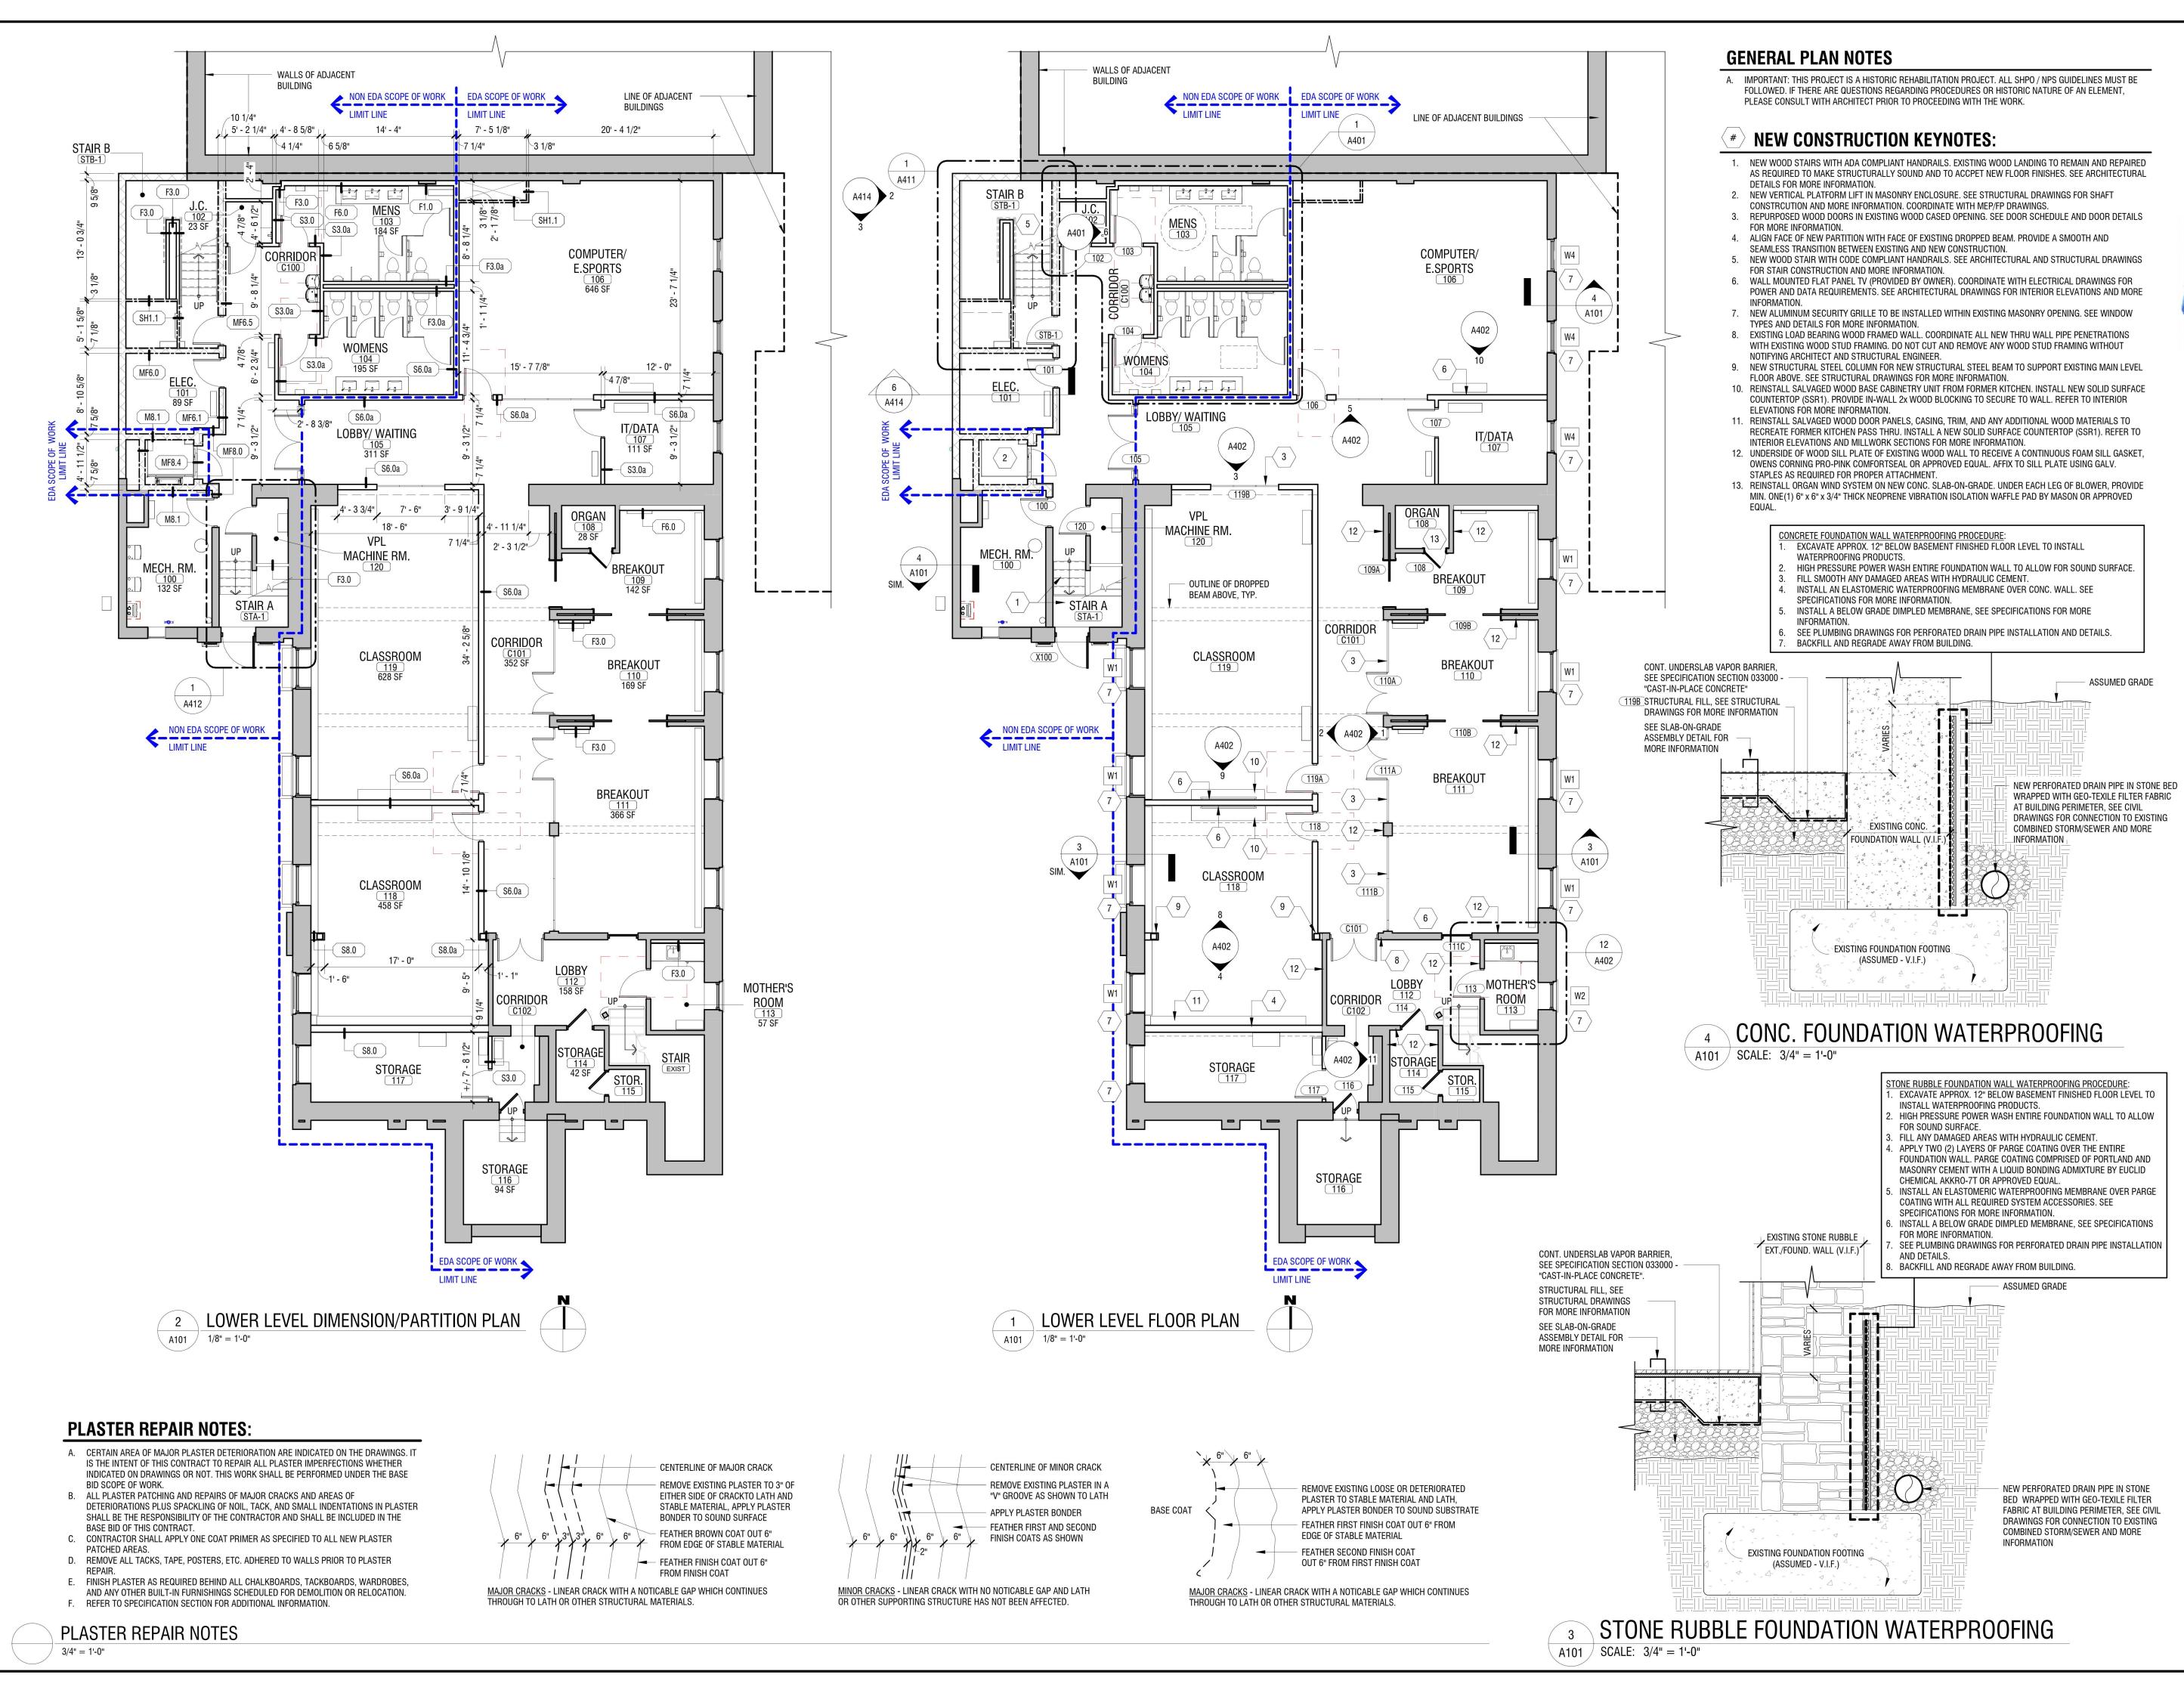

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EXP: 07/31/2024

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EDA PROJECT No. 01-01-15369 HUD PROJECT No. B-23-CP-NY-1083

NEW YORK | Empire State

ESD PROJECT No. 135,035


ACADEMIC INNOVATION HUB - WORK FORCE DEVELOPMENT TRAINING

822 CLEVELAND AVENUE NIAGARA FALLS, NEW YORK 14305

NO: DATE: DESCRIPTION: PROJECT NUMBER: 2221723 DRAWN BY: **JMR** REVIEWED BY: ISSUED FOR: DATE: APRIL 11, 2024

LOWER LEVEL FLOOR

DRAWING NUMBER:

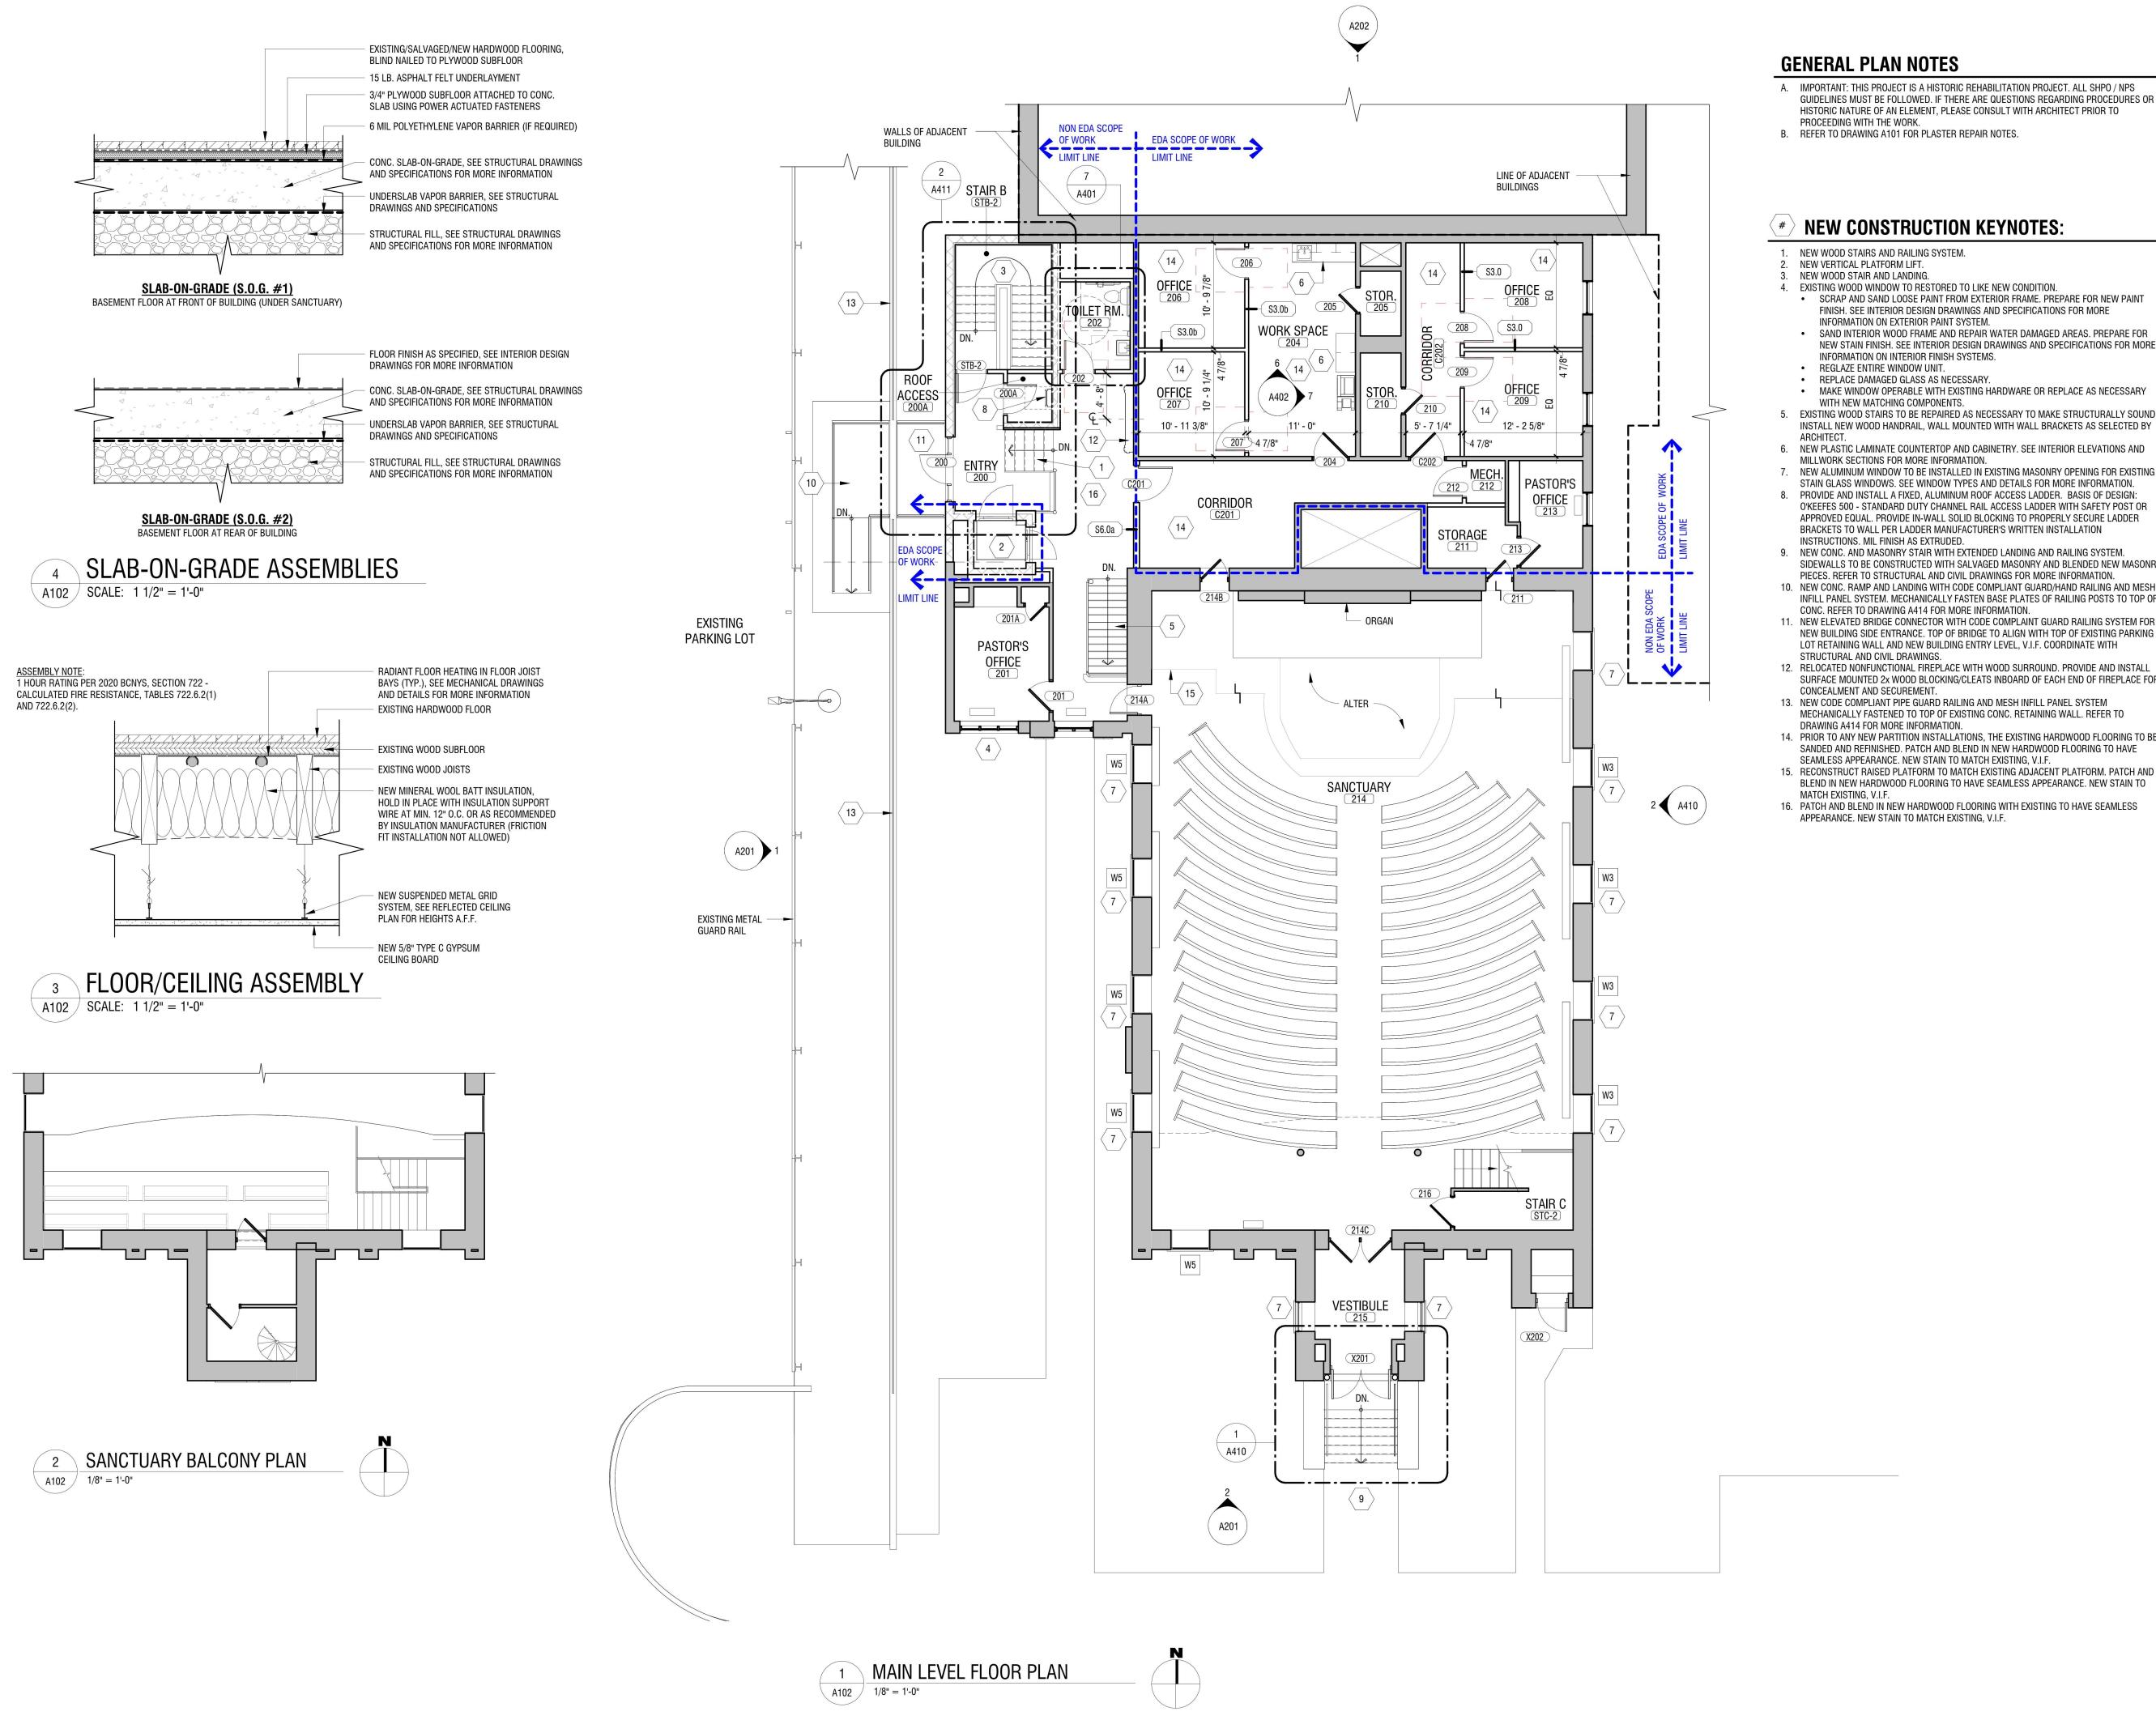

- A. IMPORTANT: THIS PROJECT IS A HISTORIC REHABILITATION PROJECT. ALL SHPO / NPS GUIDELINES MUST BE FOLLOWED. IF THERE ARE QUESTIONS REGARDING PROCEDURES OR HISTORIC NATURE OF AN ELEMENT, PLEASE CONSULT WITH ARCHITECT PRIOR TO
- B. REFER TO DRAWING A101 FOR PLASTER REPAIR NOTES.

NEW CONSTRUCTION KEYNOTES:

- NEW WOOD STAIRS AND RAILING SYSTEM.
- 4. EXISTING WOOD WINDOW TO RESTORED TO LIKE NEW CONDITION. SCRAP AND SAND LOOSE PAINT FROM EXTERIOR FRAME. PREPARE FOR NEW PAINT FINISH. SEE INTERIOR DESIGN DRAWINGS AND SPECIFICATIONS FOR MORE
- SAND INTERIOR WOOD FRAME AND REPAIR WATER DAMAGED AREAS. PREPARE FOR NEW STAIN FINISH. SEE INTERIOR DESIGN DRAWINGS AND SPECIFICATIONS FOR MORE
- INFORMATION ON INTERIOR FINISH SYSTEMS.
- MAKE WINDOW OPERABLE WITH EXISTING HARDWARE OR REPLACE AS NECESSARY
- WITH NEW MATCHING COMPONENTS. EXISTING WOOD STAIRS TO BE REPAIRED AS NECESSARY TO MAKE STRUCTURALLY SOUND
- INSTALL NEW WOOD HANDRAIL, WALL MOUNTED WITH WALL BRACKETS AS SELECTED BY
- 6. NEW PLASTIC LAMINATE COUNTERTOP AND CABINETRY. SEE INTERIOR ELEVATIONS AND
- 7. NEW ALUMINUM WINDOW TO BE INSTALLED IN EXISTING MASONRY OPENING FOR EXISTING STAIN GLASS WINDOWS. SEE WINDOW TYPES AND DETAILS FOR MORE INFORMATION.
- 8. PROVIDE AND INSTALL A FIXED, ALUMINUM ROOF ACCESS LADDER. BASIS OF DESIGN: O'KEEFES 500 - STANDARD DUTY CHANNEL RAIL ACCESS LADDER WITH SAFETY POST OR APPROVED EQUAL. PROVIDE IN-WALL SOLID BLOCKING TO PROPERLY SECURE LADDER BRACKETS TO WALL PER LADDER MANUFACTURER'S WRITTEN INSTALLATION
- SIDEWALLS TO BE CONSTRUCTED WITH SALVAGED MASONRY AND BLENDED NEW MASONRY PIECES. REFER TO STRUCTURAL AND CIVIL DRAWINGS FOR MORE INFORMATION.
- 10. NEW CONC. RAMP AND LANDING WITH CODE COMPLIANT GUARD/HAND RAILING AND MESH INFILL PANEL SYSTEM. MECHANICALLY FASTEN BASE PLATES OF RAILING POSTS TO TOP OF CONC. REFER TO DRAWING A414 FOR MORE INFORMATION.
- LOT RETAINING WALL AND NEW BUILDING ENTRY LEVEL, V.I.F. COORDINATE WITH
- 12. RELOCATED NONFUNCTIONAL FIREPLACE WITH WOOD SURROUND. PROVIDE AND INSTALL SURFACE MOUNTED 2x WOOD BLOCKING/CLEATS INBOARD OF EACH END OF FIREPLACE FOR
- 13. NEW CODE COMPLIANT PIPE GUARD RAILING AND MESH INFILL PANEL SYSTEM MECHANICALLY FASTENED TO TOP OF EXISTING CONC. RETAINING WALL. REFER TO
- DRAWING A414 FOR MORE INFORMATION. 14. PRIOR TO ANY NEW PARTITION INSTALLATIONS, THE EXISTING HARDWOOD FLOORING TO BE
- SANDED AND REFINISHED. PATCH AND BLEND IN NEW HARDWOOD FLOORING TO HAVE SEAMLESS APPEARANCE. NEW STAIN TO MATCH EXISTING, V.I.F. 15. RECONSTRUCT RAISED PLATFORM TO MATCH EXISTING ADJACENT PLATFORM. PATCH AND
- BLEND IN NEW HARDWOOD FLOORING TO HAVE SEAMLESS APPEARANCE. NEW STAIN TO 16. PATCH AND BLEND IN NEW HARDWOOD FLOORING WITH EXISTING TO HAVE SEAMLESS
- APPEARANCE. NEW STAIN TO MATCH EXISTING, V.I.F.



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ESD PROJECT No. 135,035

ACADEMIC INNOVATION HUB - WORK FORCE DEVELOPMENT TRAINING


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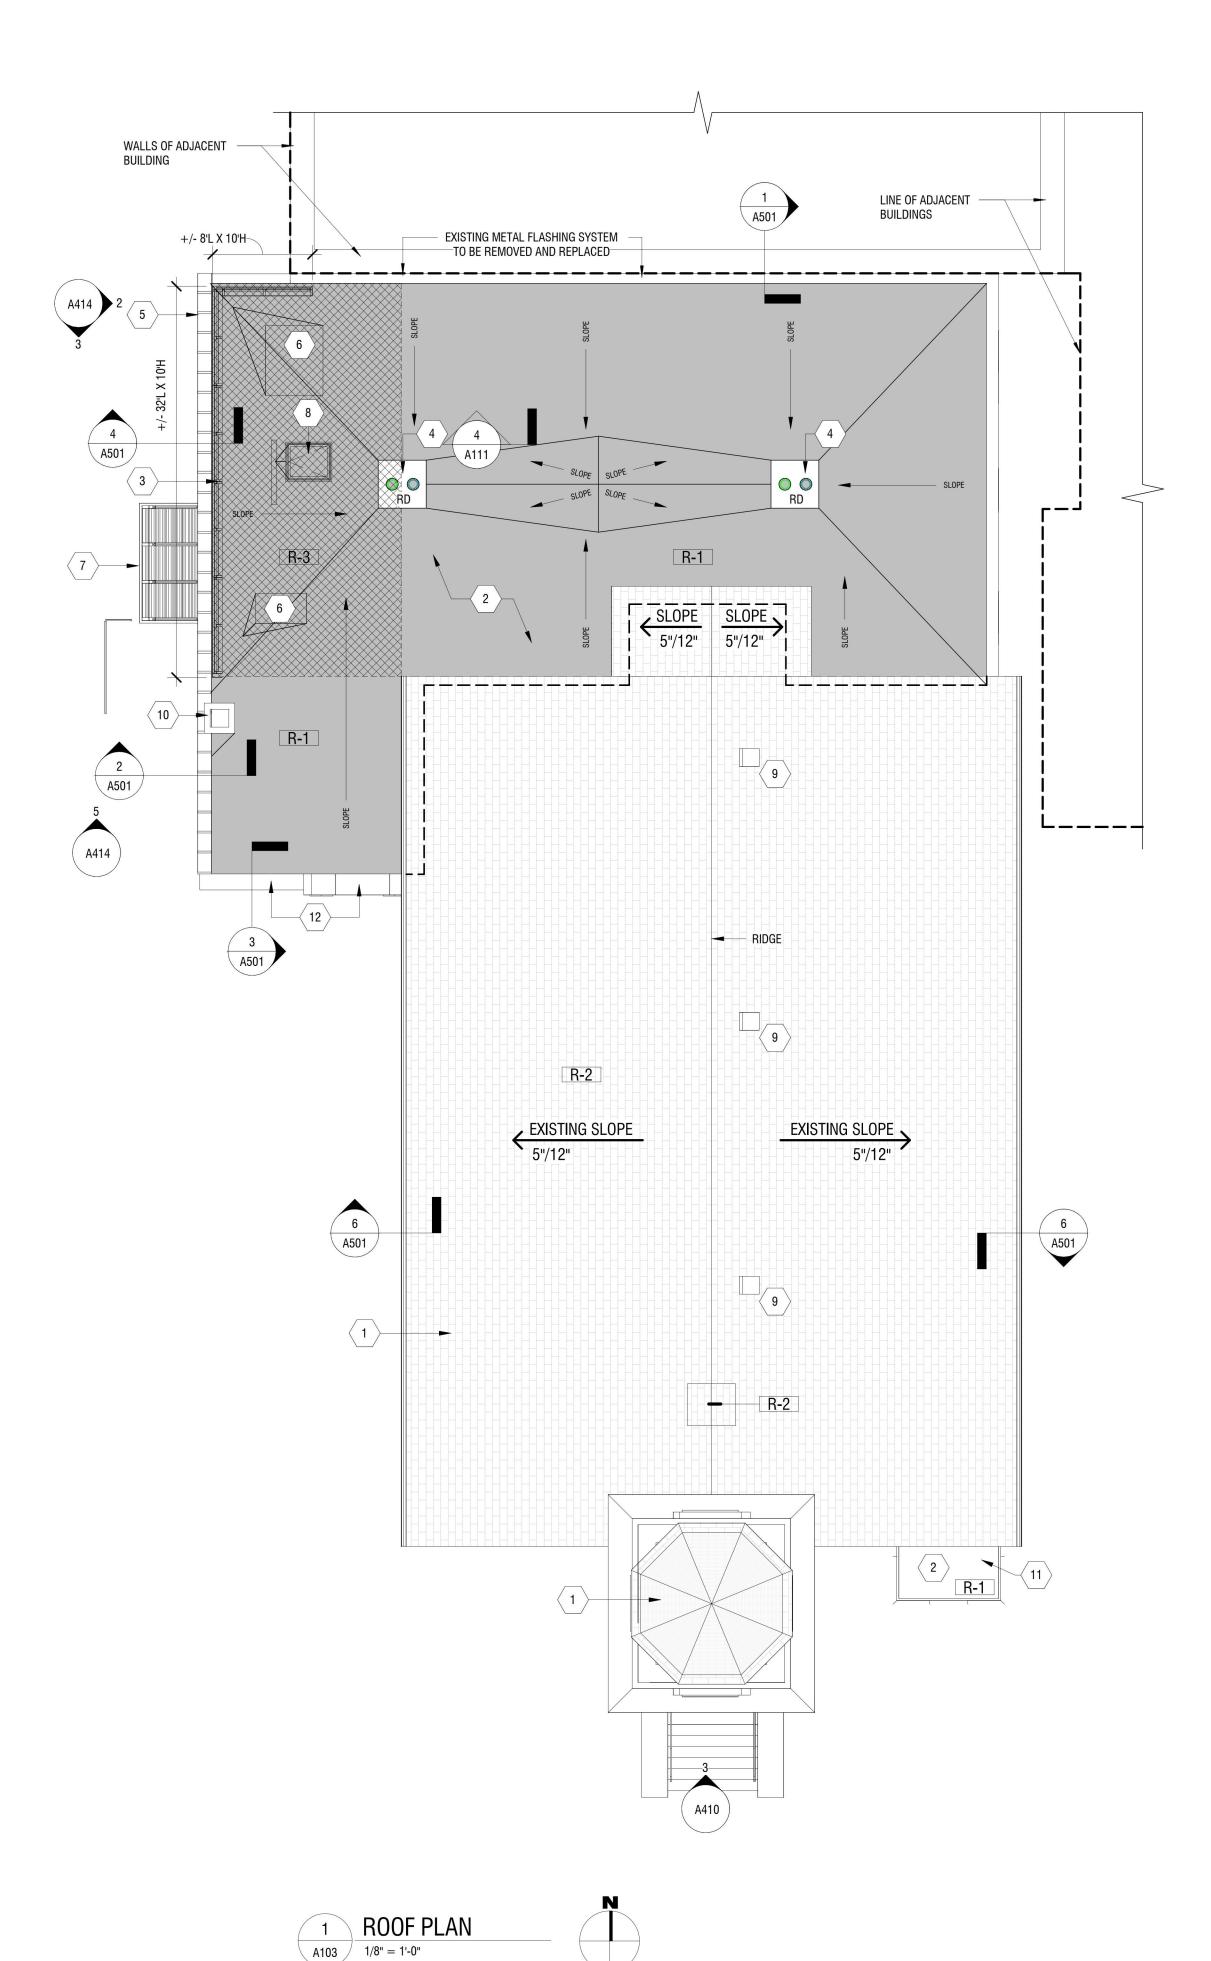
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MAIN LEVEL FLOOR PLAN


DRAWING NUMBER:

DRAWING NAME:



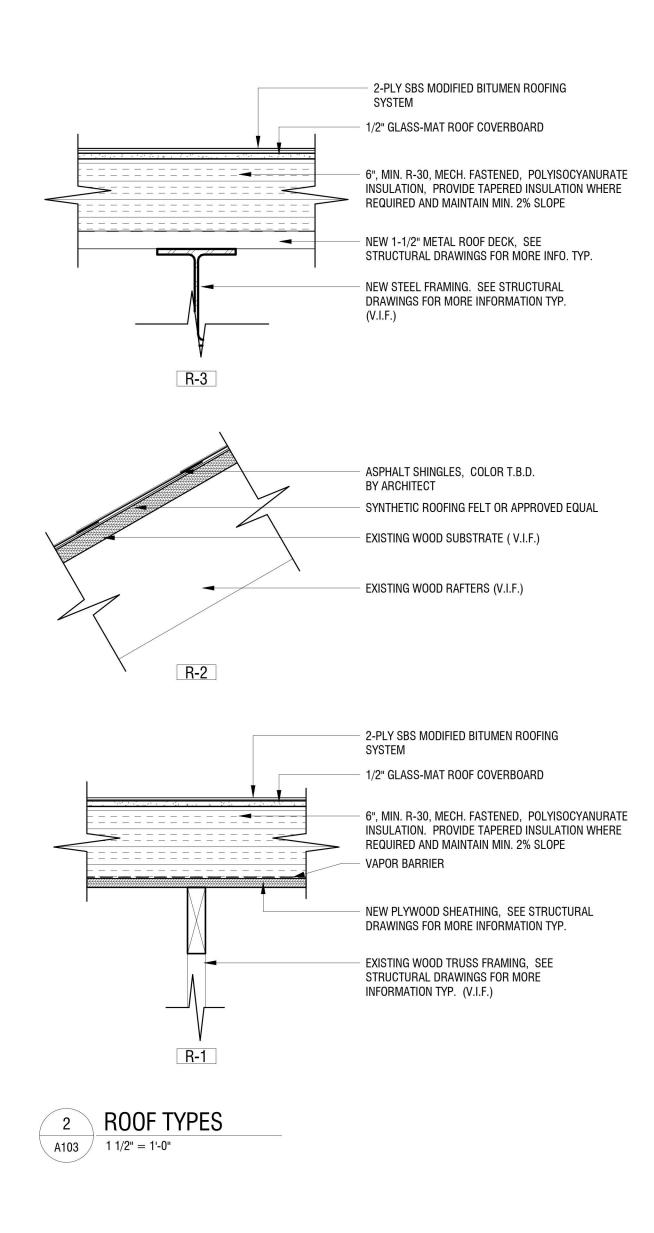

ROOF RENOVATION LEGEND

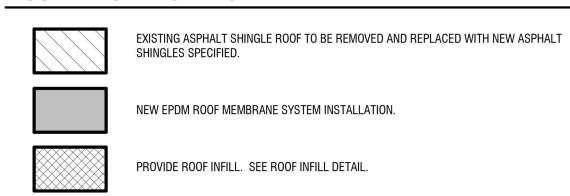

V NEW ROOF VENT. SEE ROOF DETAILS.RD NEW ROOF DRAIN. SEE ROOF DETAILS.

ROOF RENOVATION NOTES:

- A. EXISTING CONDITIONS ARE TAKEN FROM FIELD OBSERVATIONS AND PRIOR CONSTRUCTION DOCUMENTS AND ARE NOT GUARANTEED. CONTRACTOR SHALL FIELD VERIFY ALL EXISTING CONDITIONS PRIOR TO BID. NO ALLOWANCE WILL BE MADE FOR ADDITIONAL COSTS DUE TO CONTRACTORS FAILURE TO VERIFY EXISTING CONDITIONS AND DIMENSIONS.
- B. WHEN EXISTING CONSTRUCTION WHICH IS TO REMAIN IS DAMAGED DURING THE COURSE OF CONSTRUCTION AS A RESULT OF CONTRACTORS WORK, IT SHALL BE REPAIRED AND/OR REPLACED WITH SIMILAR OR LIKE MATERIALS, SUBJECT TO ARCHITECT'S APPROVAL AND WITHOUT COMPENSATION.
- C. ALL WORK INDICATED ON THIS DRAWING SHALL BE DONE UNDER THE ROOFING CONTRACT UNLESS OTHERWISE
- D. G.C. TO PROVIDE ROOF PENETRATIONS REQUIRED TO ACCOMMODATE HVAC EQUIPMENT, COORDINATE EXACT LOCATION OF PENETRATIONS WITH OTHER PRIMES AND ASSIST WITH SETTING OF ALL HVAC EQUIPMENT ROOF CURBS. G.C. SHALL BE RESPONSIBLE FOR TEMPORARY CAO OF ALL ROOF PENETRATIONS AND FOR FLASHING ALL EQUIPMENT CURBS. HVAC CONTRACTOR SHALL REMOVE AND DISPOSE OF TEMPORARY CAP WHEN EQUIPMENT IS SET IN PLACE.
- E. ALL PENETRATIONS ARE THE RESPONSIBILITY OF THE G.C.. COORDINATE ALL 8" x 8" OR LARGER PENETRATION LOCATIONS. LINTELS WILL BE EQUIRED FOR ALL PENETRATIONS THROUGH MASONRY WALLS 1'-4" AND GREATER HORIZONTALLY. PENETRATIONS AND LINTEL LOCATIONS TO BE COORDINATED AND DOCUMENTED ON COORDINATION DRAWINGS
- F. G.C. TO PROVIDE POSITIVE DRAINAGE TO ALL DRAINS MINIMUM OF 1/4" OR AS REQUIRED BY ROOF SYSTEM MANUFACTURER.
- 6. HVAC CONTRACTOR TO LOCATE AND SET ROOF CURBS. G.C. TO PROVIDE SUPPORT FRAMING. G.C. TO PROVIDE ROOF OPENING AND FLASHING OF THE CURB SYSTEM.
- H. THE CONTRACTOR SHALL HAVE A LICENSED ELECTRICIAN CONNECT AS REQUIRED ALL ELECTRICAL CONNECTIONS TO ENSURE PROPER WORKING ORDER. REFER TO M.E.P. DRAWINGS.
 I. WHERE NEW REGLET FLASHING IS CALLED TO BE PROVIDED, THE CONTRACTOR SHALL RAKE THE EXISTING MASONRY
- JOINT TO A DEPTH OF 1-1/2" AND PROVIDE FLASHING AND POINT JOINT WITH NON-SHRINK EPOXY GROUT.

 J. G.C. TO PROVIDE NEW STRUCTURAL FRAMING AND DECKING TO ACCOMMODATE ROOF TOP UNITS. REFER TO AND COORDINATE WITH STRUCTURAL AND MECHANICAL DRAWINGS.

 K. JE PRESENT EXISTING WEEP HOLE OPENINGS ARE TO BE CLEAR OF DERRIS OR CALL K TO ENSURE ADEQUATE.
- K. IF PRESENT, EXISTING WEEP HOLE OPENINGS ARE TO BE CLEAR OF DEBRIS OR CAULK TO ENSURE ADEQUATE DRAINAGE THROUGHOUT.
- L. ALL PENETRATIONS WILL UTILIZE A PIPE BOOT FOR A WEATHER RESISTANT ROOF PENETRATION.

 M. PLUMBING CONTRACTOR SHALL ARRANGE TO HAVE ALL ROOF DRAIN CONDUCTORS CLEANED OUT AND VERIFY THAT THEY ARE NOT PLUGGED BOTH PRE-ROOF DEMOLITION AND AGAIN AFTER ROOF HAS BEEN RECONSTRUCTED. G.C. TO
- COORDINATE WITH PLUMBING CONTRACTOR.

 N. MECHANICAL CONTRACTOR TO PROVIDE AND SET ROOF CURBS. G.C. TO PROVIDE SUPPORT STEEL AND FLASHING OF THE CURB SYSTEM. G.C. SHALL ASSIST WITH SETTING ALL HVAC EQUIPMENT ROOF CURBS. G.C. SHALL BE RESPONSIBLE FOR TEMPORARY CAPPING OF ALL ROOF PENETRATIONS. G.C. SHALL BE RESPONSIBLE FOR FLASHING ALL EQUIPMENT CURBS. HVAC CONTRACTOR SHALL REMOVE AND DISPOSE OF TEMPORARY CAP WHEN
- EQUIPMENT IS SET IN PLACE.

 O. CONTRACTOR TO PROVIDE FASTENERS AS RECOMMENDED BY ROOFING MANUFACTURER AND PROVIDE PULL TESTS
- ON FASTENERS FOR NEW ROOFING SYSTEM.
- P. G.C. IS RESPONSIBLE FOR ALL ROOF DECK REPAIRS.
 Q. G.C. TO PROVIDE METAL TERM BARS WITH FASTENERS AT 8" O.C. AT ALL EXPOSED WALL MEMBRANES AND
- FLASHINGS. TYPICAL.

 R. ROOF TAGS ON ROOF PLAN ARE PROVIDED FOR CONTRACTOR REFERENCE AND ALL ARE TYPICAL. CONTRACTOR TO
- VERIFY ALL CONDITIONS.
 S. AT ALL ROOF DRAIN REPLACEMENT LOCATIONS, CONTRACTOR TO PROTECT ALL CEILINGS BELOW FROM ANY ROOF DEBRIS. ANY AND ALL ROOF DEBRIS THAT ENDS UP ON THE CEILINGS IS TO BE CLEANED IN IT'S ENTIRETY.
 CONTRACTOR MAY REMOVE THE CEILING TILES UNDER THESE LOCATIONS AS NECESSARY TO AVOID ANY DAMAGE
- TO EXISTING CEILINGS AND CATCH ALL ROOF DEBRIS FROM CONSTRUCTION.

 T. THE G.C. TO PROVIDE ALL NECESSARY ROOF LEAK REPAIR FOR DURATION OF ROOFING WORK FROM START TO FINISH
- REGARDLESS OF CAUSE.
 U. THE G.C. SHALL PROVIDE ALL DUMPSTER SERVICE FOR THE ROOFING WORK.
- V. G.C. TO PROVIDE 4" COUNTERFLASHING ATTACHED WITH A REGLET SYSTEM AT ALL EXISTING AND NEW TERM BAR LOCATIONS. VERIFY ALL LOCATIONS IN FIELD.

***** NEW CONSTRUCTION KEYNOTES:

- 1. NEW ASPHALT SHINGLE ROOF SYSTEM. SEE ROOF TYPE, SPECIFICATIONS, AND DETAILS FOR MORE INFORMATION.
- 2. NEW ROOFING SYSTEM. INSTALL ROOF CRICKETS AT ALL EQUIPMENT/HATCH CURBS/PENETRATIONS AS REQUIRED PER ROOF MANUF. SPECIFICATIONS. SEE ROOF TYPE, SPECIFICATIONS AND DETAILS FOR MORE INFORMATION.
- 3. FABRICATE AND INSTALL ROOFTOP EQUIPMENT SCREEN IN SIZE REQUIRED TO SCREEN EQUIPMENT FROM PEDESTRIAN VIEW. PROVIDE WITH METAL PANEL SCREEN (DESIGN AND FINISH T.B.D.) MOUNTED TO GALVANIZED METAL STRUCTURE, FASTENED TO ROOF STRUCTURE TO MEET DESIGN LOADS. BASIS OF DESIGN: CASCADE ROOFTOP SCREENS.
- NEW COMBINATION ROOF DRAIN. SEE PLUMBING DRAWINGS FOR MORE INFORMATION.
 EXISTING CAMELBACK ROOF CAPS TO BE CAREFULLY REMOVED, STORED AND PREPPED FOR REINSTALLATION. PROVIDE NEW PARAPET CAP FLASHING AND TIE-IN NEW ROOF MEMBRANE SYSTEM. INSTALL DOWEL SUPPORTS AS REQUIRED FOR RE-INSTALLATION OF CAMELBACK ROOF CAPS. REPLACE ANY DAMAGED ROOF CAPS IN-KIND. REFER TO DETAILS FOR
- MORE INFORMATION.
 6. NEW HVAC EQUIPMENT. COORDINATE WITH MECHANICAL DRAWINGS.
 7. NEW ALUMINUM CANOPY. SEE SECTIONS AND DETAILS FOR MORE INFORMATION. COORDINATE WITH STRUCTURAL
- 7. NEW ALUMINUM CANOPY. SEE SECTIONS AND DETAILS FOR MORE INFORMATION. COORDINATE WITH STRUCTURAL DRAWINGS. DOWNSPOUT TO TIE DIRECTLY INTO NEW UNDERGROUND STORM DRAINAGE. SEE CIVIL DRAWINGS FOR MORE INFORMATION.
- 8. NEW INSULATED ALUMINUM ROOF ACCESS HATCH WITH LADDER. REFER TO ROOF ACCESS HATCH DETAIL FOR MORE INFORMATION.
- 9. NEW ONE PIECE BLACK ALUMINUM AIR BOX VENT SLANT BACK ROOF LOUVER. INSTALL OVER EXISTING OPENINGS IN ROOF
- 10. NEW CUSTOM CHIMNEY CAP. SEE EXTERIOR ELEVATIONS FOR MORE INFORMATION.
- 11. INSTALL NEW ROOF DRAIN TO EXISTING CAST IRON PIPING. COORDINATE WITH PLUMBING DRAWINGS.12. JOINTS ON ALL SIDES OF EXISTING STONE CAPS TO BE RAKED OUT AND NEW BACKER ROD AND CONT. SEALANT
- JOINTS ON ALL SIDES OF EXISTING STONE CAPS TO BE RAKED OUT AND NEW BACKER ROD AND CONT. SEALANT INSTALLED, TYP.



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EDA PROJECT No. 01-01-15369 HUD PROJECT No. B-23-CP-NY-1083

NEW YORK
STATE OF OPPORTUNITY.
Development

ESD PROJECT No. 135,035

ACADEMIC INNOVATION HUB - WORK FORCE DEVELOPMENT TRAINING

822 CLEVELAND AVENUE NIAGARA FALLS, NEW YORK 14305

NO: DATE: DESCRIPTION:
Revisions

PROJECT NUMBER: 2221723

DRAWN BY: JMR
REVIEWED BY: JAK


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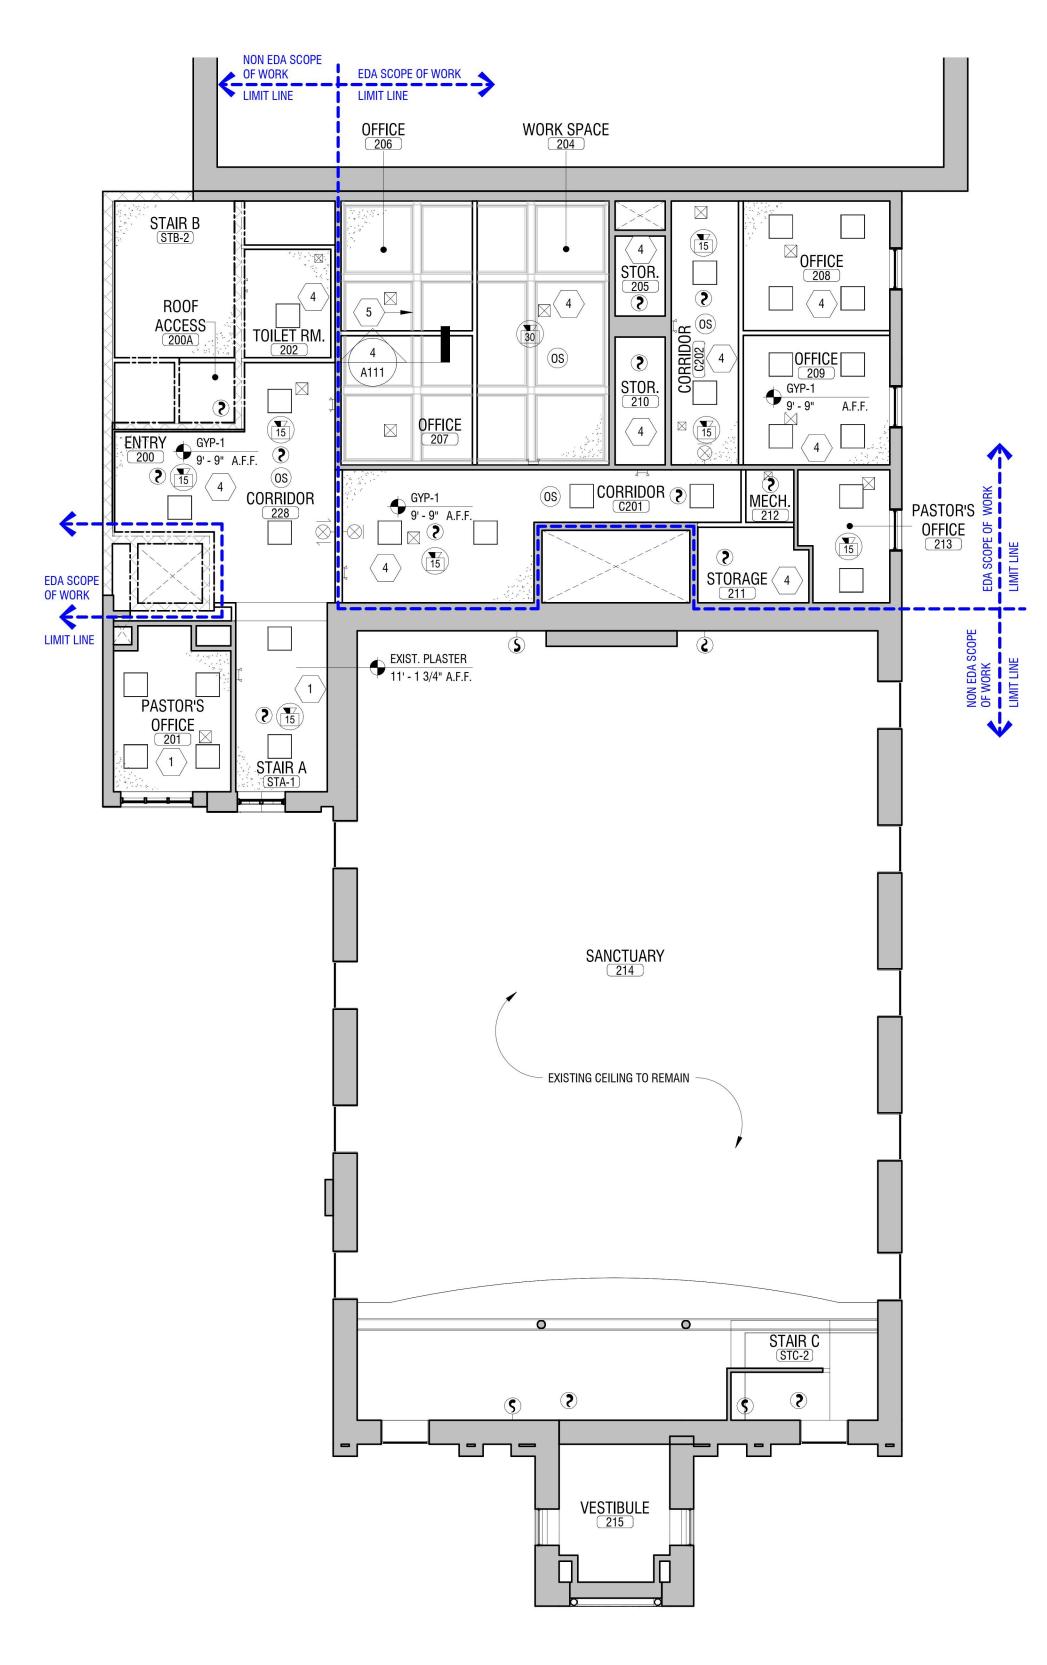
DATE: APRIL 11, 2024

ROOF PLAN

DRAWING NUMBER:

DRAWING NAME:



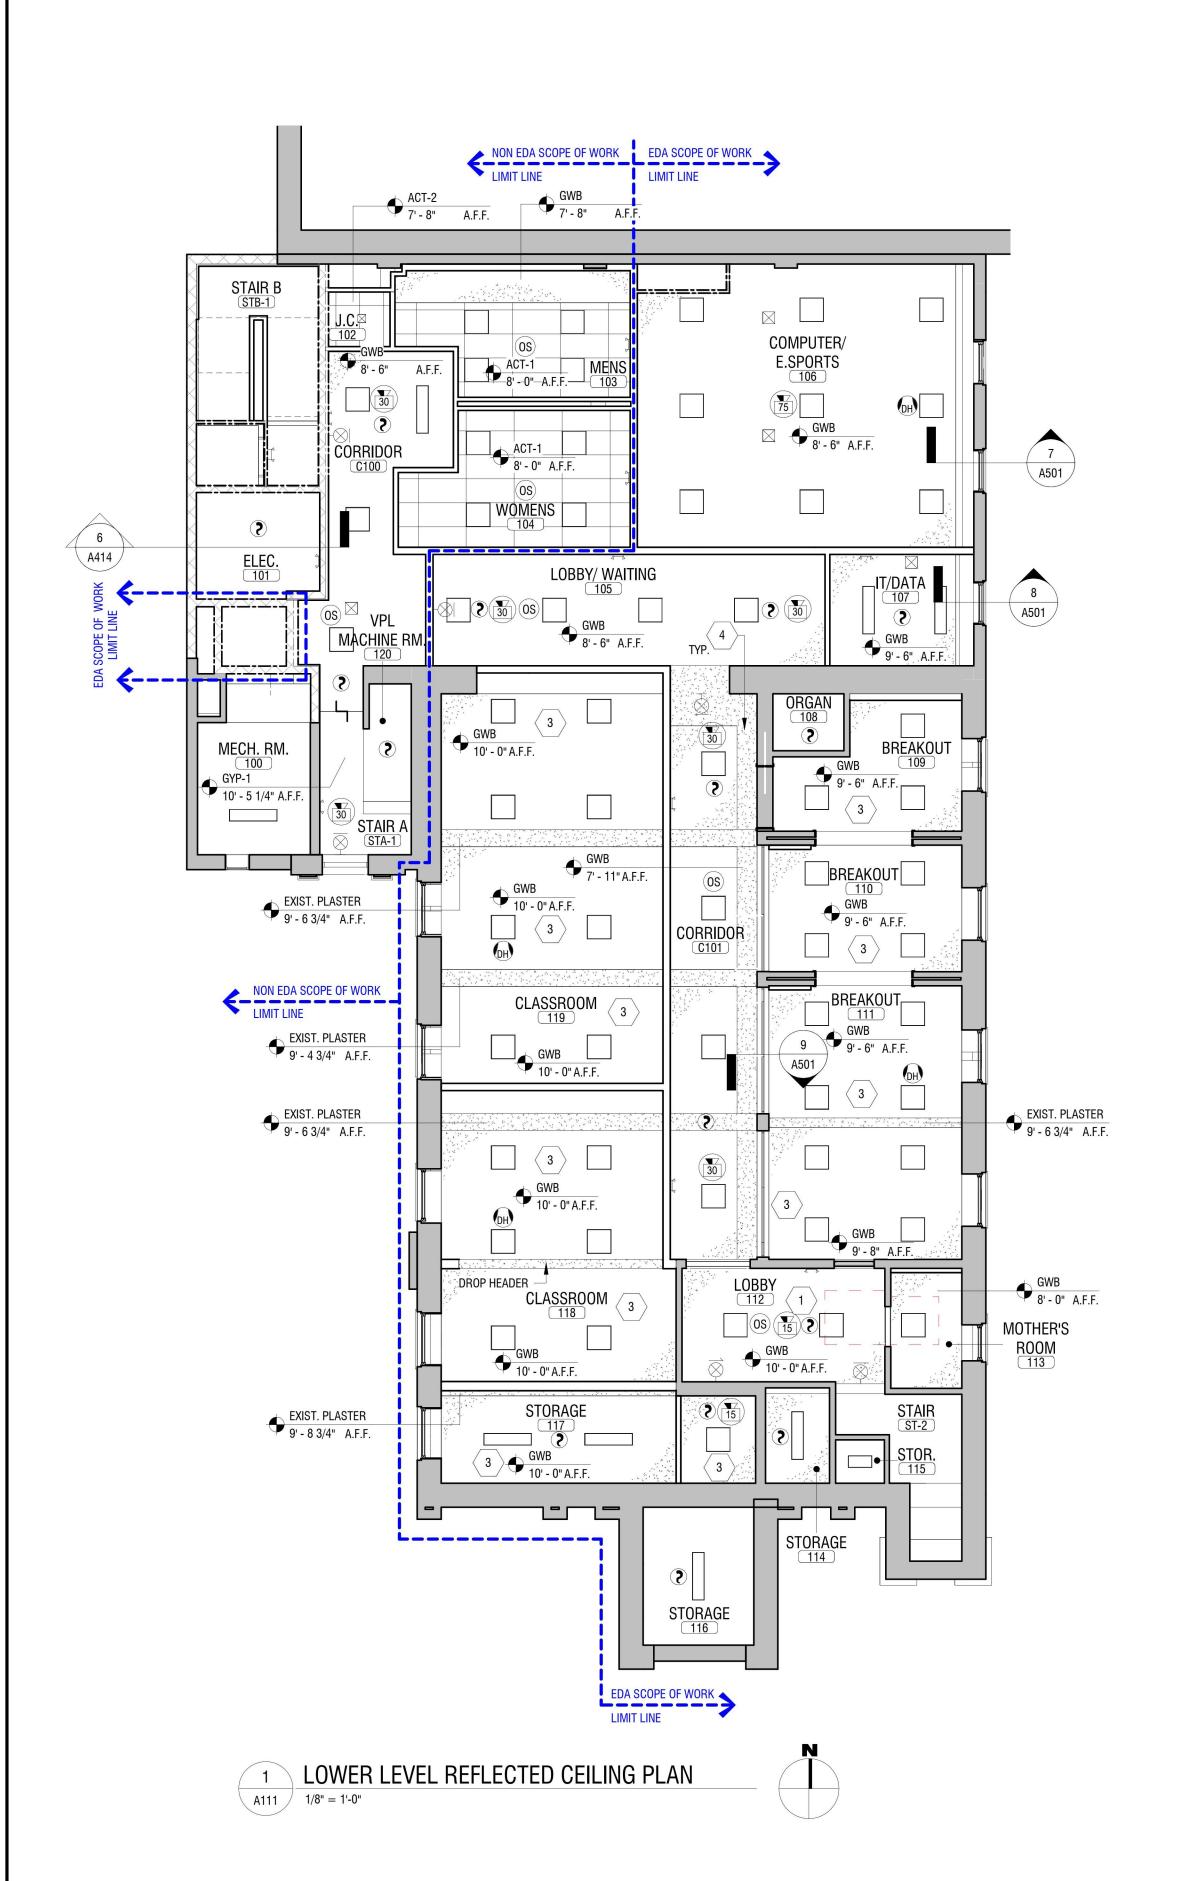

MAIN LEVEL REFLECTED CEILING PLAN A111 SCALE: 1/8" = 1'-0"



GENERAL CEILING NOTES

- A. REFER TO FLOOR/CEILING DETAIL #3 ON DRAWING A102 FOR NEW SUSPENDED CEILING SYSTEM INSTALLATION TO UNDERSIDE OF EXISTING MAIN LEVEL FLOOR CONSTRUCTION.
- REFER TO INTERIORS, PLUMBING, MECHANICAL, ELECTRICAL, AND FIRE PROTECTION DRAWINGS FOR ANY
- ADDITIONAL CEILING AND WALL MOUNTED ITEMS NOT SHOWN. PROVIDE ACT-1 IN ALL LOCATIONS WHERE ACOUSTICAL CEILING PANEL IS SHOWN UNLESS OTHERWISE NOTED.
- ALL GYPSUM BOARD CEILINGS TO BE FRAMED WITH 3 5/8" 20 GA. METAL STUDS @ 16" O.C. UNLESS NOTED SOFFIT AND GYPSUM WALLBOARD CEILING PAINT COLORS AND FINISHES ARE INDICATED ON REFLECTED CEILING PLANS OR INTERIOR DRAWINGS. PROVIDE FINISH TO ALL VISIBLE FACES OF SOFFITS UNLESS NOTED
- ALL GYPSUM BOARD OR PLASTER CEILINGS TO BE PAINTED PT-3, UNLESS NOTED OTHERWISE.
- ANY EXISTING TO REMAIN CEILING TO BE CLEANED AND PAINTED AS NECESSARY.
- H. REFER TO PLASTER REPAIR NOTES ON A102 IF EXISTING PLASTER CEILINGS TO REMAIN REQUIRE REPAIR.

NEW CONSTRUCTION KEYNOTES:

- EXISTING PLASTER CEILING TO REMAIN. PATCH AND REPAIR AS REQUIRED FOR NEW PAINT FINISH. NEW 5/8" TYPE C GYPSUM BD. ATTACHED DIRECTLY TO UNDERSIDE OF EXISTING WOOD FLOOR JOISTS.
- AFTER INSTALLATION OF GYPSUM BD. TO UNDERSIDE OF FLOOR STRUCTURE, INSTALL A LOWER SUSPENDED GYPSUM BD. CEILING SYSTEM AT HEIGHT SHOWN ON PLAN. 4. NEW 5/8" TYPE C GYPSUM BD. ATTACHED DIRECTLY TO UNDERSIDE OF EXISTING AND NEW WOOD ROOF
- 5. REINSTALL COFFERED CEILING IN ORIGINAL LOCATION PRIOR TO NEW PARTITION INSTALLATION.

CEILING TYPE INDICATIONS

2 x 4 ACOUSTICAL CEILING PANELS (ACT-1) WITH CONCEALED SUSPENDED GRID SYSTEM SEE CEILING DETAIL #3 THIS SHEET

2 x 2 ACOUSTICAL CEILING PANELS (ACT-2) WITH EXPOSED SUSPENDED GRID SYSTEM

INDICATE OPENING THROUGH FLOOR/CEILING/ROOF

GYPSUM BOARD - PAINTED

N.C. NO CEILING ETR EXISTING TO REMAIN

LEGEND

LIGHTING - RECESSED CEILING FIXTURE (REFER TO ELECTRICAL DRAWINGS FOR TYPE)

LIGHTING - PENDENT FIXTURE (REFER TO ELECTRICAL DRAWINGS FOR TYPE)

LIGHTING - SURFACE MOUNTED (REFER TO ELECTRICAL)

LIGHTING - SURFACE MOUNTED (REFER TO ELECTRICAL)

LIGHTING - RECESSED CAN FIXTURE (LETTER DESIGNATION TYPE)

SMOKE DETECTOR - CEILING MOUNTED (REFER TO FIRE PROTECTION)

HEAT DETECTOR - CEILING MOUNTED (REFER TO FIRE PROTECTION)

HVAC SUPPLY (REFER TO MECHANICAL)

HVAC RETURN (REFER TO MECHANICAL)


CONCEALED SPRINKLER HEAD (REFER TO FIRE PROTECTION)

SINGLE FACE EXIT SIGN (REFER TO ELECTRICAL)

DOUBLE FACE EXIT SIGN (REFER TO ELECTRICAL)


CAM< SECURITY CAMERA (REFER TO ELECTRICAL)

CEILING FINISH TAG. REFER TO INTERIOR DWGS FOR COLOR AND FINISH LEGEND

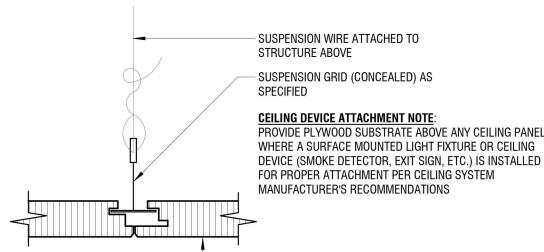

CEILING PANEL AS SPECIFIED

3 CEILING PANEL DETAIL A111 SCALE: 6" = 1'-0"

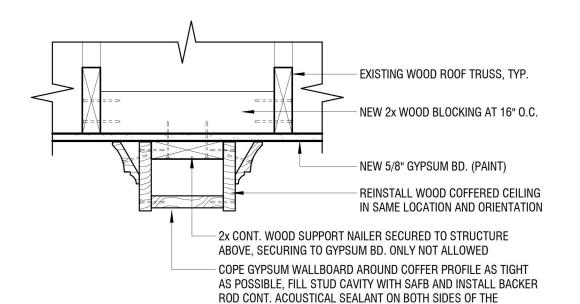

4 TYP. COFFERED CEILING DETAIL A111 | SCALE: 1 1/2" = 1'-0"

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ESD PROJECT No. 135,035


ACADEMIC INNOVATION HUB - WORK FORCE DEVELOPMENT TRAINING

822 CLEVELAND AVENUE NIAGARA FALLS, NEW YORK 14305

NO: DATE: DESCRIPTION: Revisions PROJECT NUMBER: 2221723 DRAWN BY: **JMR** REVIEWED BY: ISSUED FOR: BID DATE: APRIL 11, 2024

> REFLECTED CEILING **PLANS**

DRAWING NUMBER:

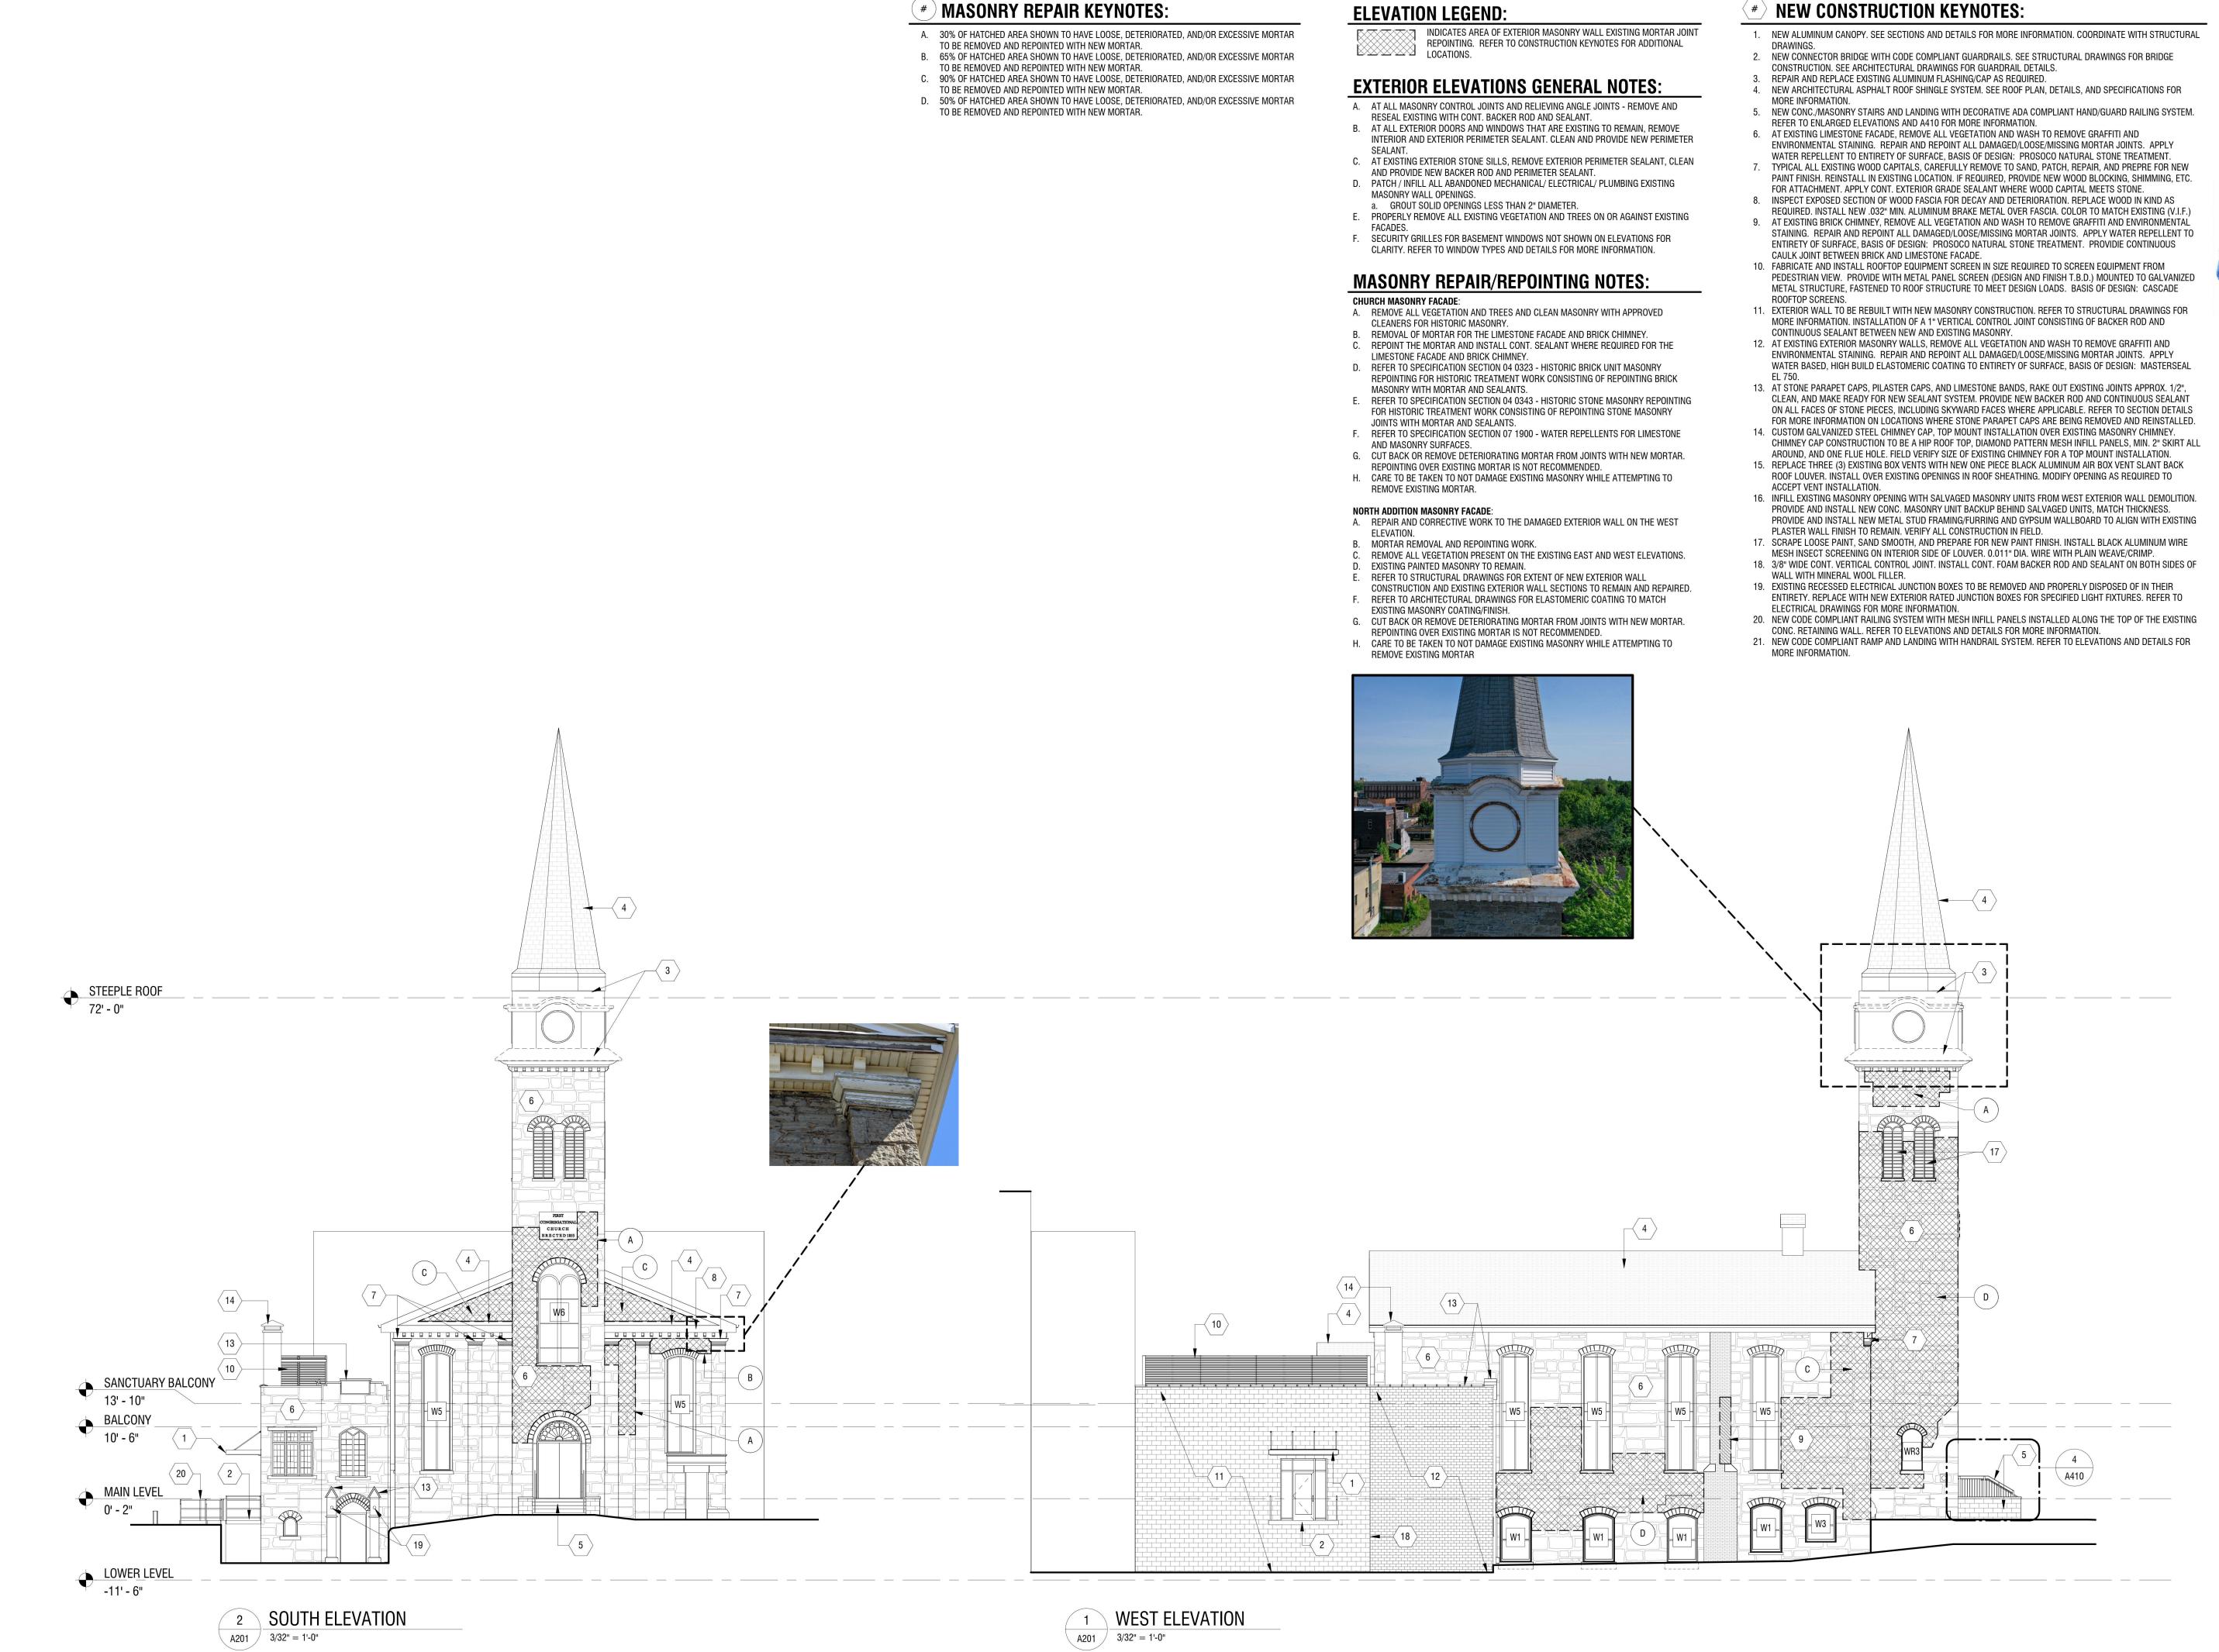



LaBella
Powered by partnership

300 Pearl Street, Suite 130 Buffalo, NY 14202

716-551-6281 labellapc.com



EXP: 07/31/2024

CERTIFICATE OF AUTHORIZATION NUMBER: PROFESSIONAL ENGINEERING: 018281 LAND SURVEYING: 017976 GEOLOGICAL: 018750

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EDA PROJECT No. 01-01-15369 HUD PROJECT No. B-23-CP-NY-1083



SD PROJECT No. 135.035

ACADEMIC INNOVATION HUB - WORK FORCE DEVELOPMENT TRAINING

822 CLEVELAND AVENUE NIAGARA FALLS, NEW YORK 14305

NO:	DATE:	DESCRIPTION	:
Revisions			
PROJECT N	NUMBER:	2221723	
DRAWN BY:		JMR	
REVIEWED BY:		TBD	
ISSUED FO	PR:	BID	
DATE:		APRIL 11, 2024	

EXTERIOR ELEVATIONS

DRAWING NUMBER:

DRAWING NAME:

(*) MASONRY REPAIR KEYNOTES:

- A. 30% OF HATCHED AREA SHOWN TO HAVE LOOSE, DETERIORATED, AND/OR EXCESSIVE MORTAR TO BE REMOVED AND REPOINTED WITH NEW MORTAR.
- B. 65% OF HATCHED AREA SHOWN TO HAVE LOOSE, DETERIORATED, AND/OR EXCESSIVE MORTAR TO BE REMOVED AND REPOINTED WITH NEW MORTAR.
- C. 90% OF HATCHED AREA SHOWN TO HAVE LOOSE, DETERIORATED, AND/OR EXCESSIVE MORTAR
- TO BE REMOVED AND REPOINTED WITH NEW MORTAR. D. 50% OF HATCHED AREA SHOWN TO HAVE LOOSE, DETERIORATED, AND/OR EXCESSIVE MORTAR TO BE REMOVED AND REPOINTED WITH NEW MORTAR.

ELEVATION LEGEND:

INDICATES AREA OF EXTERIOR MASONRY WALL EXISTING MORTAR JOINT REPOINTING. REFER TO CONSTRUCTION KEYNOTES FOR ADDITIONAL LOCATIONS.

EXTERIOR ELEVATIONS GENERAL NOTES:

- A. AT ALL MASONRY CONTROL JOINTS AND RELIEVING ANGLE JOINTS REMOVE AND RESEAL EXISTING WITH CONT. BACKER ROD AND SEALANT.
- B. AT ALL EXTERIOR DOORS AND WINDOWS THAT ARE EXISTING TO REMAIN, REMOVE INTERIOR AND EXTERIOR PERIMETER SEALANT. CLEAN AND PROVIDE NEW PERIMETER
- C. AT EXISTING EXTERIOR STONE SILLS, REMOVE EXTERIOR PERIMETER SEALANT, CLEAN AND PROVIDE NEW BACKER ROD AND PERIMETER SEALANT. D. PATCH / INFILL ALL ABANDONED MECHANICAL/ ELECTRICAL/ PLUMBING EXISTING
- MASONRY WALL OPENINGS.
- a. GROUT SOLID OPENINGS LESS THAN 2" DIAMETER. E. PROPERLY REMOVE ALL EXISTING VEGETATION AND TREES ON OR AGAINST EXISTING
- F. SECURITY GRILLES FOR BASEMENT WINDOWS NOT SHOWN ON ELEVATIONS FOR CLARITY. REFER TO WINDOW TYPES AND DETAILS FOR MORE INFORMATION.

MASONRY REPAIR/REPOINTING NOTES:

- CHURCH MASONRY FACADE:
- A. REMOVE ALL VEGETATION AND TREES AND CLEAN MASONRY WITH APPROVED CLEANERS FOR HISTORIC MASONRY.

REPOINTING FOR HISTORIC TREATMENT WORK CONSISTING OF REPOINTING BRICK

- B. REMOVAL OF MORTAR FOR THE LIMESTONE FACADE AND BRICK CHIMNEY. C. REPOINT THE MORTAR AND INSTALL CONT. SEALANT WHERE REQUIRED FOR THE
- LIMESTONE FACADE AND BRICK CHIMNEY. D. REFER TO SPECIFICATION SECTION 04 0323 - HISTORIC BRICK UNIT MASONRY
- MASONRY WITH MORTAR AND SEALANTS. E. REFER TO SPECIFICATION SECTION 04 0343 - HISTORIC STONE MASONRY REPOINTING FOR HISTORIC TREATMENT WORK CONSISTING OF REPOINTING STONE MASONRY
- JOINTS WITH MORTAR AND SEALANTS. F. REFER TO SPECIFICATION SECTION 07 1900 - WATER REPELLENTS FOR LIMESTONE AND MASONRY SURFACES.
- G. CUT BACK OR REMOVE DETERIORATING MORTAR FROM JOINTS WITH NEW MORTAR. REPOINTING OVER EXISTING MORTAR IS NOT RECOMMENDED.
- H. CARE TO BE TAKEN TO NOT DAMAGE EXISTING MASONRY WHILE ATTEMPTING TO REMOVE EXISTING MORTAR.

NORTH ADDITION MASONRY FACADE:

A. REPAIR AND CORRECTIVE WORK TO THE DAMAGED EXTERIOR WALL ON THE WEST ELEVATION.

- B. MORTAR REMOVAL AND REPOINTING WORK.
- REMOVE ALL VEGETATION PRESENT ON THE EXISTING EAST AND WEST ELEVATIONS. EXISTING PAINTED MASONRY TO REMAIN
- REFER TO STRUCTURAL DRAWINGS FOR EXTENT OF NEW EXTERIOR WALL CONSTRUCTION AND EXISTING EXTERIOR WALL SECTIONS TO REMAIN AND REPAIRED. F. REFER TO ARCHITECTURAL DRAWINGS FOR ELASTOMERIC COATING TO MATCH
- EXISTING MASONRY COATING/FINISH. G. CUT BACK OR REMOVE DETERIORATING MORTAR FROM JOINTS WITH NEW MORTAR.
- REPOINTING OVER EXISTING MORTAR IS NOT RECOMMENDED. H. CARE TO BE TAKEN TO NOT DAMAGE EXISTING MASONRY WHILE ATTEMPTING TO REMOVE EXISTING MORTAR

NEW CONSTRUCTION KEYNOTES:

- 1. NEW ALUMINUM CANOPY. SEE SECTIONS AND DETAILS FOR MORE INFORMATION. COORDINATE WITH STRUCTURAL DRAWINGS.
- 2. NEW CONNECTOR BRIDGE WITH CODE COMPLIANT GUARDRAILS. SEE STRUCTURAL DRAWINGS FOR BRIDGE
- CONSTRUCTION. SEE ARCHITECTURAL DRAWINGS FOR GUARDRAIL DETAILS. 3. REPAIR AND REPLACE EXISTING ALUMINUM FLASHING/CAP AS REQUIRED.
- 4. NEW ARCHITECTURAL ASPHALT ROOF SHINGLE SYSTEM. SEE ROOF PLAN, DETAILS, AND SPECIFICATIONS FOR MORE INFORMATION.
- 5. NEW CONC./MASONRY STAIRS AND LANDING WITH DECORATIVE ADA COMPLIANT HAND/GUARD RAILING SYSTEM. REFER TO ENLARGED ELEVATIONS AND A410 FOR MORE INFORMATION.
- 6. AT EXISTING LIMESTONE FACADE, REMOVE ALL VEGETATION AND WASH TO REMOVE GRAFFITI AND ENVIRONMENTAL STAINING. REPAIR AND REPOINT ALL DAMAGED/LOOSE/MISSING MORTAR JOINTS. APPLY
- WATER REPELLENT TO ENTIRETY OF SURFACE, BASIS OF DESIGN: PROSOCO NATURAL STONE TREATMENT. 7. TYPICAL ALL EXISTING WOOD CAPITALS, CAREFULLY REMOVE TO SAND, PATCH, REPAIR, AND PREPRE FOR NEW PAINT FINISH. REINSTALL IN EXISTING LOCATION. IF REQUIRED, PROVIDE NEW WOOD BLOCKING, SHIMMING, ETC. FOR ATTACHMENT. APPLY CONT. EXTERIOR GRADE SEALANT WHERE WOOD CAPITAL MEETS STONE.
- 8. INSPECT EXPOSED SECTION OF WOOD FASCIA FOR DECAY AND DETERIORATION. REPLACE WOOD IN KIND AS REQUIRED. INSTALL NEW .032" MIN. ALUMINUM BRAKE METAL OVER FASCIA. COLOR TO MATCH EXISTING (V.I.F.) 9. AT EXISTING BRICK CHIMNEY, REMOVE ALL VEGETATION AND WASH TO REMOVE GRAFFITI AND ENVIRONMENTAL
- STAINING. REPAIR AND REPOINT ALL DAMAGED/LOOSE/MISSING MORTAR JOINTS. APPLY WATER REPELLENT TO ENTIRETY OF SURFACE, BASIS OF DESIGN: PROSOCO NATURAL STONE TREATMENT. PROVIDIE CONTINUOUS CAULK JOINT BETWEEN BRICK AND LIMESTONE FACADE. 10. FABRICATE AND INSTALL ROOFTOP EQUIPMENT SCREEN IN SIZE REQUIRED TO SCREEN EQUIPMENT FROM
- PEDESTRIAN VIEW. PROVIDE WITH METAL PANEL SCREEN (DESIGN AND FINISH T.B.D.) MOUNTED TO GALVANIZED METAL STRUCTURE, FASTENED TO ROOF STRUCTURE TO MEET DESIGN LOADS. BASIS OF DESIGN: CASCADE 11. EXTERIOR WALL TO BE REBUILT WITH NEW MASONRY CONSTRUCTION. REFER TO STRUCTURAL DRAWINGS FOR
- MORE INFORMATION. INSTALLATION OF A 1" VERTICAL CONTROL JOINT CONSISTING OF BACKER ROD AND CONTINUOUS SEALANT BETWEEN NEW AND EXISTING MASONRY. 12. AT EXISTING EXTERIOR MASONRY WALLS, REMOVE ALL VEGETATION AND WASH TO REMOVE GRAFFITI AND
- ENVIRONMENTAL STAINING. REPAIR AND REPOINT ALL DAMAGED/LOOSE/MISSING MORTAR JOINTS. APPLY WATER BASED, HIGH BUILD ELASTOMERIC COATING TO ENTIRETY OF SURFACE, BASIS OF DESIGN: MASTERSEAL 13. AT STONE PARAPET CAPS, PILASTER CAPS, AND LIMESTONE BANDS, RAKE OUT EXISTING JOINTS APPROX. 1/2",
- CLEAN, AND MAKE READY FOR NEW SEALANT SYSTEM. PROVIDE NEW BACKER ROD AND CONTINUOUS SEALANT ON ALL FACES OF STONE PIECES, INCLUDING SKYWARD FACES WHERE APPLICABLE. REFER TO SECTION DETAILS FOR MORE INFORMATION ON LOCATIONS WHERE STONE PARAPET CAPS ARE BEING REMOVED AND REINSTALLED.
- 14. CUSTOM GALVANIZED STEEL CHIMNEY CAP, TOP MOUNT INSTALLATION OVER EXISTING MASONRY CHIMNEY. CHIMNEY CAP CONSTRUCTION TO BE A HIP ROOF TOP, DIAMOND PATTERN MESH INFILL PANELS, MIN. 2" SKIRT ALL AROUND, AND ONE FLUE HOLE. FIELD VERIFY SIZE OF EXISTING CHIMNEY FOR A TOP MOUNT INSTALLATION. 15. REPLACE THREE (3) EXISTING BOX VENTS WITH NEW ONE PIECE BLACK ALUMINUM AIR BOX VENT SLANT BACK
- ROOF LOUVER. INSTALL OVER EXISTING OPENINGS IN ROOF SHEATHING. MODIFY OPENING AS REQUIRED TO ACCEPT VENT INSTALLATION. 16. INFILL EXISTING MASONRY OPENING WITH SALVAGED MASONRY UNITS FROM WEST EXTERIOR WALL DEMOLITION.
- PROVIDE AND INSTALL NEW CONC. MASONRY UNIT BACKUP BEHIND SALVAGED UNITS, MATCH THICKNESS. PROVIDE AND INSTALL NEW METAL STUD FRAMING/FURRING AND GYPSUM WALLBOARD TO ALIGN WITH EXISTING PLASTER WALL FINISH TO REMAIN. VERIFY ALL CONSTRUCTION IN FIELD. 17. SCRAPE LOOSE PAINT, SAND SMOOTH, AND PREPARE FOR NEW PAINT FINISH, INSTALL BLACK ALUMINUM WIRE
- MESH INSECT SCREENING ON INTERIOR SIDE OF LOUVER. 0.011" DIA. WIRE WITH PLAIN WEAVE/CRIMP. 18. 3/8" WIDE CONT. VERTICAL CONTROL JOINT. INSTALL CONT. FOAM BACKER ROD AND SEALANT ON BOTH SIDES OF WALL WITH MINERAL WOOL FILLER.
- 19. EXISTING RECESSED ELECTRICAL JUNCTION BOXES TO BE REMOVED AND PROPERLY DISPOSED OF IN THEIR ENTIRETY. REPLACE WITH NEW EXTERIOR RATED JUNCTION BOXES FOR SPECIFIED LIGHT FIXTURES. REFER TO ELECTRICAL DRAWINGS FOR MORE INFORMATION.
- 20. NEW CODE COMPLIANT RAILING SYSTEM WITH MESH INFILL PANELS INSTALLED ALONG THE TOP OF THE EXISTING CONC. RETAINING WALL. REFER TO ELEVATIONS AND DETAILS FOR MORE INFORMATION.
- 21. NEW CODE COMPLIANT RAMP AND LANDING WITH HANDRAIL SYSTEM. REFER TO ELEVATIONS AND DETAILS FOR MORE INFORMATION.



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EXP: 07/31/2024

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EDA PROJECT No. 01-01-15369 HUD PROJECT No. B-23-CP-NY-1083



ESD PROJECT No. 135,035

ACADEMIC INNOVATION HUB - WORK FORCE DEVELOPMENT TRAINING


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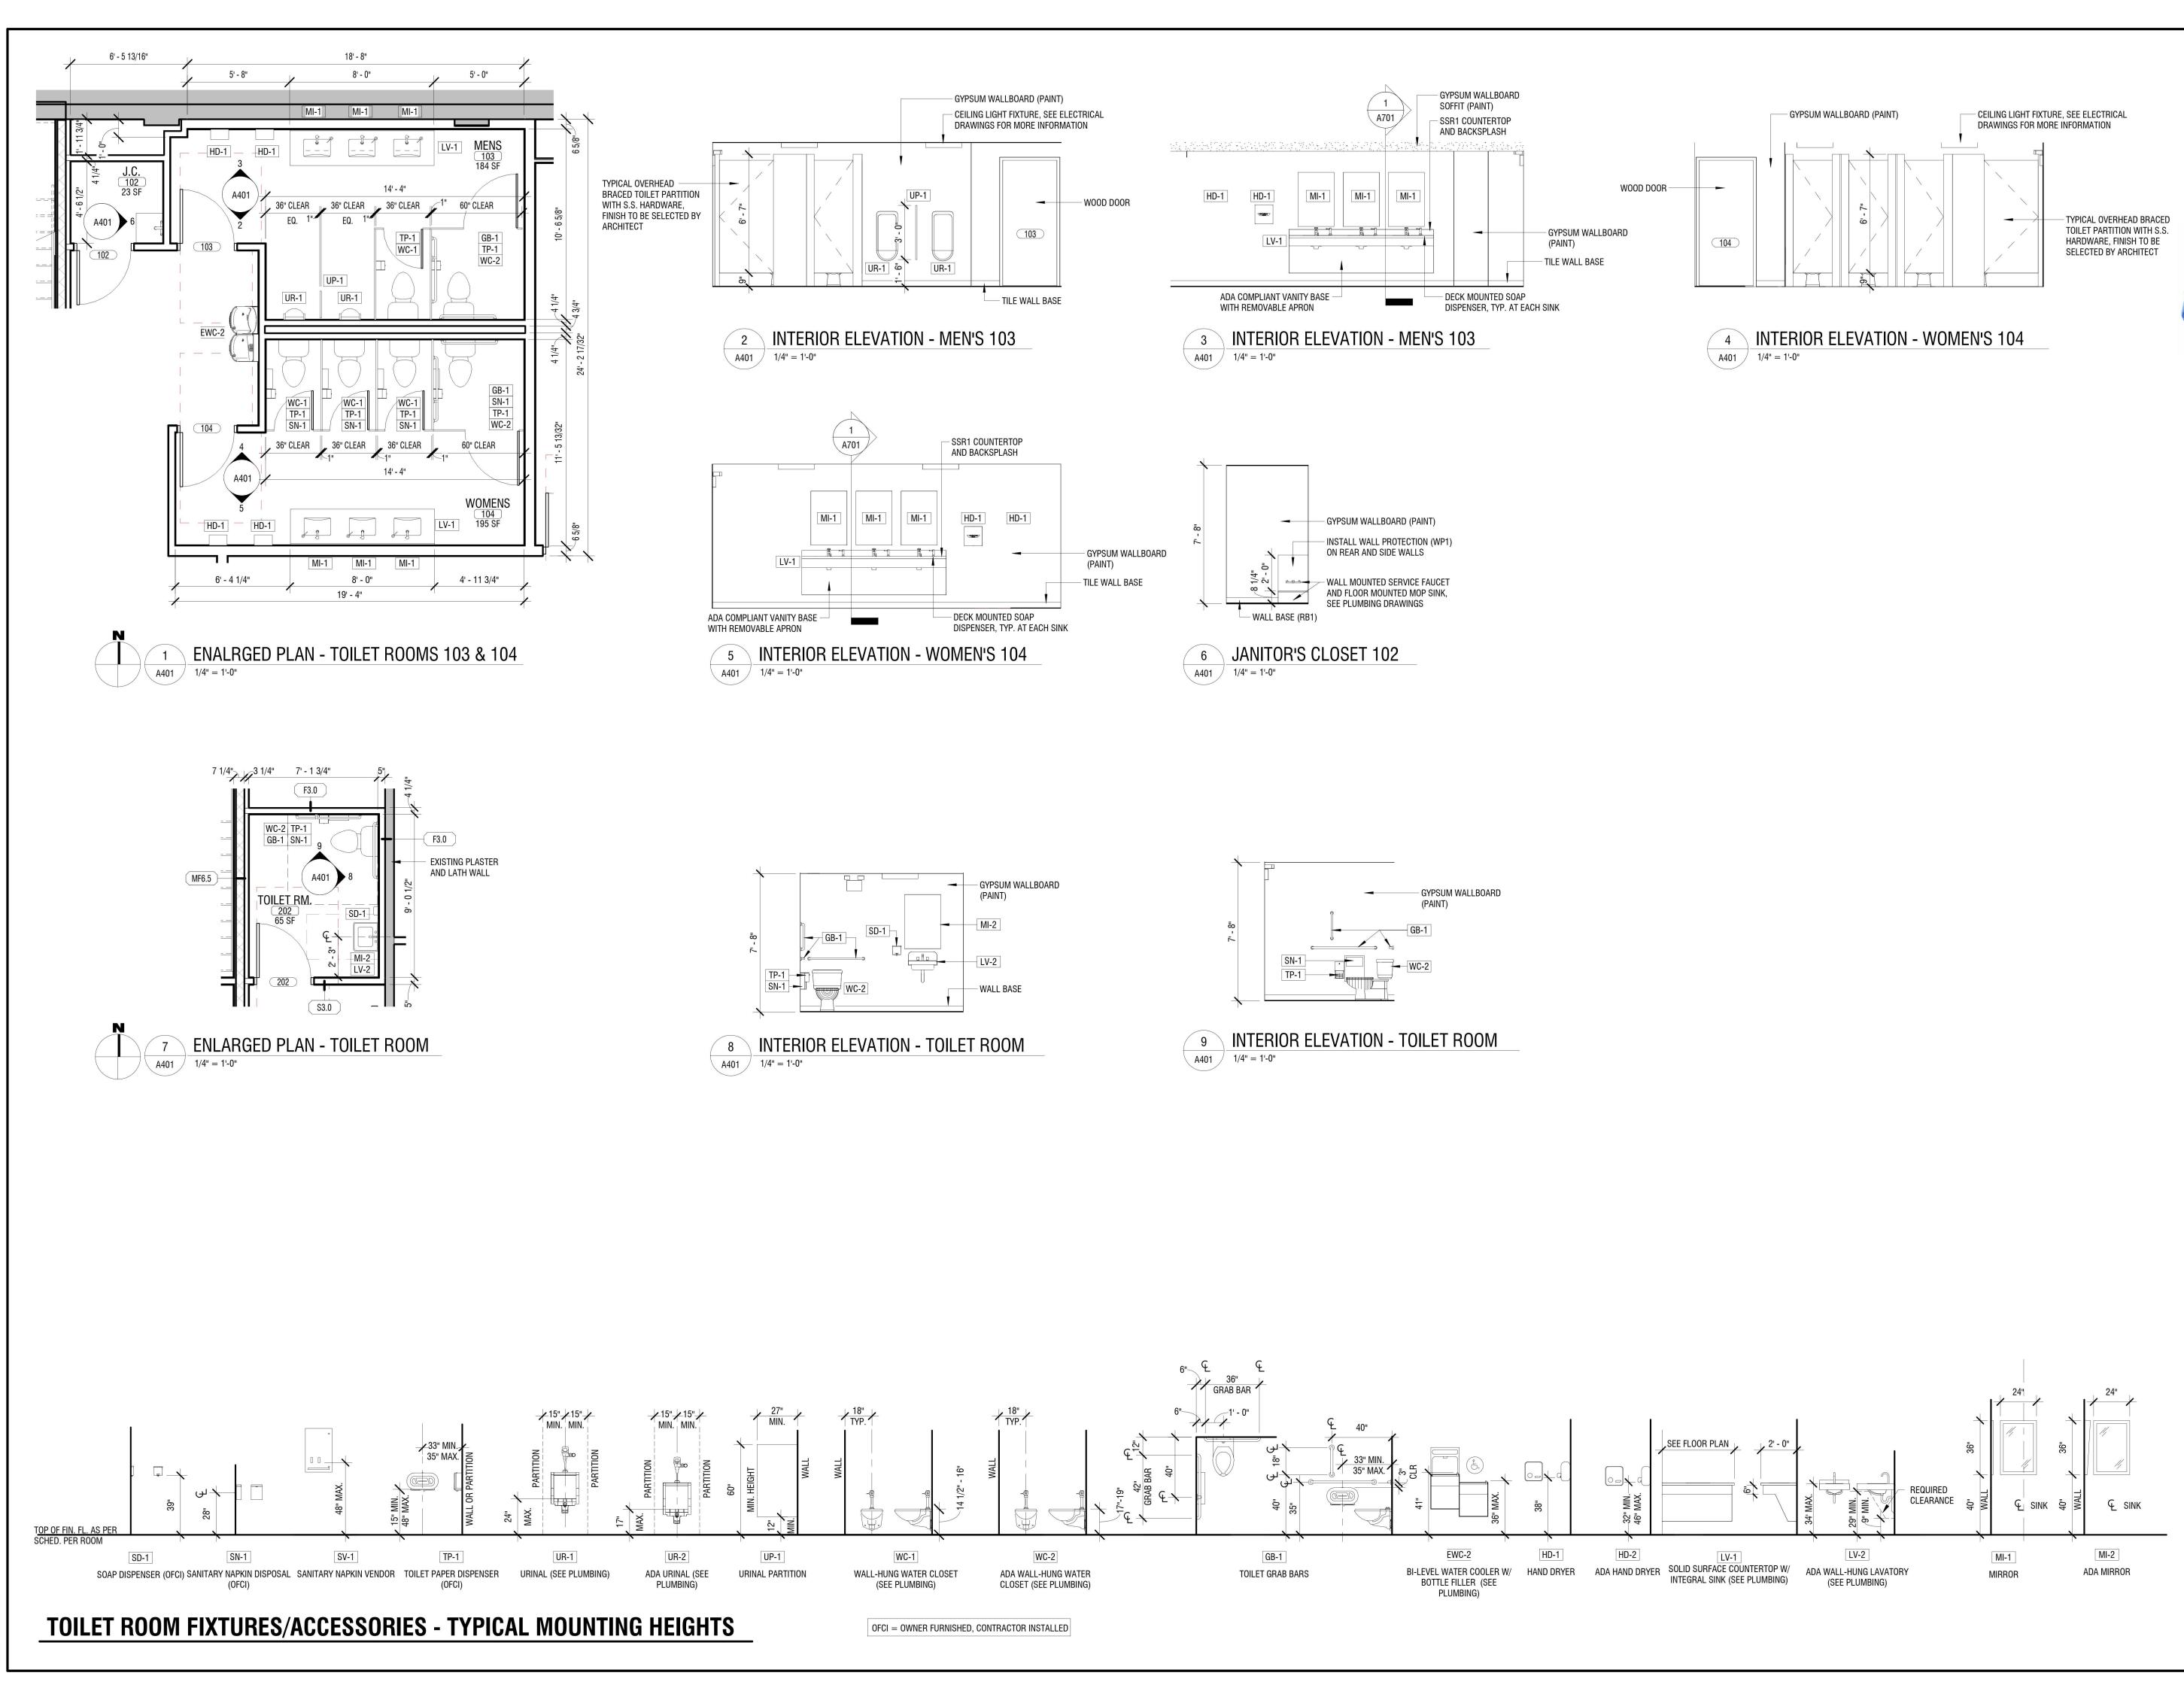
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PROJECT	NUMBER:	2221723
DRAWN B	Y:	JMR
REVIEWED BY:		TBD
ISSUED FO	DR:	BID
DATE:		APRIL 11, 2024

EXTERIOR ELEVATIONS

DRAWING NUMBER:

DRAWING NAME:



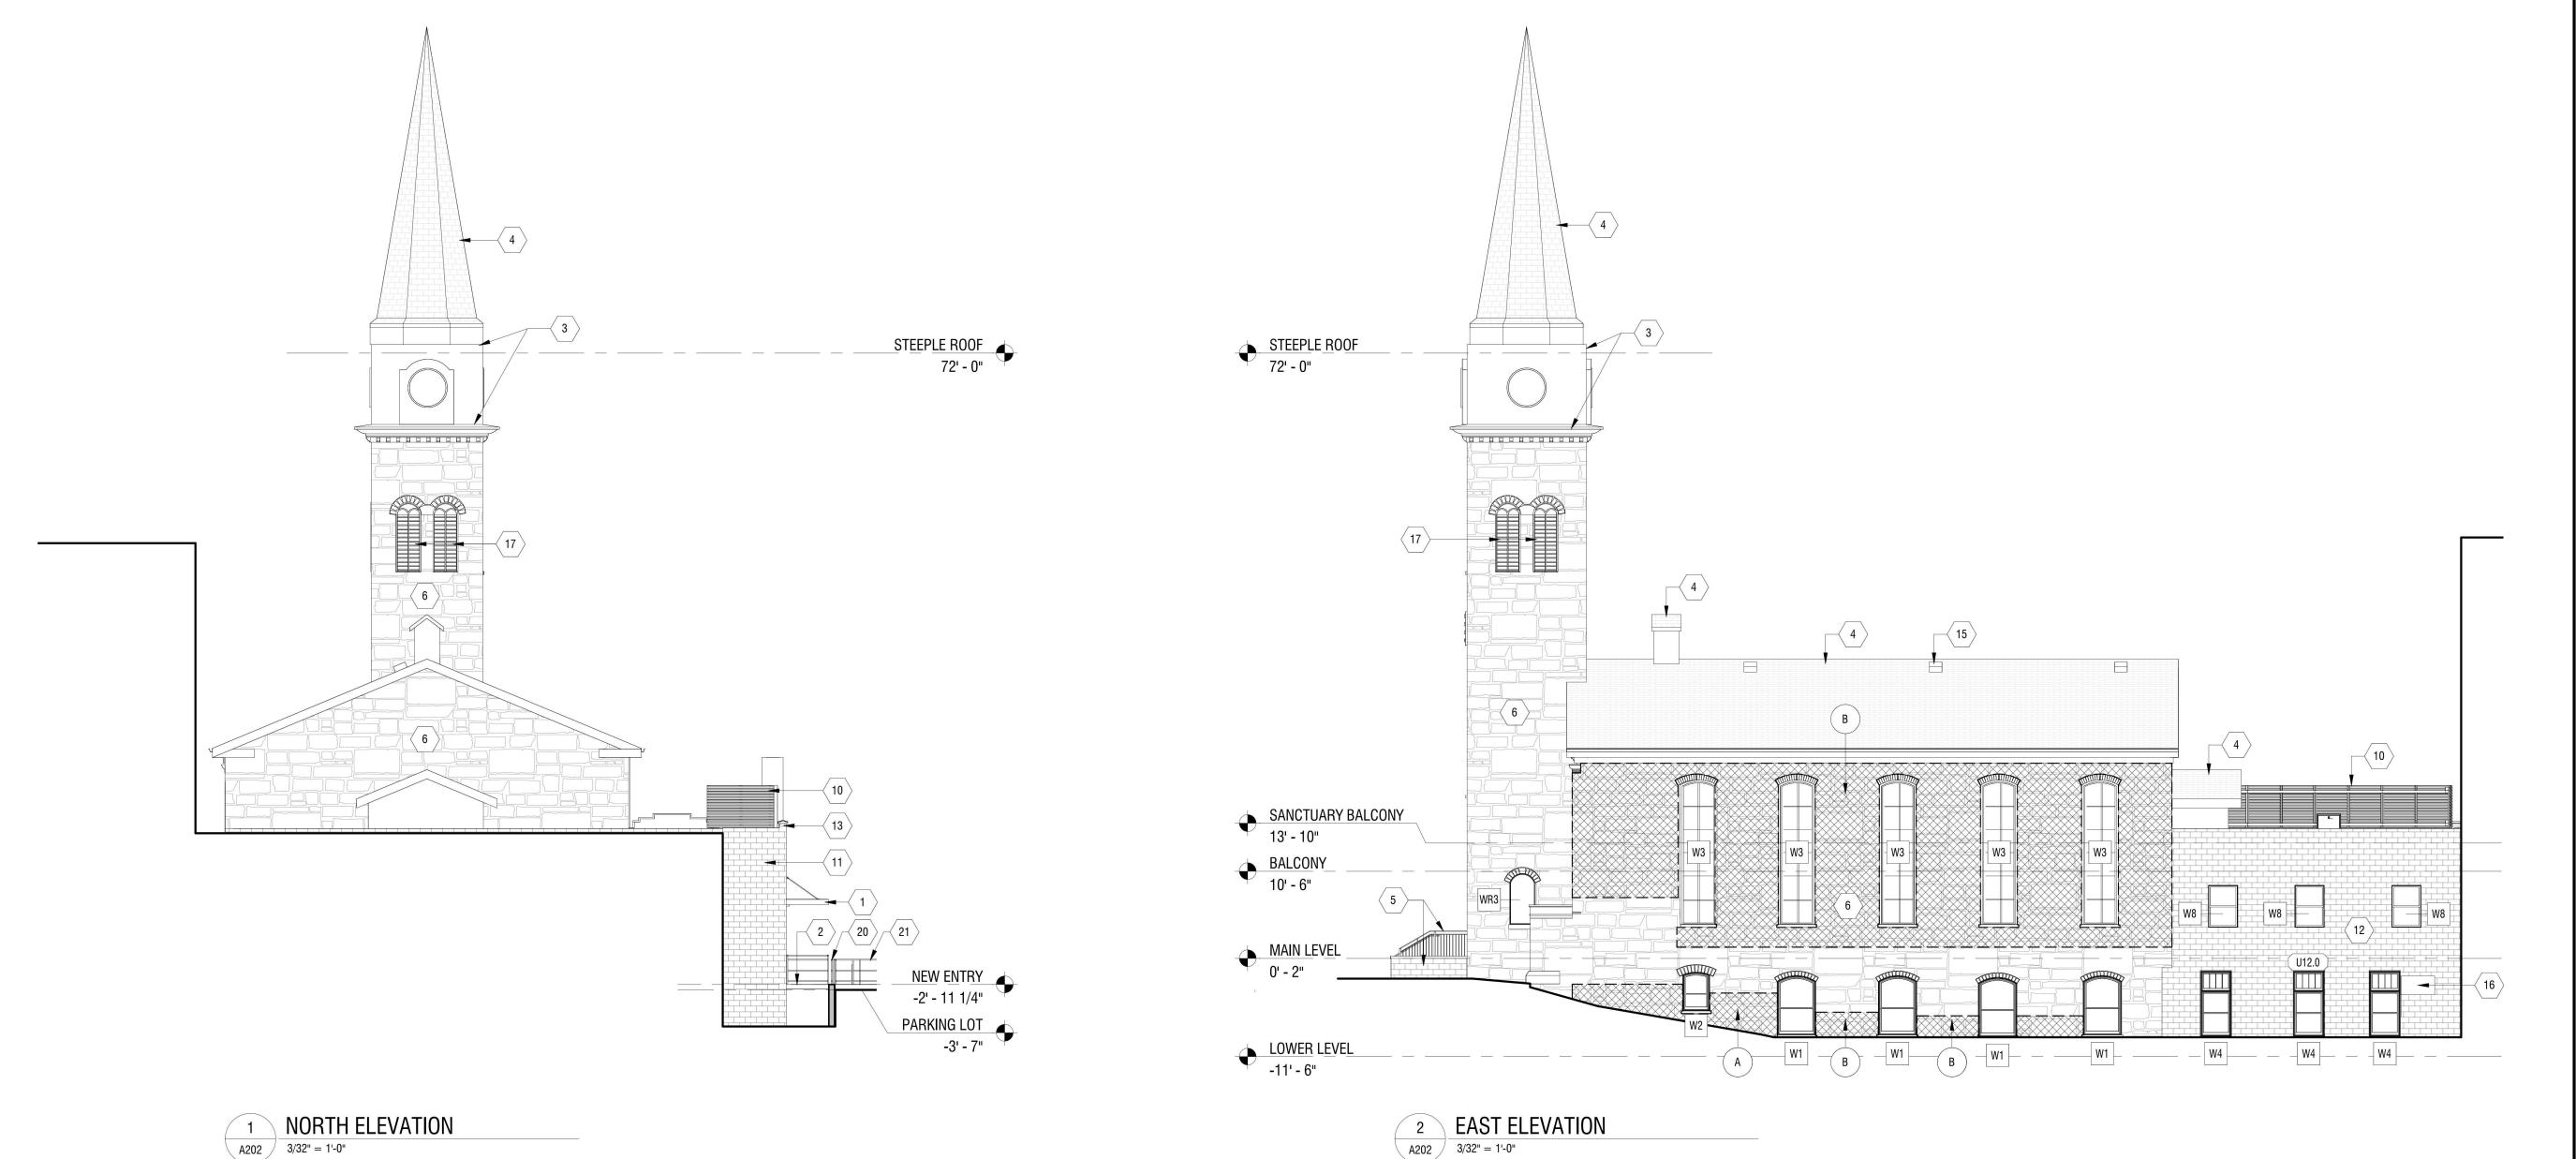

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ESD PROJECT No. 135,035

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822 CLEVELAND AVENUE NIAGARA FALLS, NEW YORK 14305


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PROJECT N	IUMBER:	2221723		
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REVIEWED BY:		TBD		
ISSUED FOR:		BID		
DATE:				

ENLARGED TOILET ROOM PLANS AND INTERIOR

ELEVATIONS

DRAWING NUMBER:

DRAWING NAME:

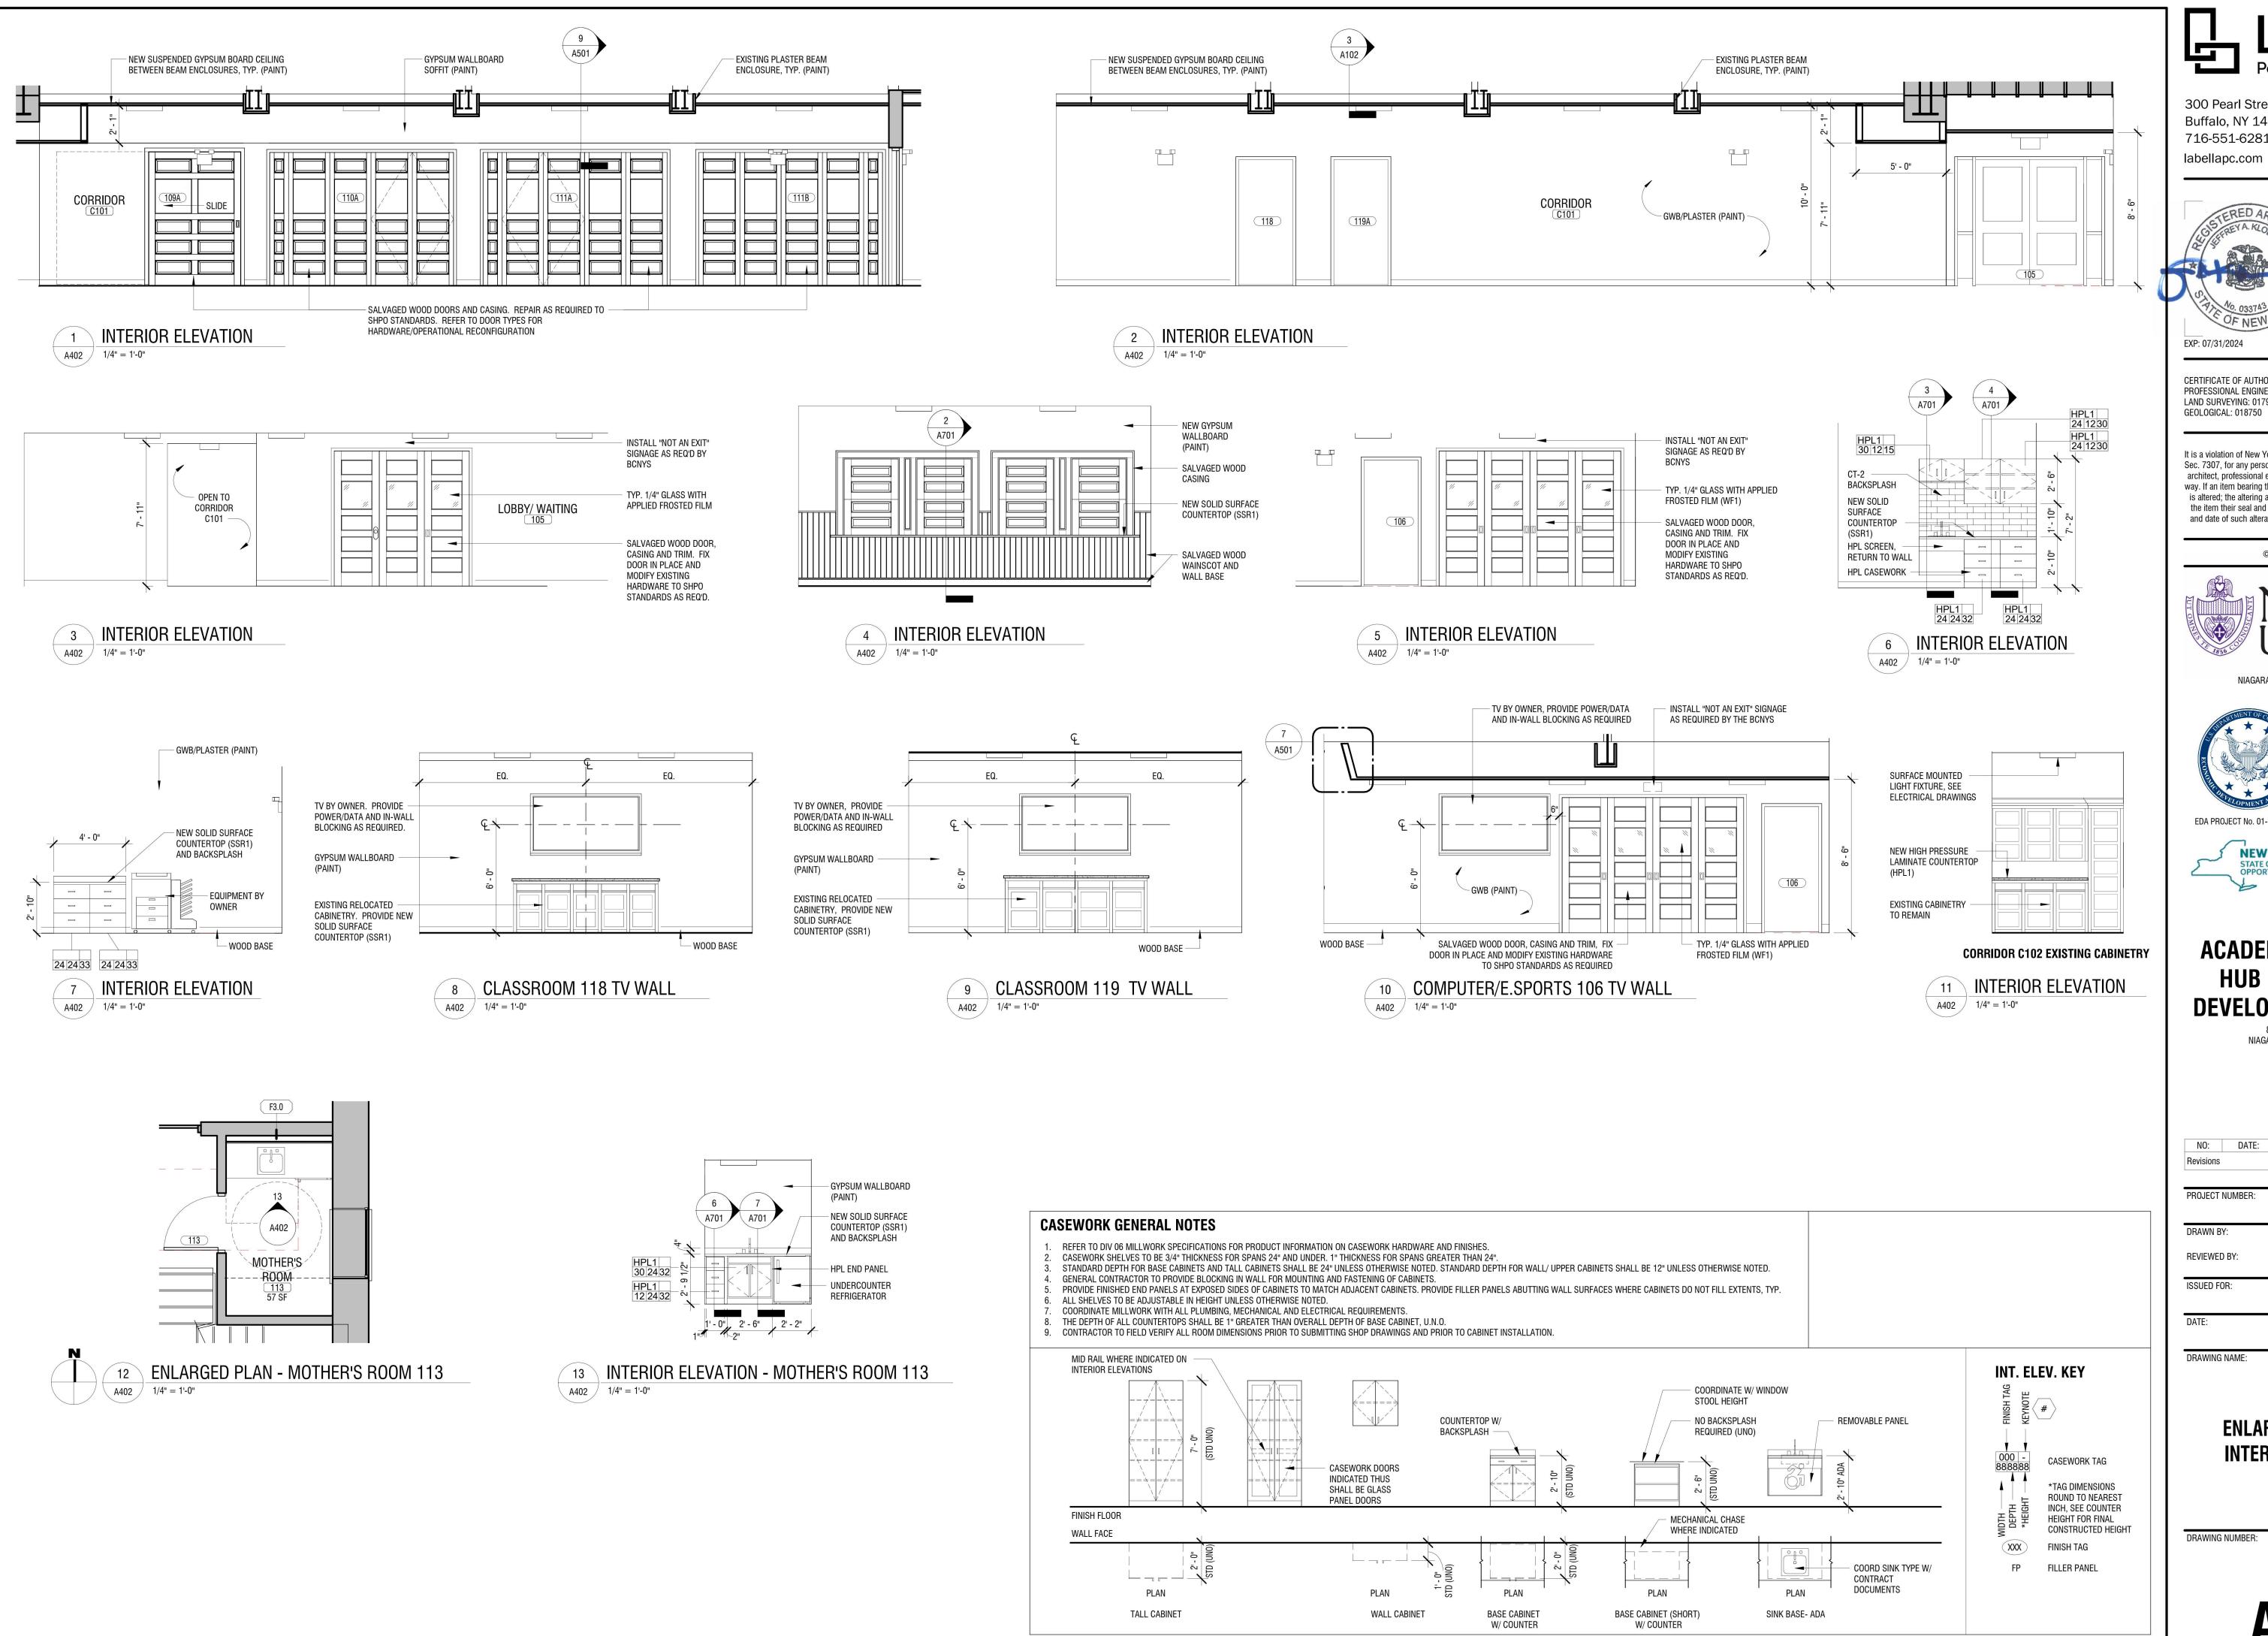

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EDA PROJECT No. 01-01-15369 HUD PROJECT No. B-23-CP-NY-1083 NEW YORK
STATE OF OPPORTUNITY.
Development

ESD PROJECT No. 135,035


ACADEMIC INNOVATION HUB - WORK FORCE DEVELOPMENT TRAINING

822 CLEVELAND AVENUE NIAGARA FALLS, NEW YORK 14305


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PROJECT N	NUMBER:	2221723		
DRAWN BY:		JMR		
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DATE:		APRIL 11, 2024		
DRAWING	NAME:			


ENLARGED PLANS AND INTERIOR ELEVATIONS


DRAWING NUMBER:

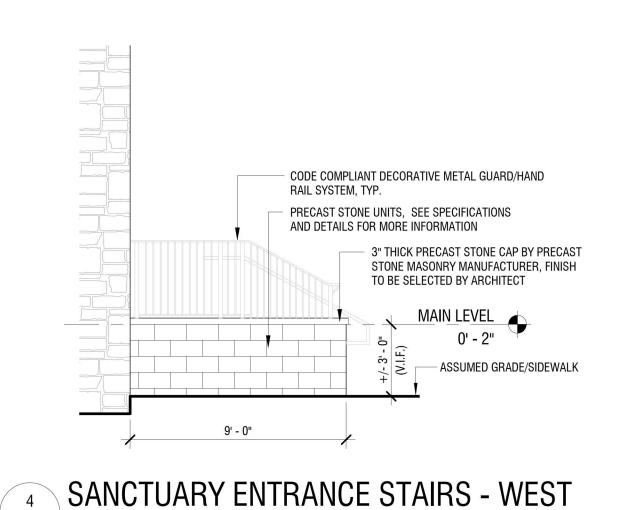

A410 SCALE: 1/4" = 1'-0"

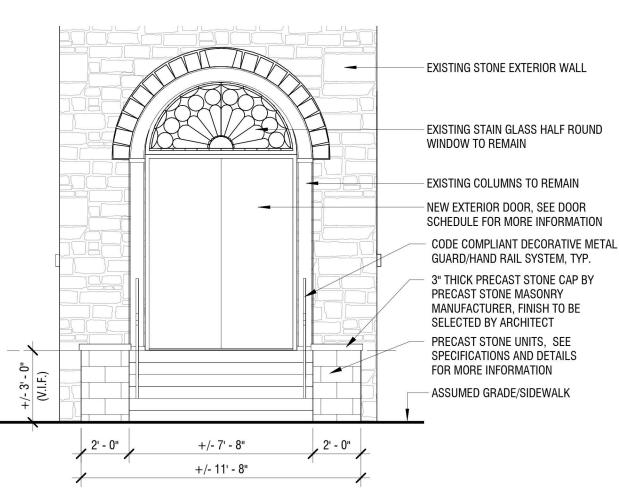

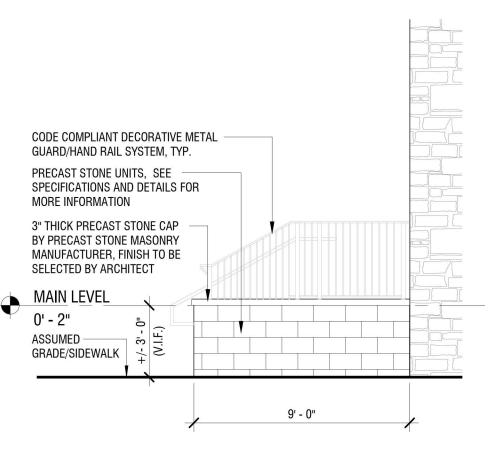


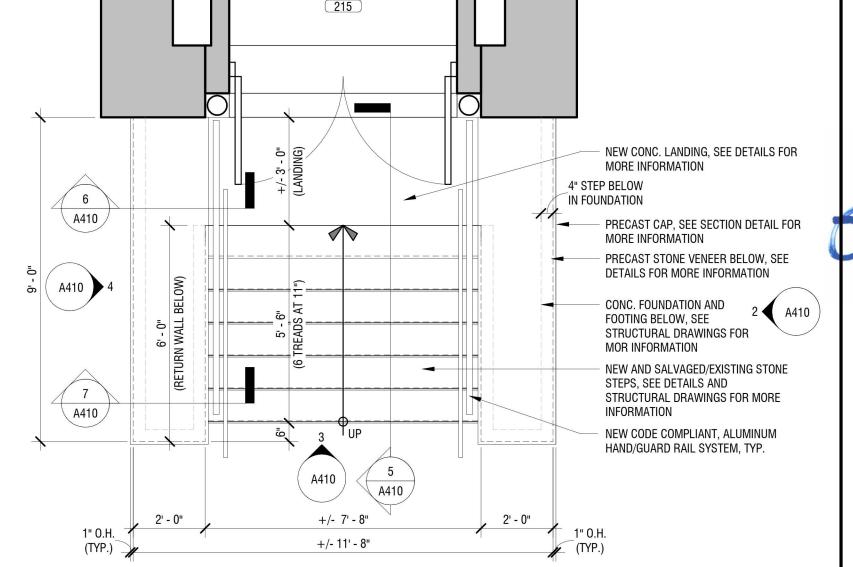


ENLARGED EXTERIOR STAIR PLAN A410 SCALE: 3/8" = 1'-0"

3 SANCTUARY ENTRANCE STAIRS - SOUTH A410 SCALE: 1/4" = 1'-0"


SANCTUARY ENTRANCE STAIRS - EAST A410 SCALE: 1/4" = 1'-0"

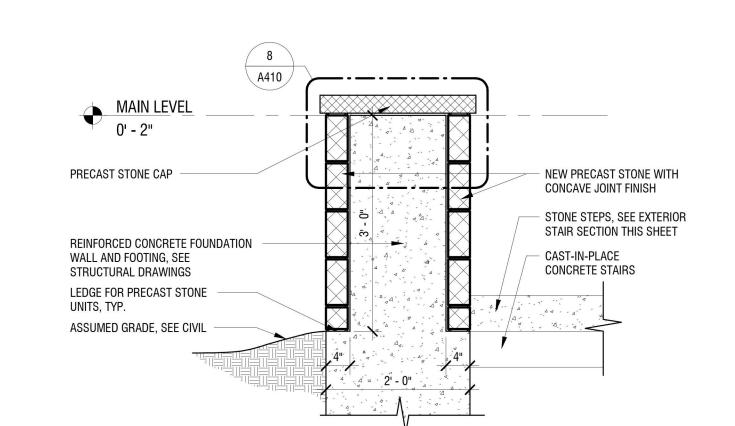

7 STAIR WALL SECTION A410 SCALE: 3/4" = 1'-0"

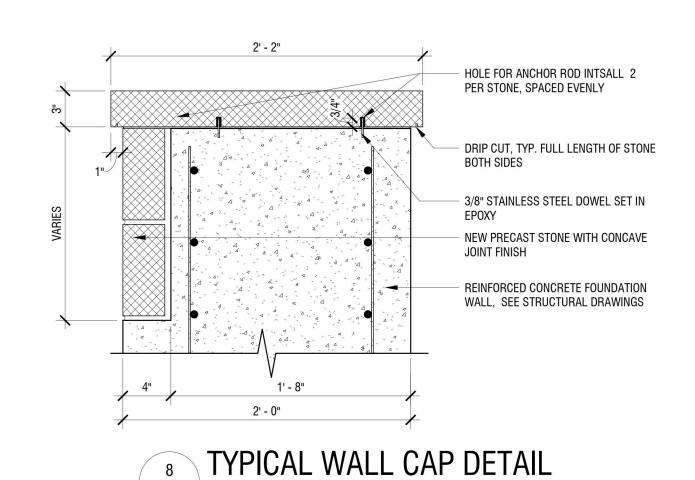

A410 SCALE: 1 1/2" = 1'-0"

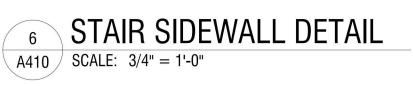



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EDA PROJECT No. 01-01-15369 HUD PROJECT No. B-23-CP-NY-1083

NEW YORK
STATE OF OPPORTUNITY.
Development ESD PROJECT No. 135,035

ACADEMIC INNOVATION HUB - WORK FORCE DEVELOPMENT TRAINING


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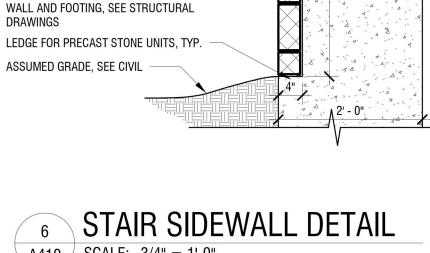
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PROJECT	NUMBEK:	2221723		
DRAWN B	Y:	JMR		
REVIEWED BY:		JAK		
ISSUED FO	DR:	BID		
DATE:		APRIL 11, 2024		

MAIN ENTRANCE EXTERIOR

DRAWING NUMBER:

DRAWING NAME:



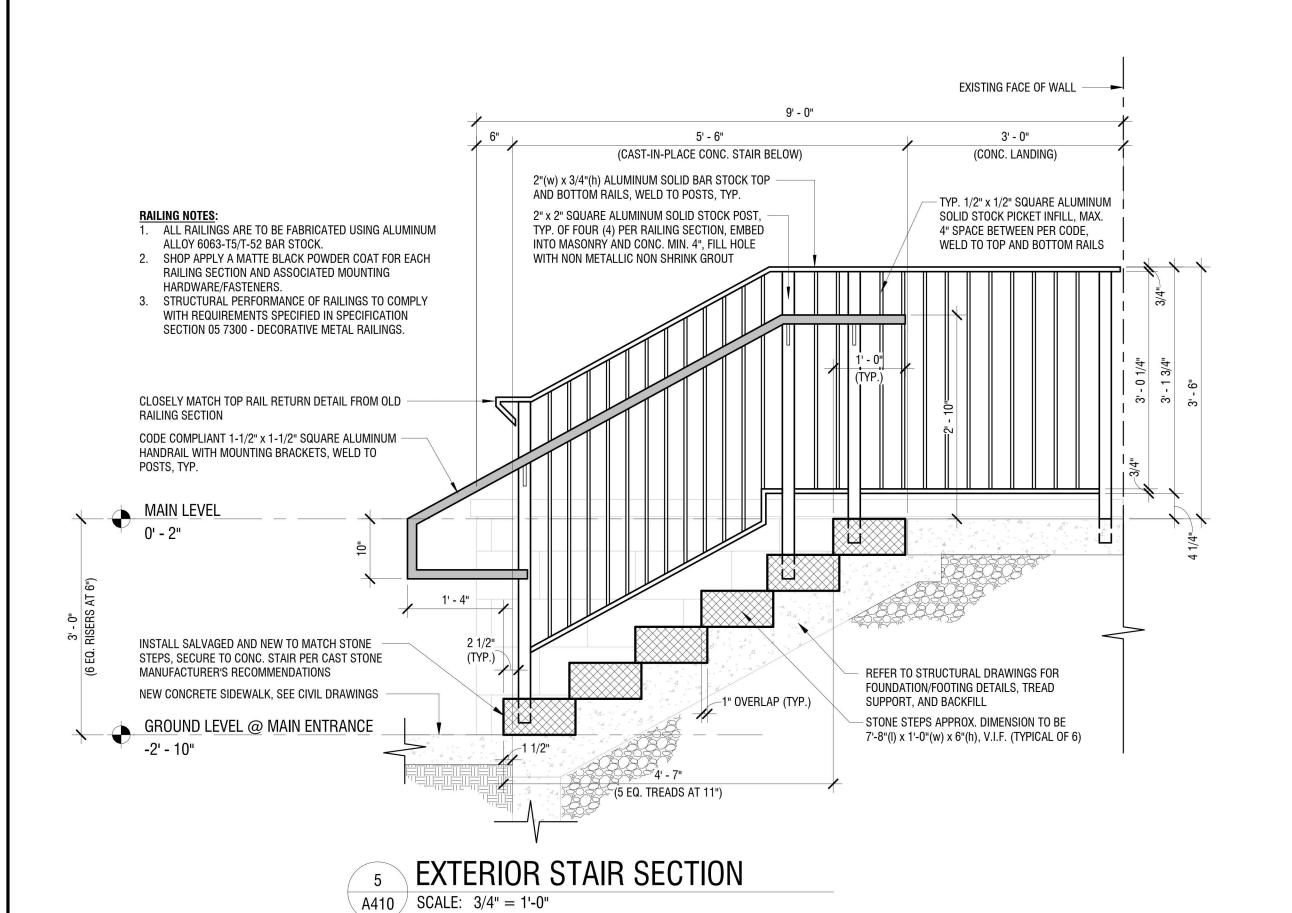

8

NEW CODE COMPLIANT GUARD/HAND

3" THICK PRECAST STONE CAP

REINFORCED CONCRETE FLOOR


GROUT BEHIND, TYP.

SLAB, SEE STRUCTURAL DRAWINGS

PRECAST STONE UNITS WITH SOLID

REINFORCED CONCRETE FOUNDATION

RAILING SYSTEM

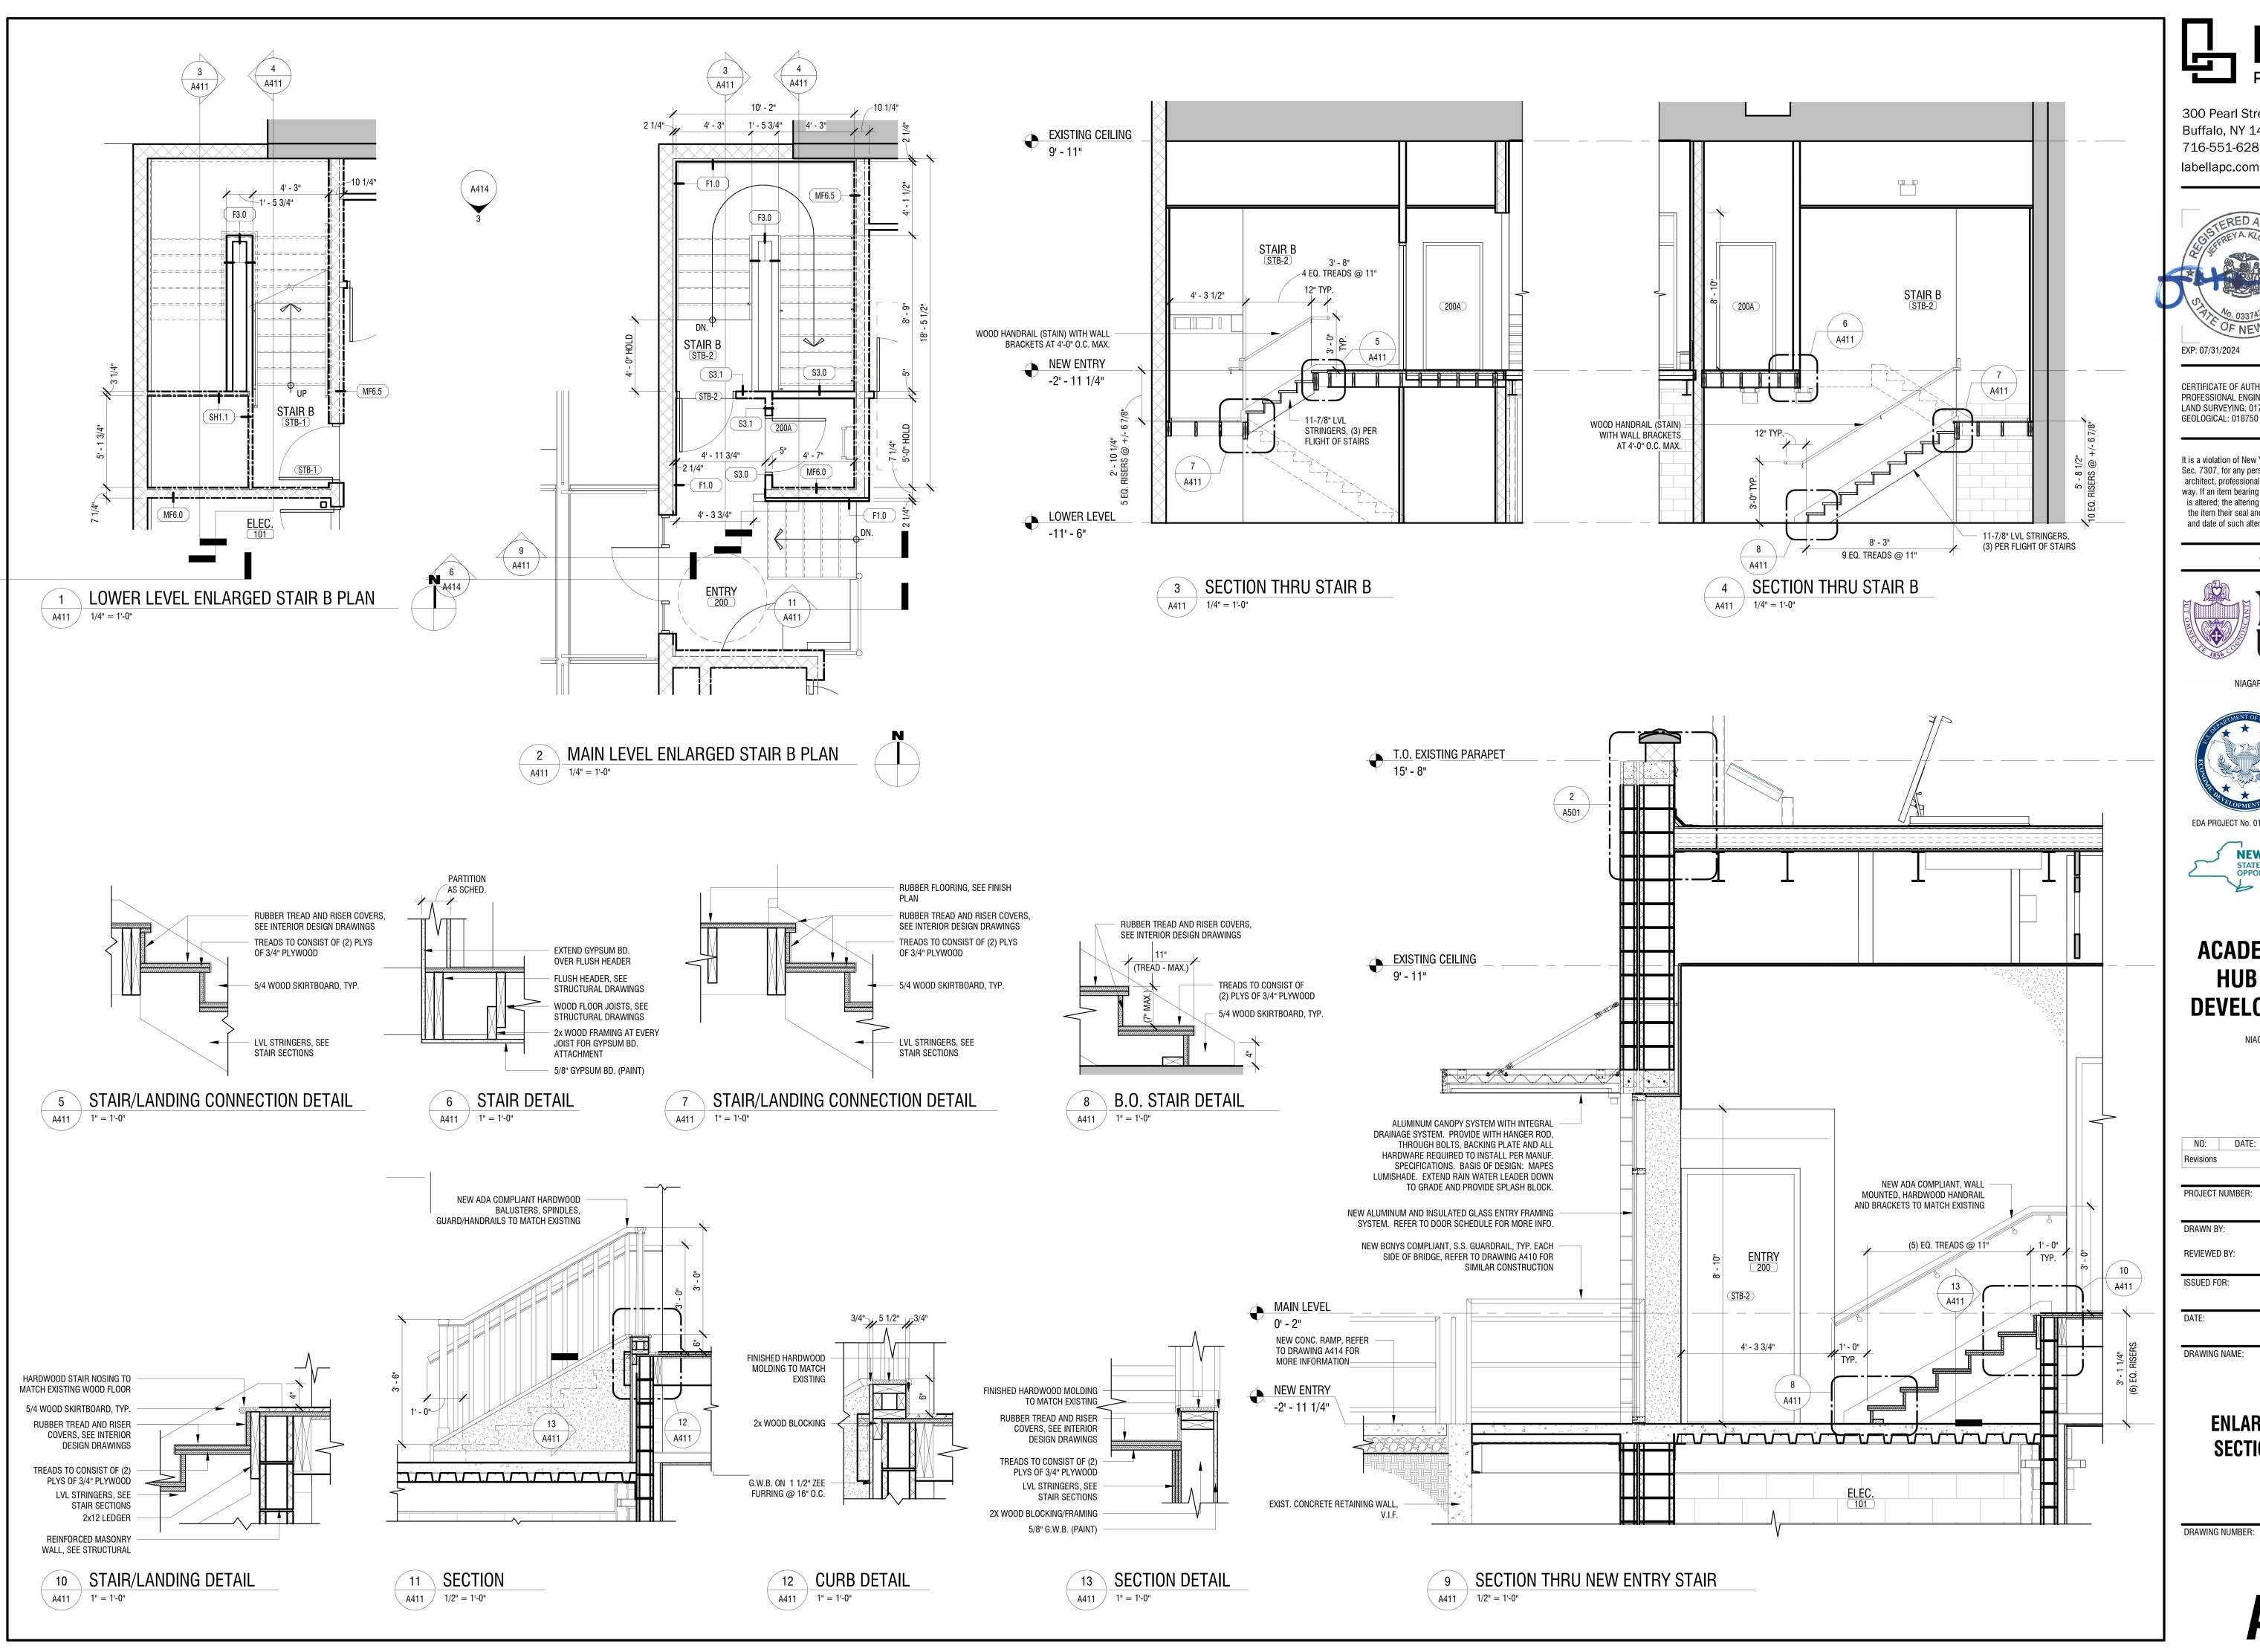



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EDA PROJECT No. 01-01-15369 HUD PROJECT No. B-23-CP-NY-1083



ESD PROJECT No. 135,035


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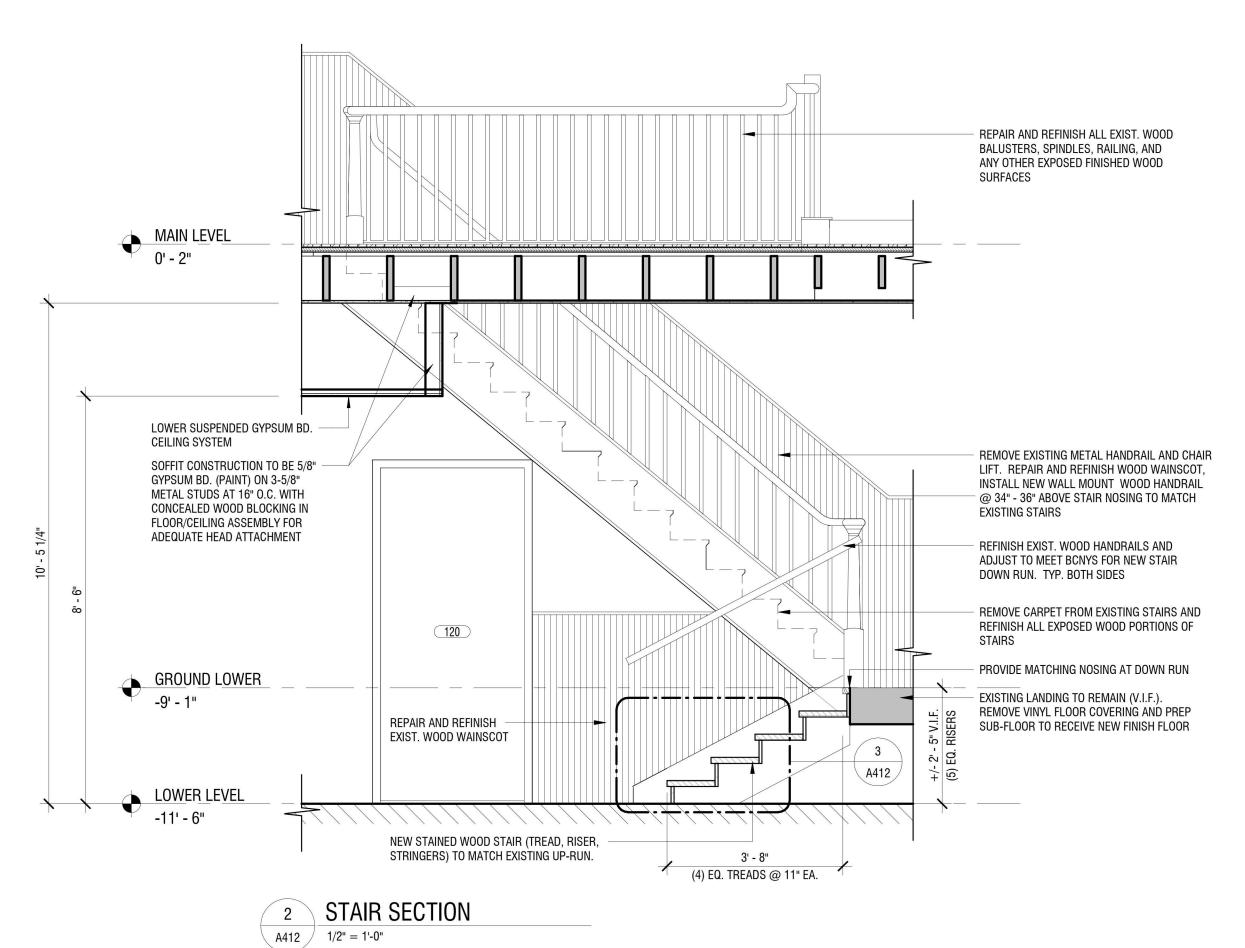
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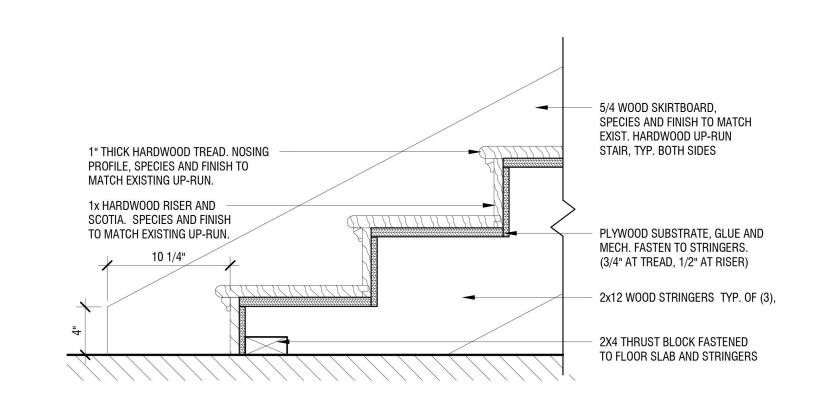
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ENLARGED STAIR PLANS, SECTIONS, AND DETAILS

DRAWING NUMBER:





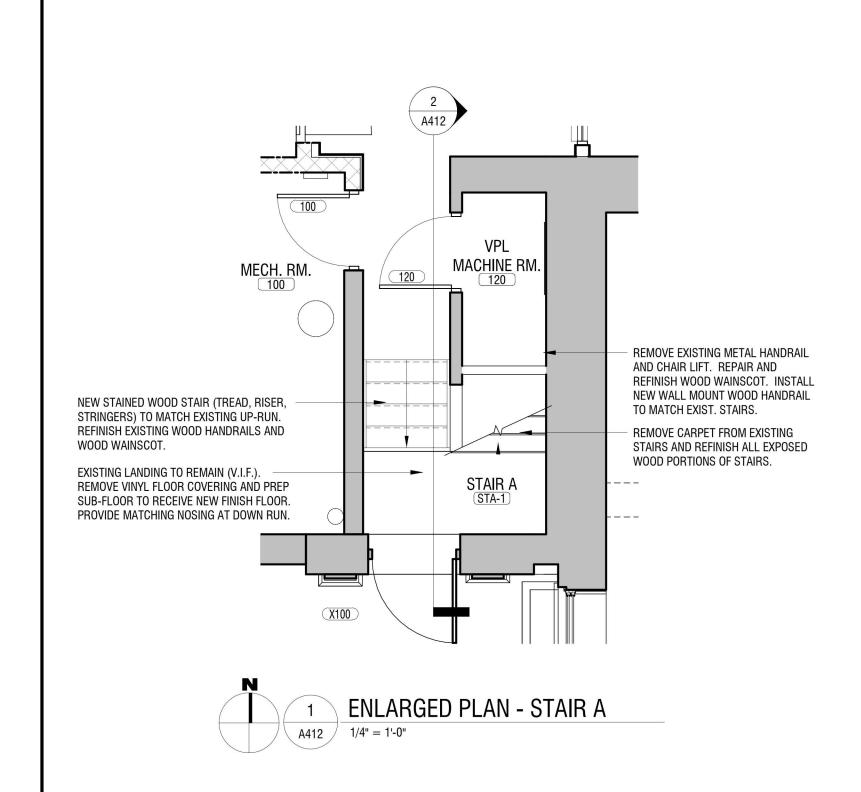

3 TYP. HARDWOOD STAIR DETAIL

A412 1 1/2" = 1'-0"



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EXP: 07/31/20

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EDA PROJECT No. 01-01-15369 HUD PROJECT No. B-23-CP-NY-1083



FSD PROJECT No. 135 035

ACADEMIC INNOVATION HUB - WORK FORCE DEVELOPMENT TRAINING


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DATE:		APRIL 11, 2024	

ENLARGED STAIR PLANS, SECTIONS, AND DETAILS

DRAWING NUMBER:

DRAWING NAME:



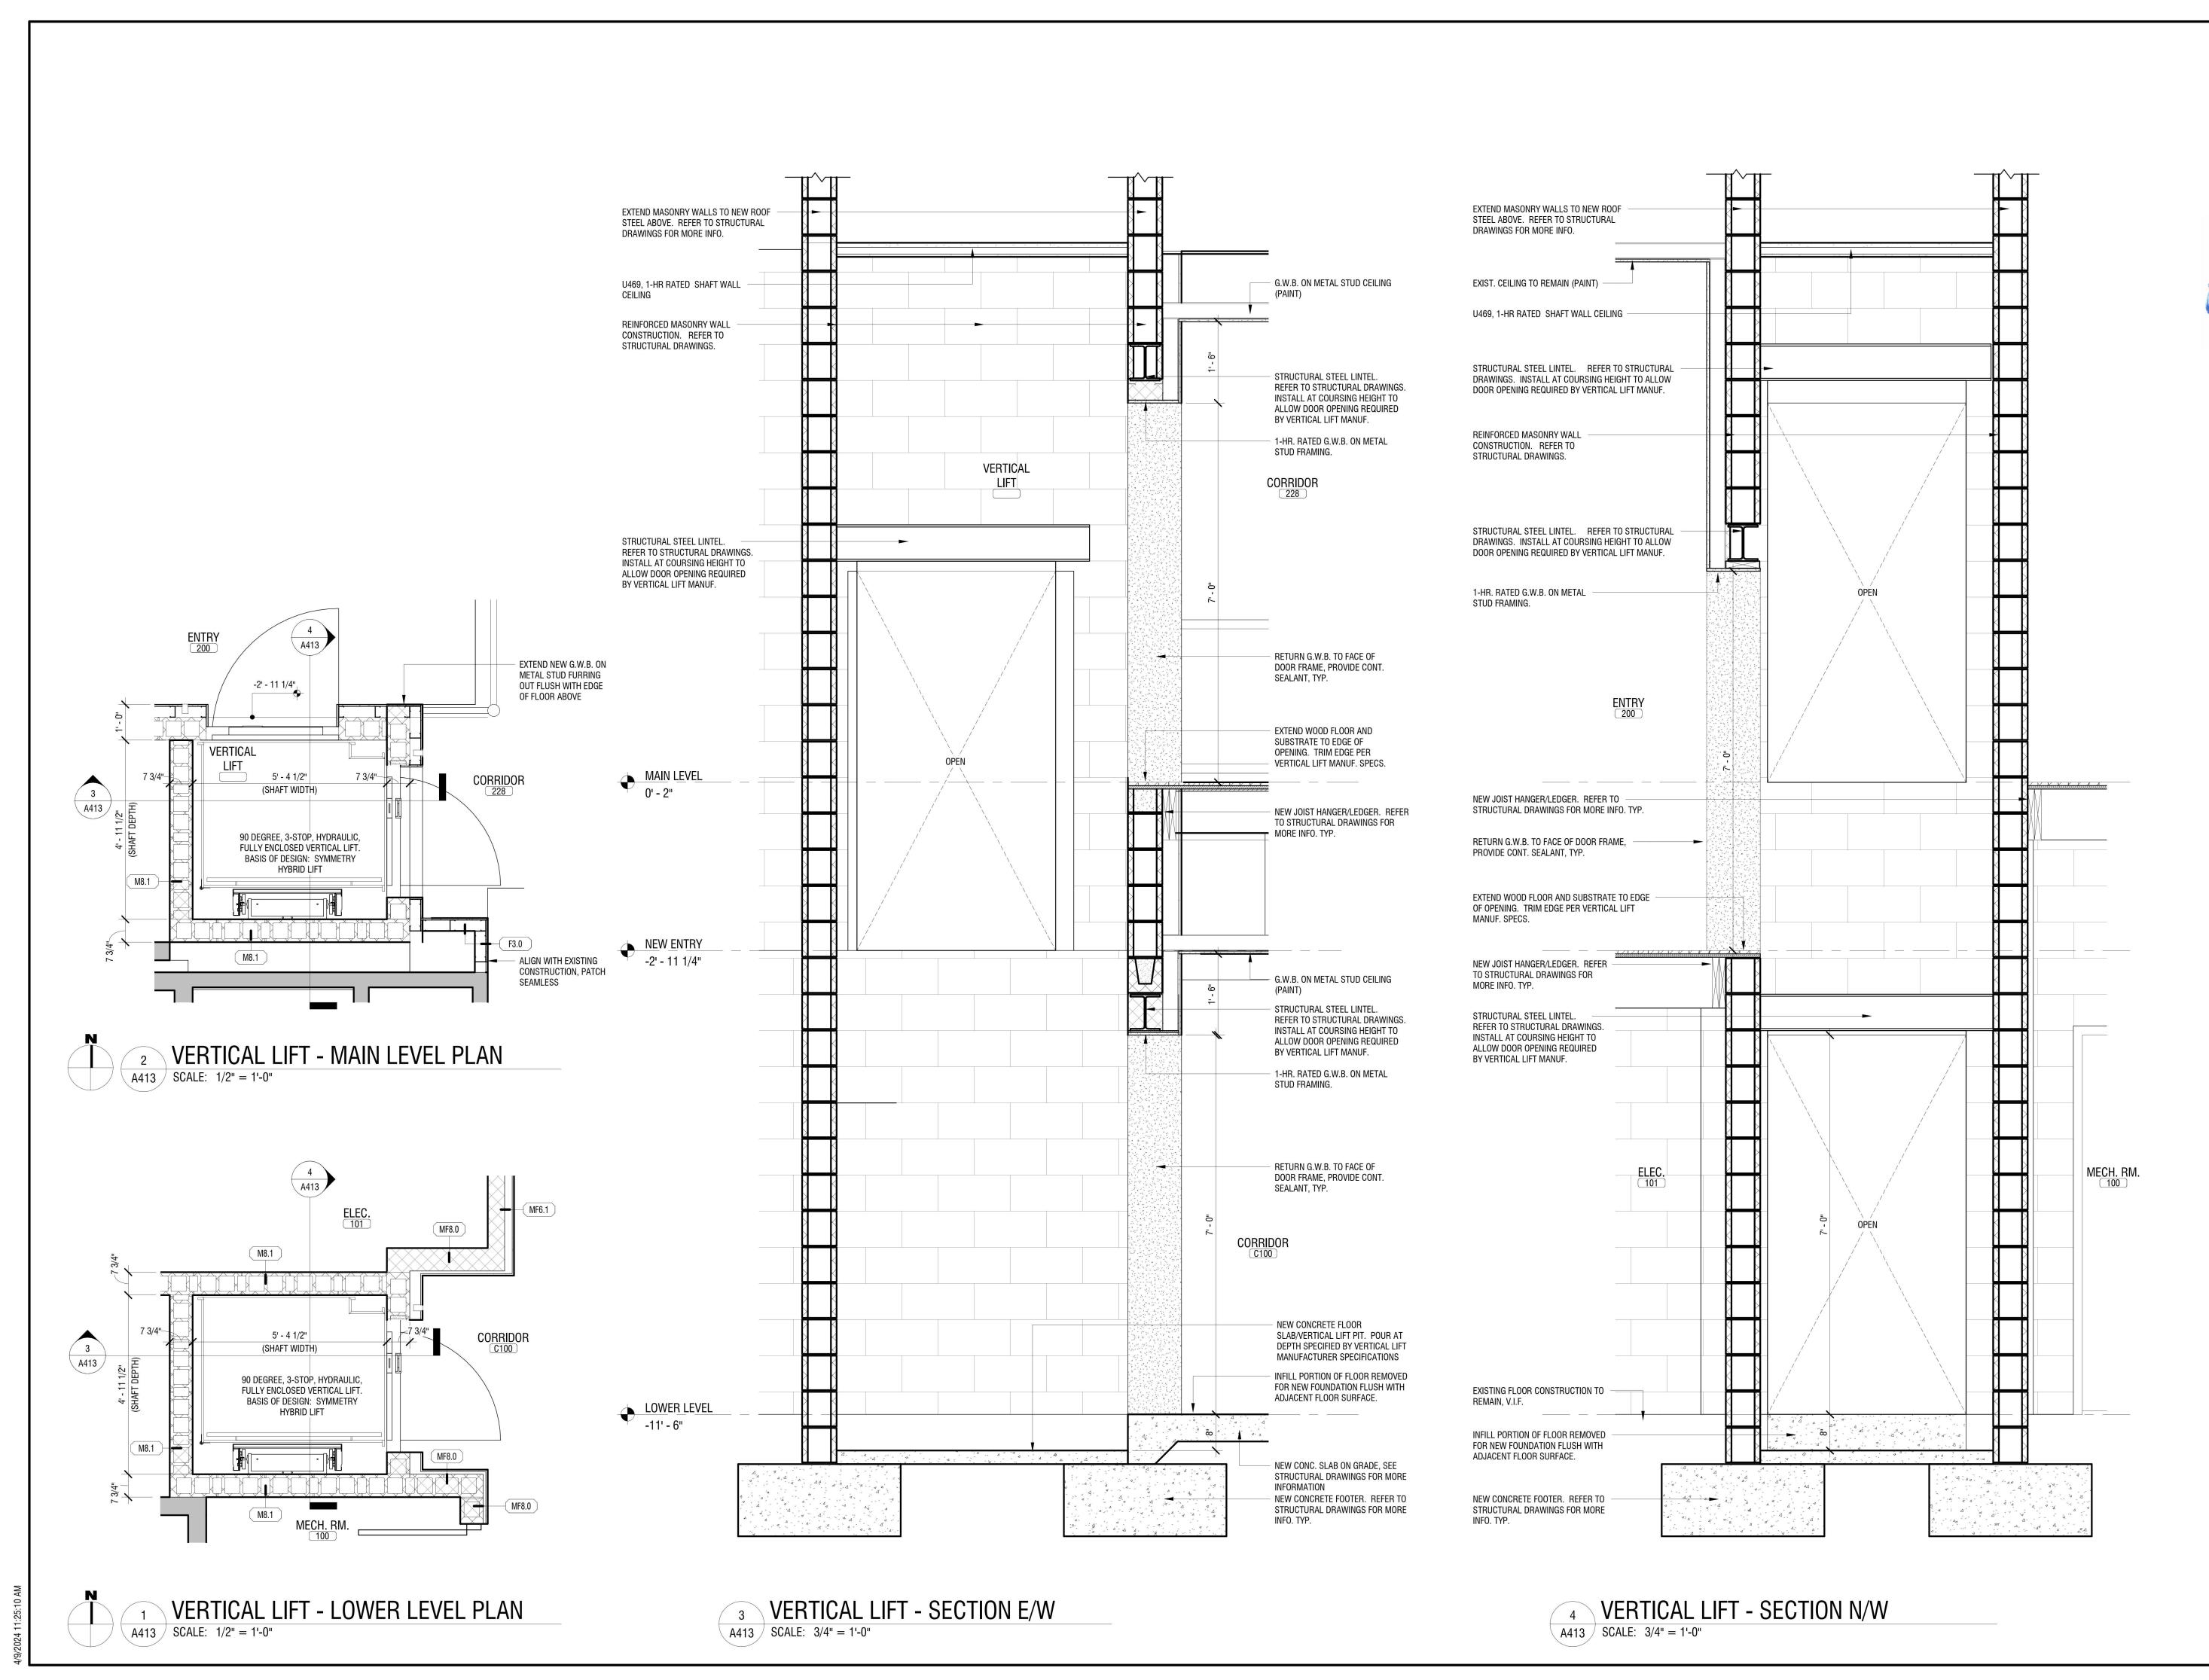

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ESD PROJECT No. 135,035

ACADEMIC INNOVATION HUB - WORK FORCE DEVELOPMENT TRAINING


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DRAWN B	Y:	JMR
REVIEWED BY:		JAK
ISSUED FO	DR:	BID
DATE:		APRIL 11, 2024

DRAWING NAME:

VERTICAL LIFT PLANS AND SECTION DETAILS

DRAWING NUMBER:

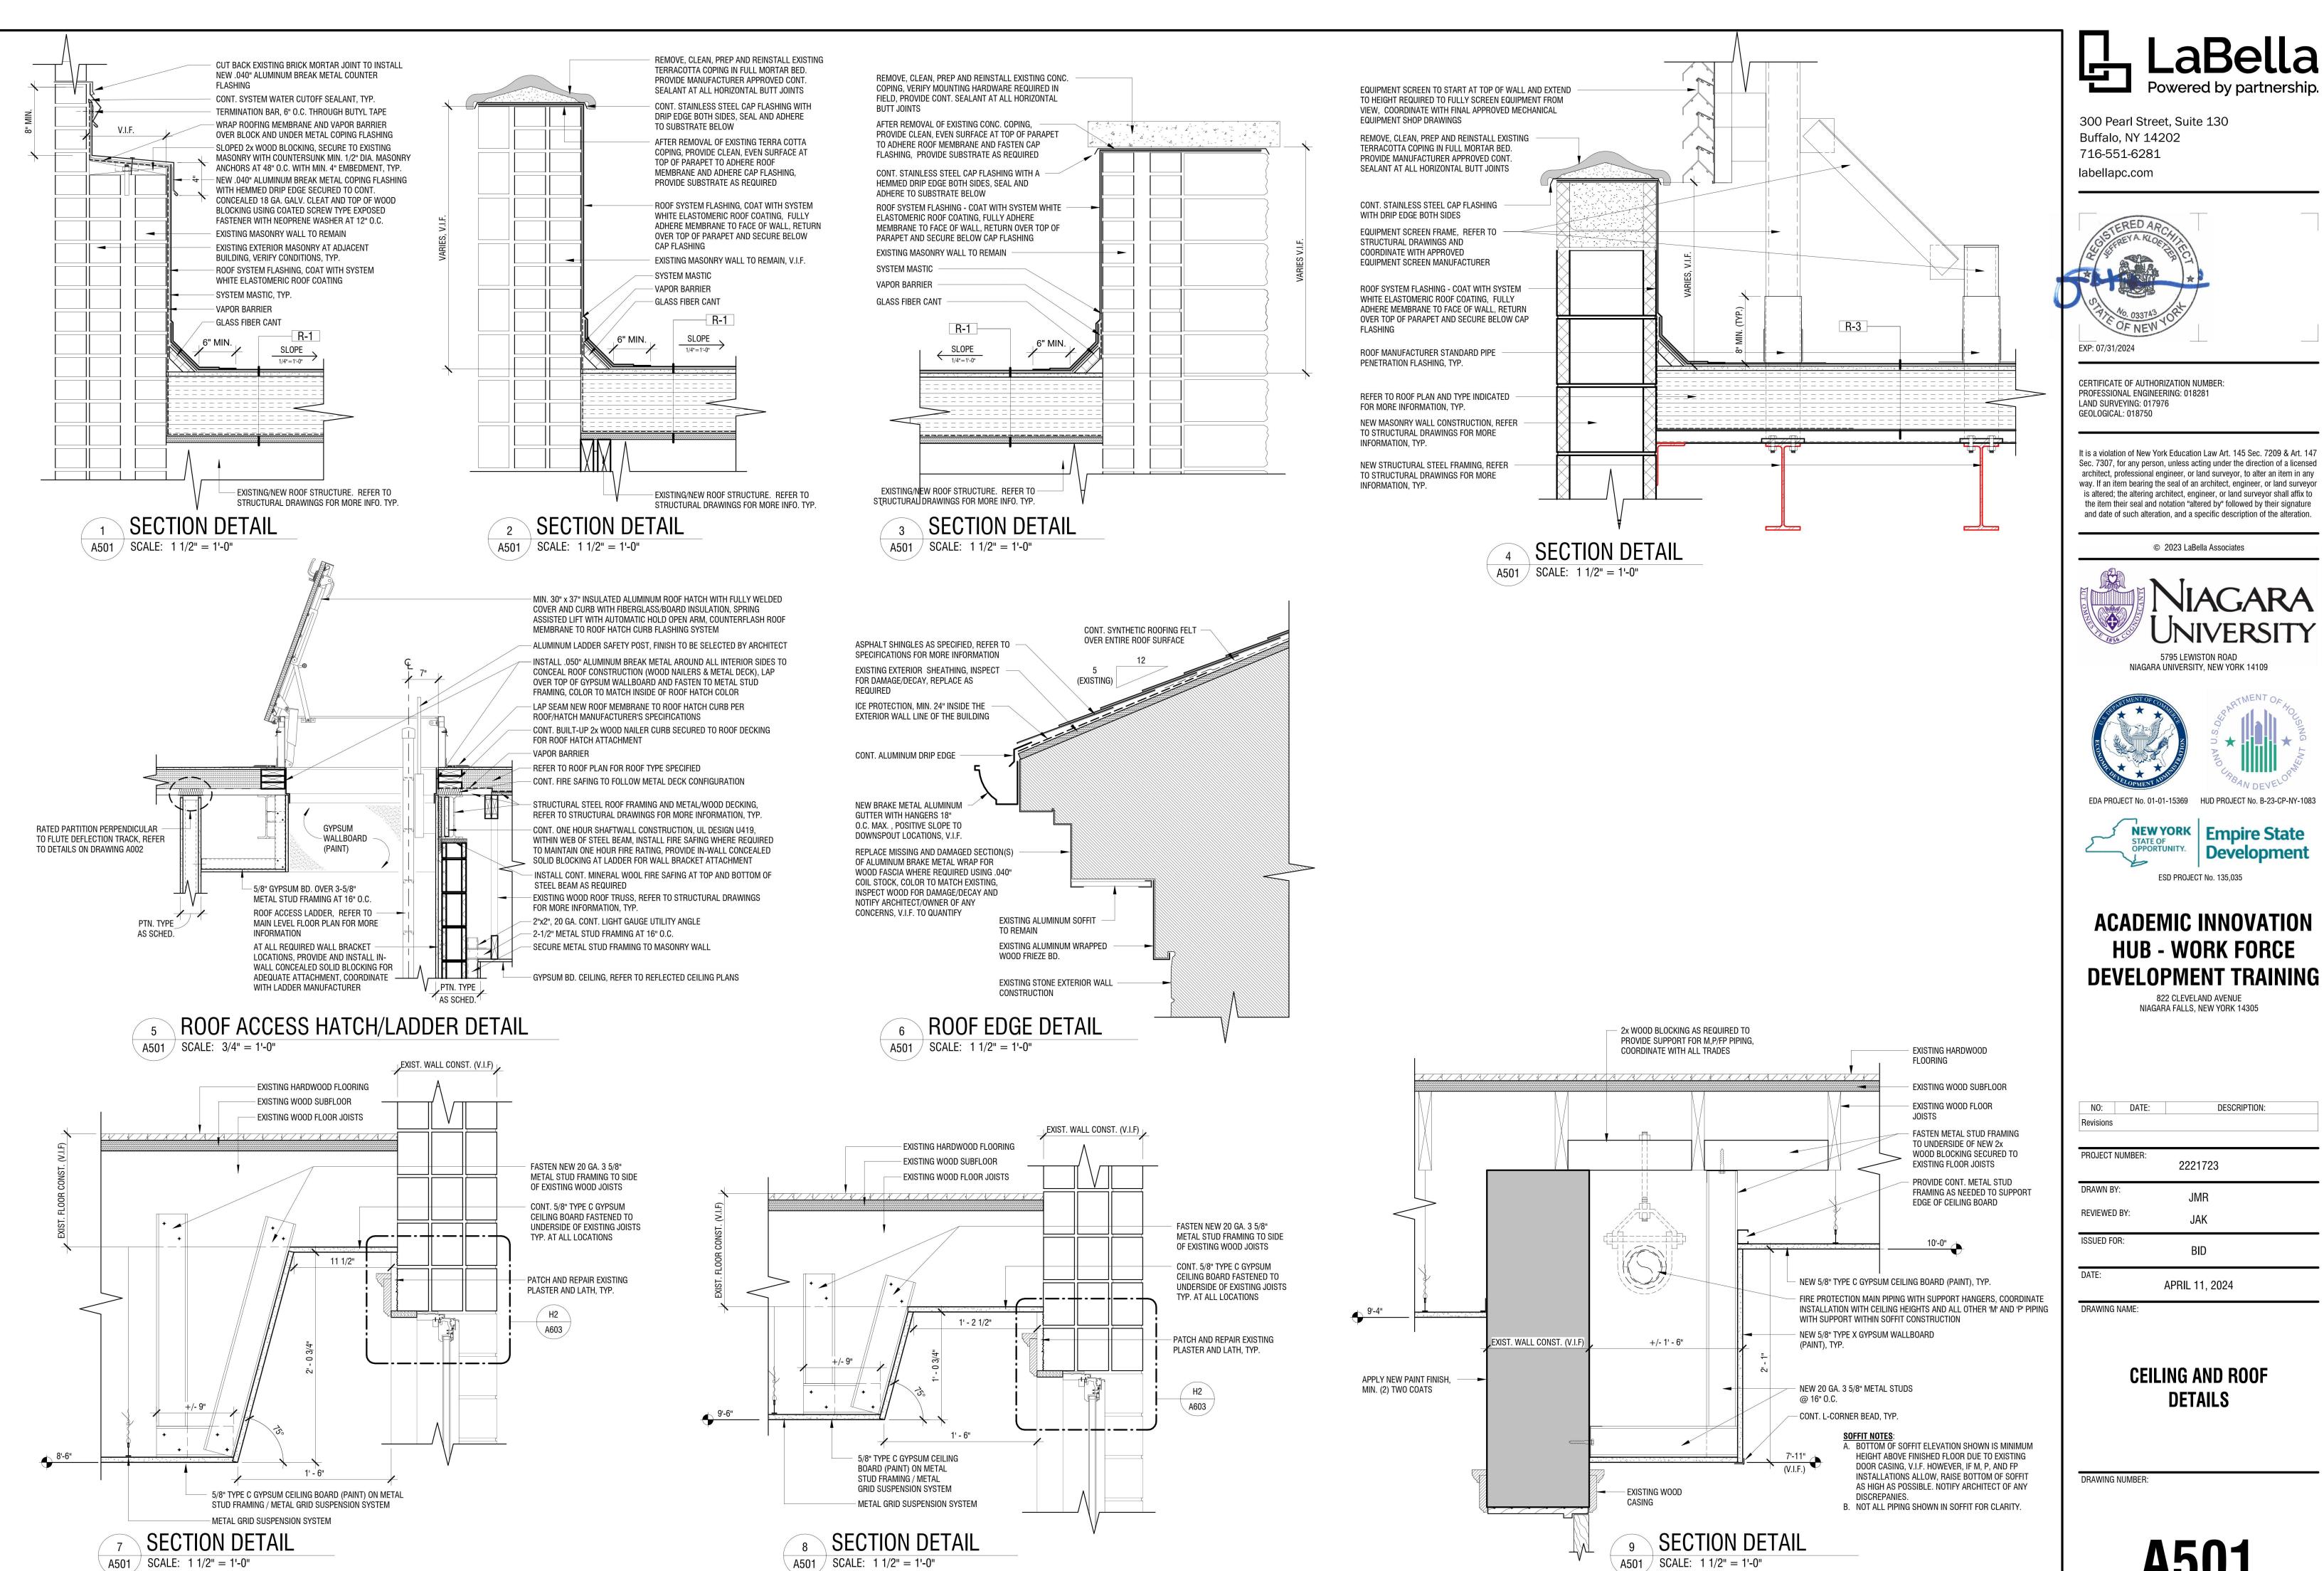

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NIAGARA UNIVERSITY, NEW YORK 14109



EDA PROJECT No. 01-01-15369 HUD PROJECT No. B-23-CP-NY-1083

NEW YORK | Empire State Development

ESD PROJECT No. 135,035


ACADEMIC INNOVATION HUB - WORK FORCE


> 822 CLEVELAND AVENUE NIAGARA FALLS, NEW YORK 14305

NO: DATE: DESCRIPTION: PROJECT NUMBER: 2221723 **JMR** BID APRIL 11, 2024

> **CEILING AND ROOF DETAILS**

DRAWING NUMBER:

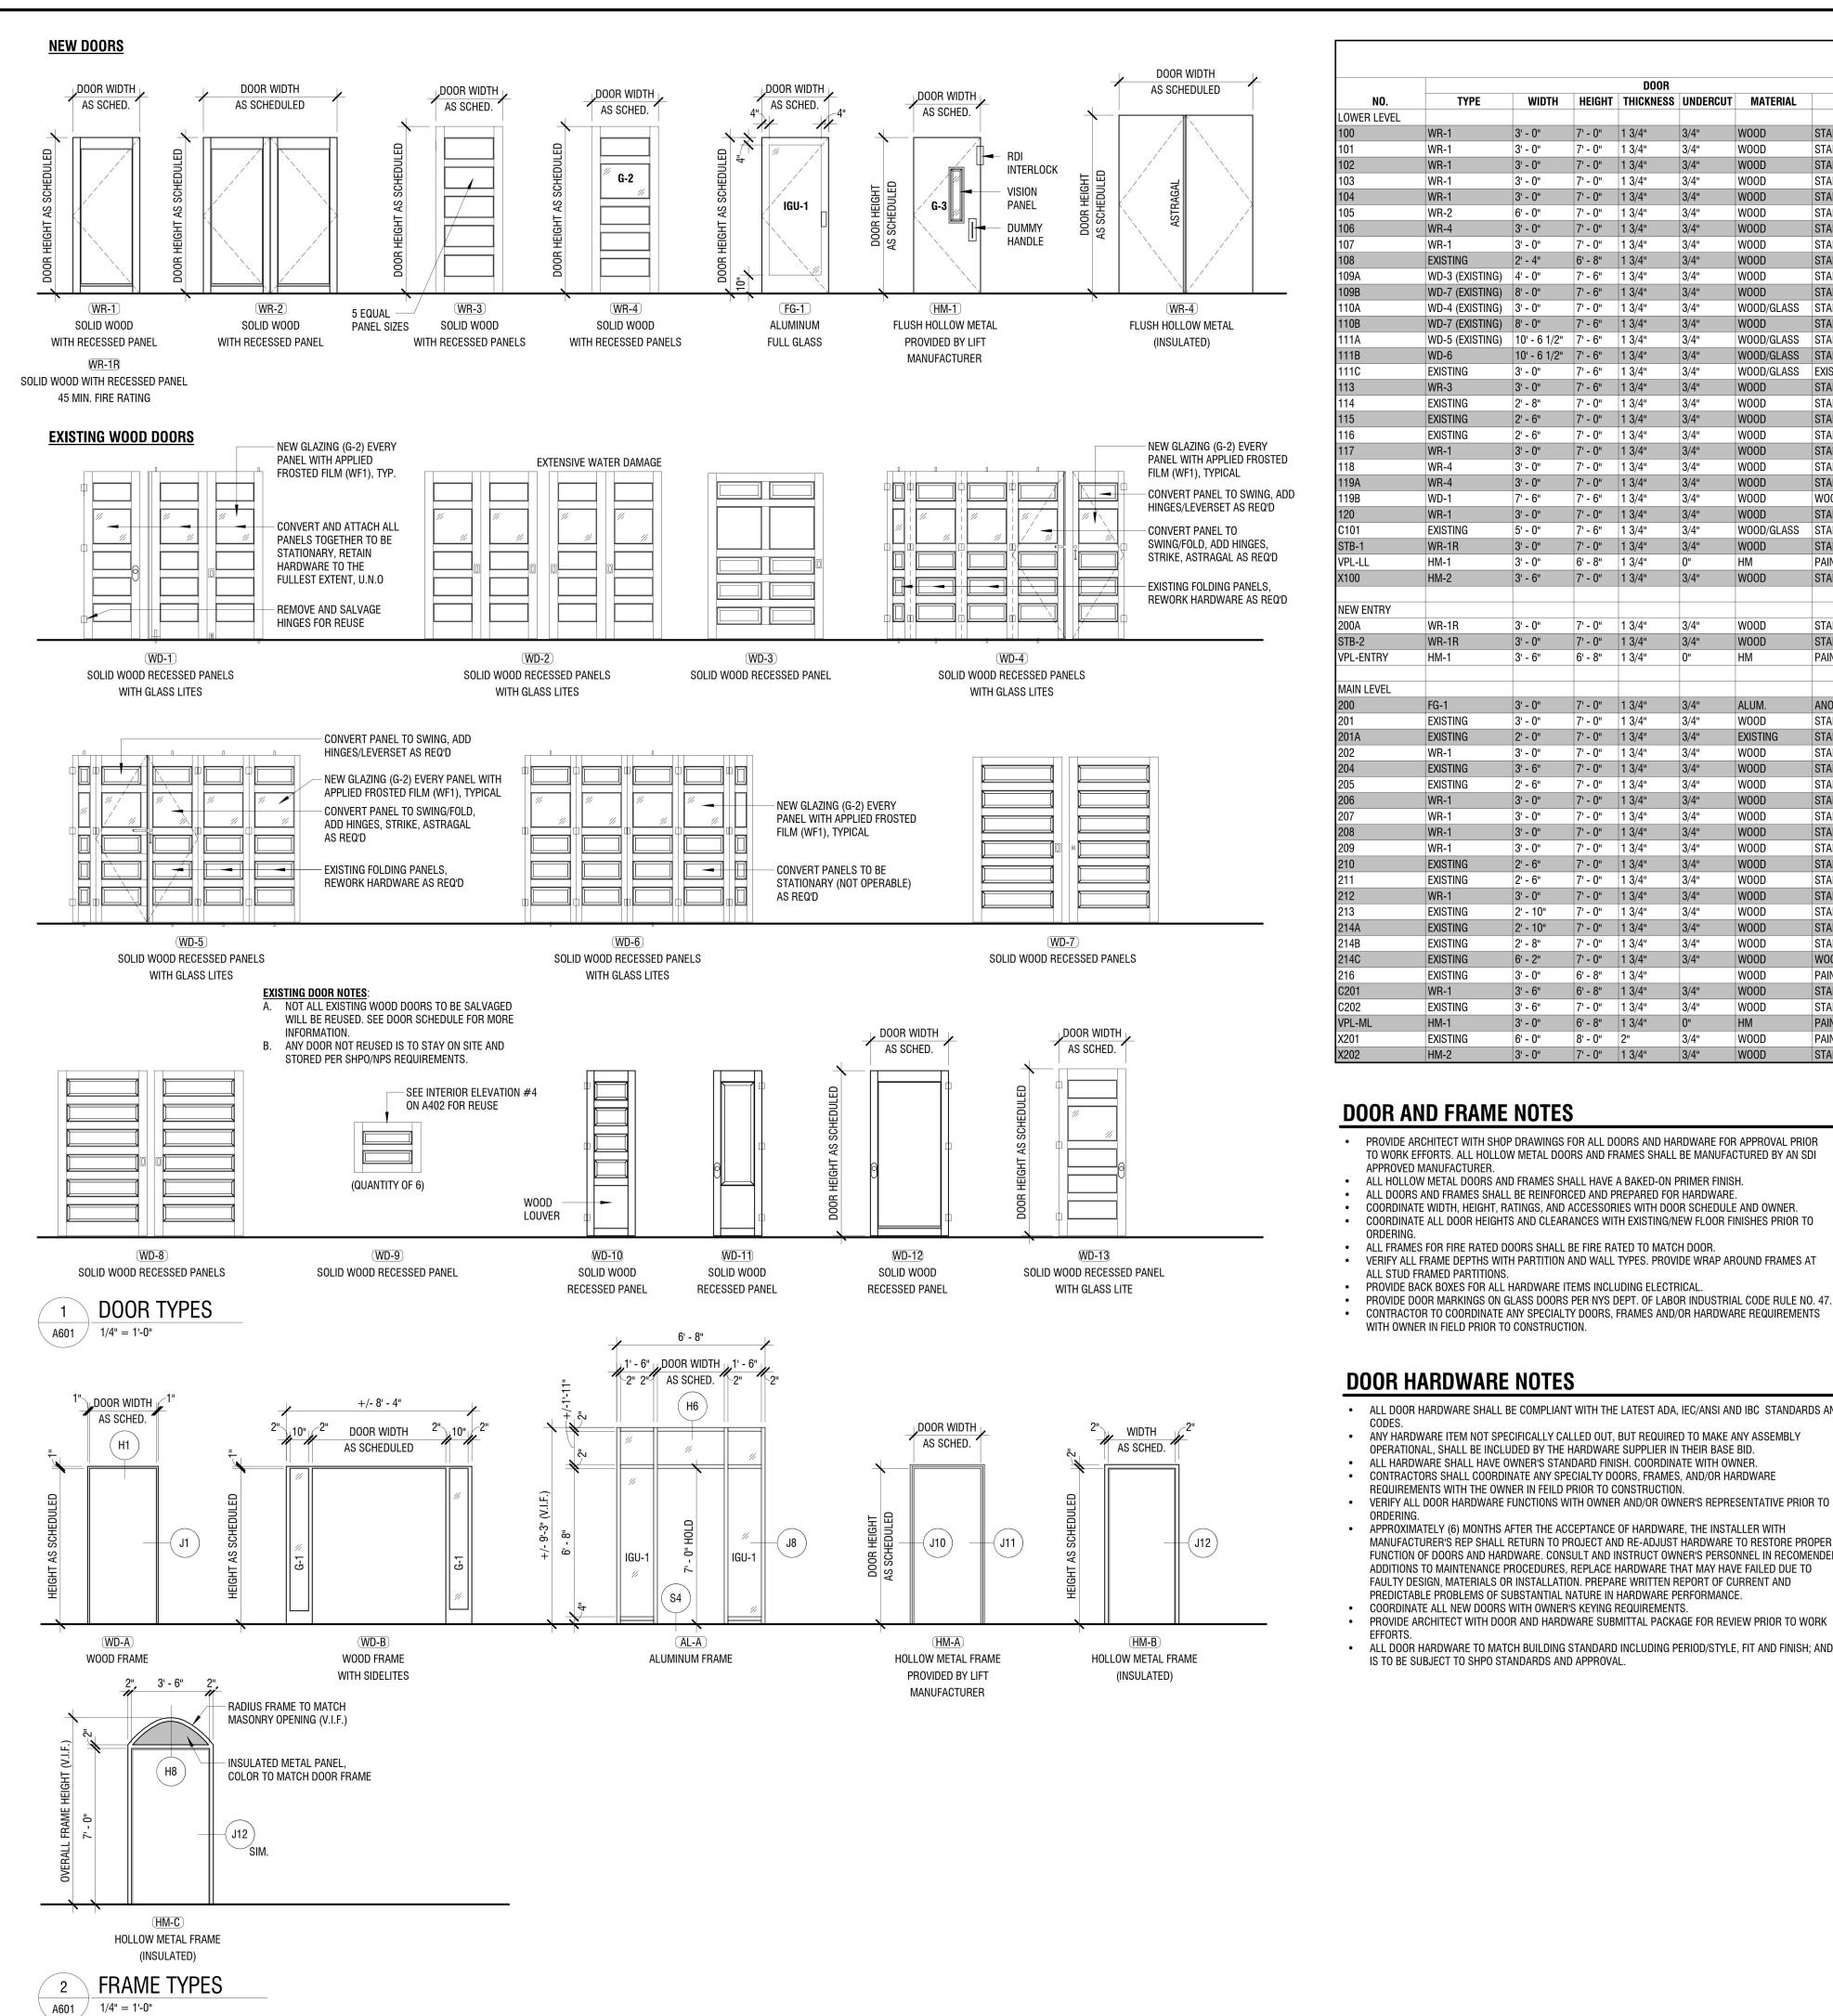

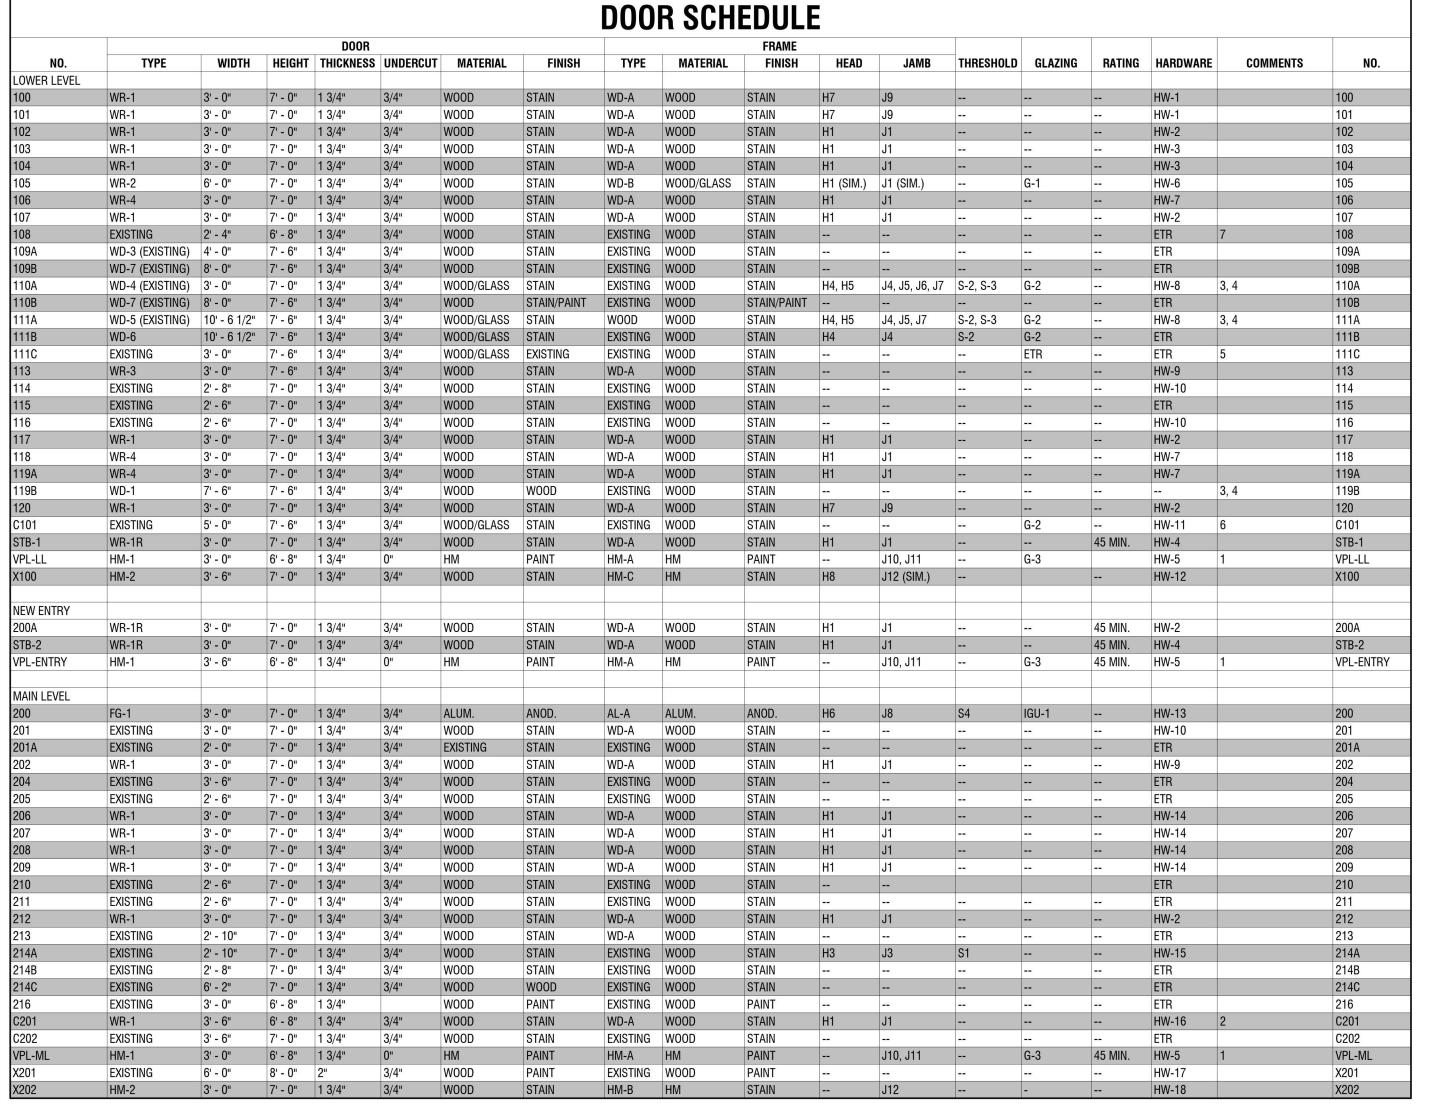

DOOR AND FRAME NOTES

- PROVIDE ARCHITECT WITH SHOP DRAWINGS FOR ALL DOORS AND HARDWARE FOR APPROVAL PRIOR TO WORK EFFORTS. ALL HOLLOW METAL DOORS AND FRAMES SHALL BE MANUFACTURED BY AN SDI
- APPROVED MANUFACTURER. ALL HOLLOW METAL DOORS AND FRAMES SHALL HAVE A BAKED-ON PRIMER FINISH.
- ALL DOORS AND FRAMES SHALL BE REINFORCED AND PREPARED FOR HARDWARE.
- COORDINATE WIDTH, HEIGHT, RATINGS, AND ACCESSORIES WITH DOOR SCHEDULE AND OWNER. COORDINATE ALL DOOR HEIGHTS AND CLEARANCES WITH EXISTING/NEW FLOOR FINISHES PRIOR TO
- ALL FRAMES FOR FIRE RATED DOORS SHALL BE FIRE RATED TO MATCH DOOR. VERIFY ALL FRAME DEPTHS WITH PARTITION AND WALL TYPES. PROVIDE WRAP AROUND FRAMES AT
- ALL STUD FRAMED PARTITIONS.
- PROVIDE BACK BOXES FOR ALL HARDWARE ITEMS INCLUDING ELECTRICAL
- PROVIDE DOOR MARKINGS ON GLASS DOORS PER NYS DEPT. OF LABOR INDUSTRIAL CODE RULE NO. 47. CONTRACTOR TO COORDINATE ANY SPECIALTY DOORS, FRAMES AND/OR HARDWARE REQUIREMENTS WITH OWNER IN FIELD PRIOR TO CONSTRUCTION.

DOOR HARDWARE NOTES

- ALL DOOR HARDWARE SHALL BE COMPLIANT WITH THE LATEST ADA, IEC/ANSI AND IBC STANDARDS AND
- ANY HARDWARE ITEM NOT SPECIFICALLY CALLED OUT, BUT REQUIRED TO MAKE ANY ASSEMBLY
- OPERATIONAL, SHALL BE INCLUDED BY THE HARDWARE SUPPLIER IN THEIR BASE BID. ALL HARDWARE SHALL HAVE OWNER'S STANDARD FINISH. COORDINATE WITH OWNER.
- CONTRACTORS SHALL COORDINATE ANY SPECIALTY DOORS, FRAMES, AND/OR HARDWARE REQUIREMENTS WITH THE OWNER IN FEILD PRIOR TO CONSTRUCTION.
- ORDFRING APPROXIMATELY (6) MONTHS AFTER THE ACCEPTANCE OF HARDWARE, THE INSTALLER WITH
- MANUFACTURER'S REP SHALL RETURN TO PROJECT AND RE-ADJUST HARDWARE TO RESTORE PROPER FUNCTION OF DOORS AND HARDWARE. CONSULT AND INSTRUCT OWNER'S PERSONNEL IN RECOMENDED ADDITIONS TO MAINTENANCE PROCEDURES, REPLACE HARDWARE THAT MAY HAVE FAILED DUE TO FAULTY DESIGN, MATERIALS OR INSTALLATION. PREPARE WRITTEN REPORT OF CURRENT AND PREDICTABLE PROBLEMS OF SUBSTANTIAL NATURE IN HARDWARE PERFORMANCE.
- PROVIDE ARCHITECT WITH DOOR AND HARDWARE SUBMITTAL PACKAGE FOR REVIEW PRIOR TO WORK
- ALL DOOR HARDWARE TO MATCH BUILDING STANDARD INCLUDING PERIOD/STYLE, FIT AND FINISH; AND IS TO BE SUBJECT TO SHPO STANDARDS AND APPROVAL.

- **DOOR SCHEDULE COMMENTS** 1. VERTICAL PLATFORM LIFT DOOR, DOOR FRAME, AND DOOR HARDWARE TO BE PROVIDED AND
- INSTALLED BY LIFT MANUFACTURER. 2. SALVAGED WOOD DOOR AND FRAME FROM MAIN LEVEL MEETING ROOM. RECONSTRUCT IN NEW
- PARTITION AS SHOWN IN PLAN. 3. SALVAGED WOOD DOORS RECONFIGURED IN EXISTING WOOD CASED OPENINGS. SEE EXISTING DOOR
- TYPES THIS SHEET FOR MORE INFORMATION.
- 4. ALL EXISTING GLAZING IN EACH DOOR LEAF TO BE CAREFULLY REMOVED AND REPLACED WITH NEW GLASS AND APPLIED FROSTED FILM. CAREFULLY REMOVE WOOD GLAZING STOPS AND PUSH POINTS FOR REINSTALLATION. SEE GLAZING SCHEDULE AND COLOR AND FINISH LEGEND ON INTERIOR DESIGN
- DRAWINGS FOR MORE INFORMATION. WOOD DOOR AND ASSOCIATED CASING/TRIM TO REMAIN. DOOR TO BE PINNED SHUT. APPLY FROSTED FILM ON LOBBY SIDE. SEE COLOR AND FINISH LEGEND ON INTERIOR DESIGN DRAWINGS FOR MORE
- DOORS TO BE MIRRORED TO SWING INTO LOBBY. AUGMENT WOOD FRAME AS REQUIRED.

PROVIDE AND INSTALL A SOUNDPROOFING DOOR SEAL KIT.

GLAZING SCHEDULE				
TYPE	DESCRIPTION			
IGU-1	1" INSULATED GLASS UNIT OUTBOARD LITE: 1/4" CLEAR TEMPERED GLASS WITH GUARDIAN GLASS SUNGUARD SNX 62/27 ON SURFACE #3. AIRSPACE: 1/2", 5% AIR / 95% ARGON FILLED INBOARD LITE: 1/4" CLEAR TEMPERED GLASS			
IGU-2	 INSULATED GLASS UNIT BY WINDOW MANUFACTURER BASIS OF DESIGN: MARVIN WINDOWS (U-VALUE = 0.26 / SHGC = 0.29) CLEAR GLASS (INTERIOR AND EXTERIOR), 100% ARGON FILLED AIRSPACE WITH LOW-E COATINGS 			
G-1	1/2" CLEAR GLASS, TEMPERED			
G-2	1/4" CLEAR GLASS			
G-3	1/4" CLEAR FIRE RATED GLASS			
G-4	1/4" CLEAR ACRYLIC (NON-GLARE) - PROTECTION GLAZING			
WITHIN	E TEMPERED GLASS AT ALL LOCATIONS WITHIN 18 INCHES OF FLOOR, ALL DOORS, AND THREE (3) FEET OF ALL DOORS, TYPICAL. E INSULATED GLASS UNIT SAMPLES TO ARCHITECT FOR APPROVAL.			

DINTERIOR WINDOW / DOOR ASSEMBLY GLAZING SIZES TO COMPLY WITH NFPA 80 OR ASTM E119.



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CERTIFICATE OF AUTHORIZATION NUMBER: PROFESSIONAL ENGINEERING: 018281 LAND SURVEYING: 017976

GEOLOGICAL: 018750

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EDA PROJECT No. 01-01-15369 HUD PROJECT No. B-23-CP-NY-1083



ESD PROJECT No. 135,035


ACADEMIC INNOVATION HUB - WORK FORCE DEVELOPMENT TRAINING

822 CLEVELAND AVENUE NIAGARA FALLS, NEW YORK 14305

NO: DATE: DESCRIPTION: PROJECT NUMBER: 2221723 DRAWN BY: **JMR** REVIEWED BY: ISSUED FOR: DATE: APRIL 11, 2024

> DOOR SCHEDULE, DOOR FRAMES AND TYPES

DRAWING NUMBER:

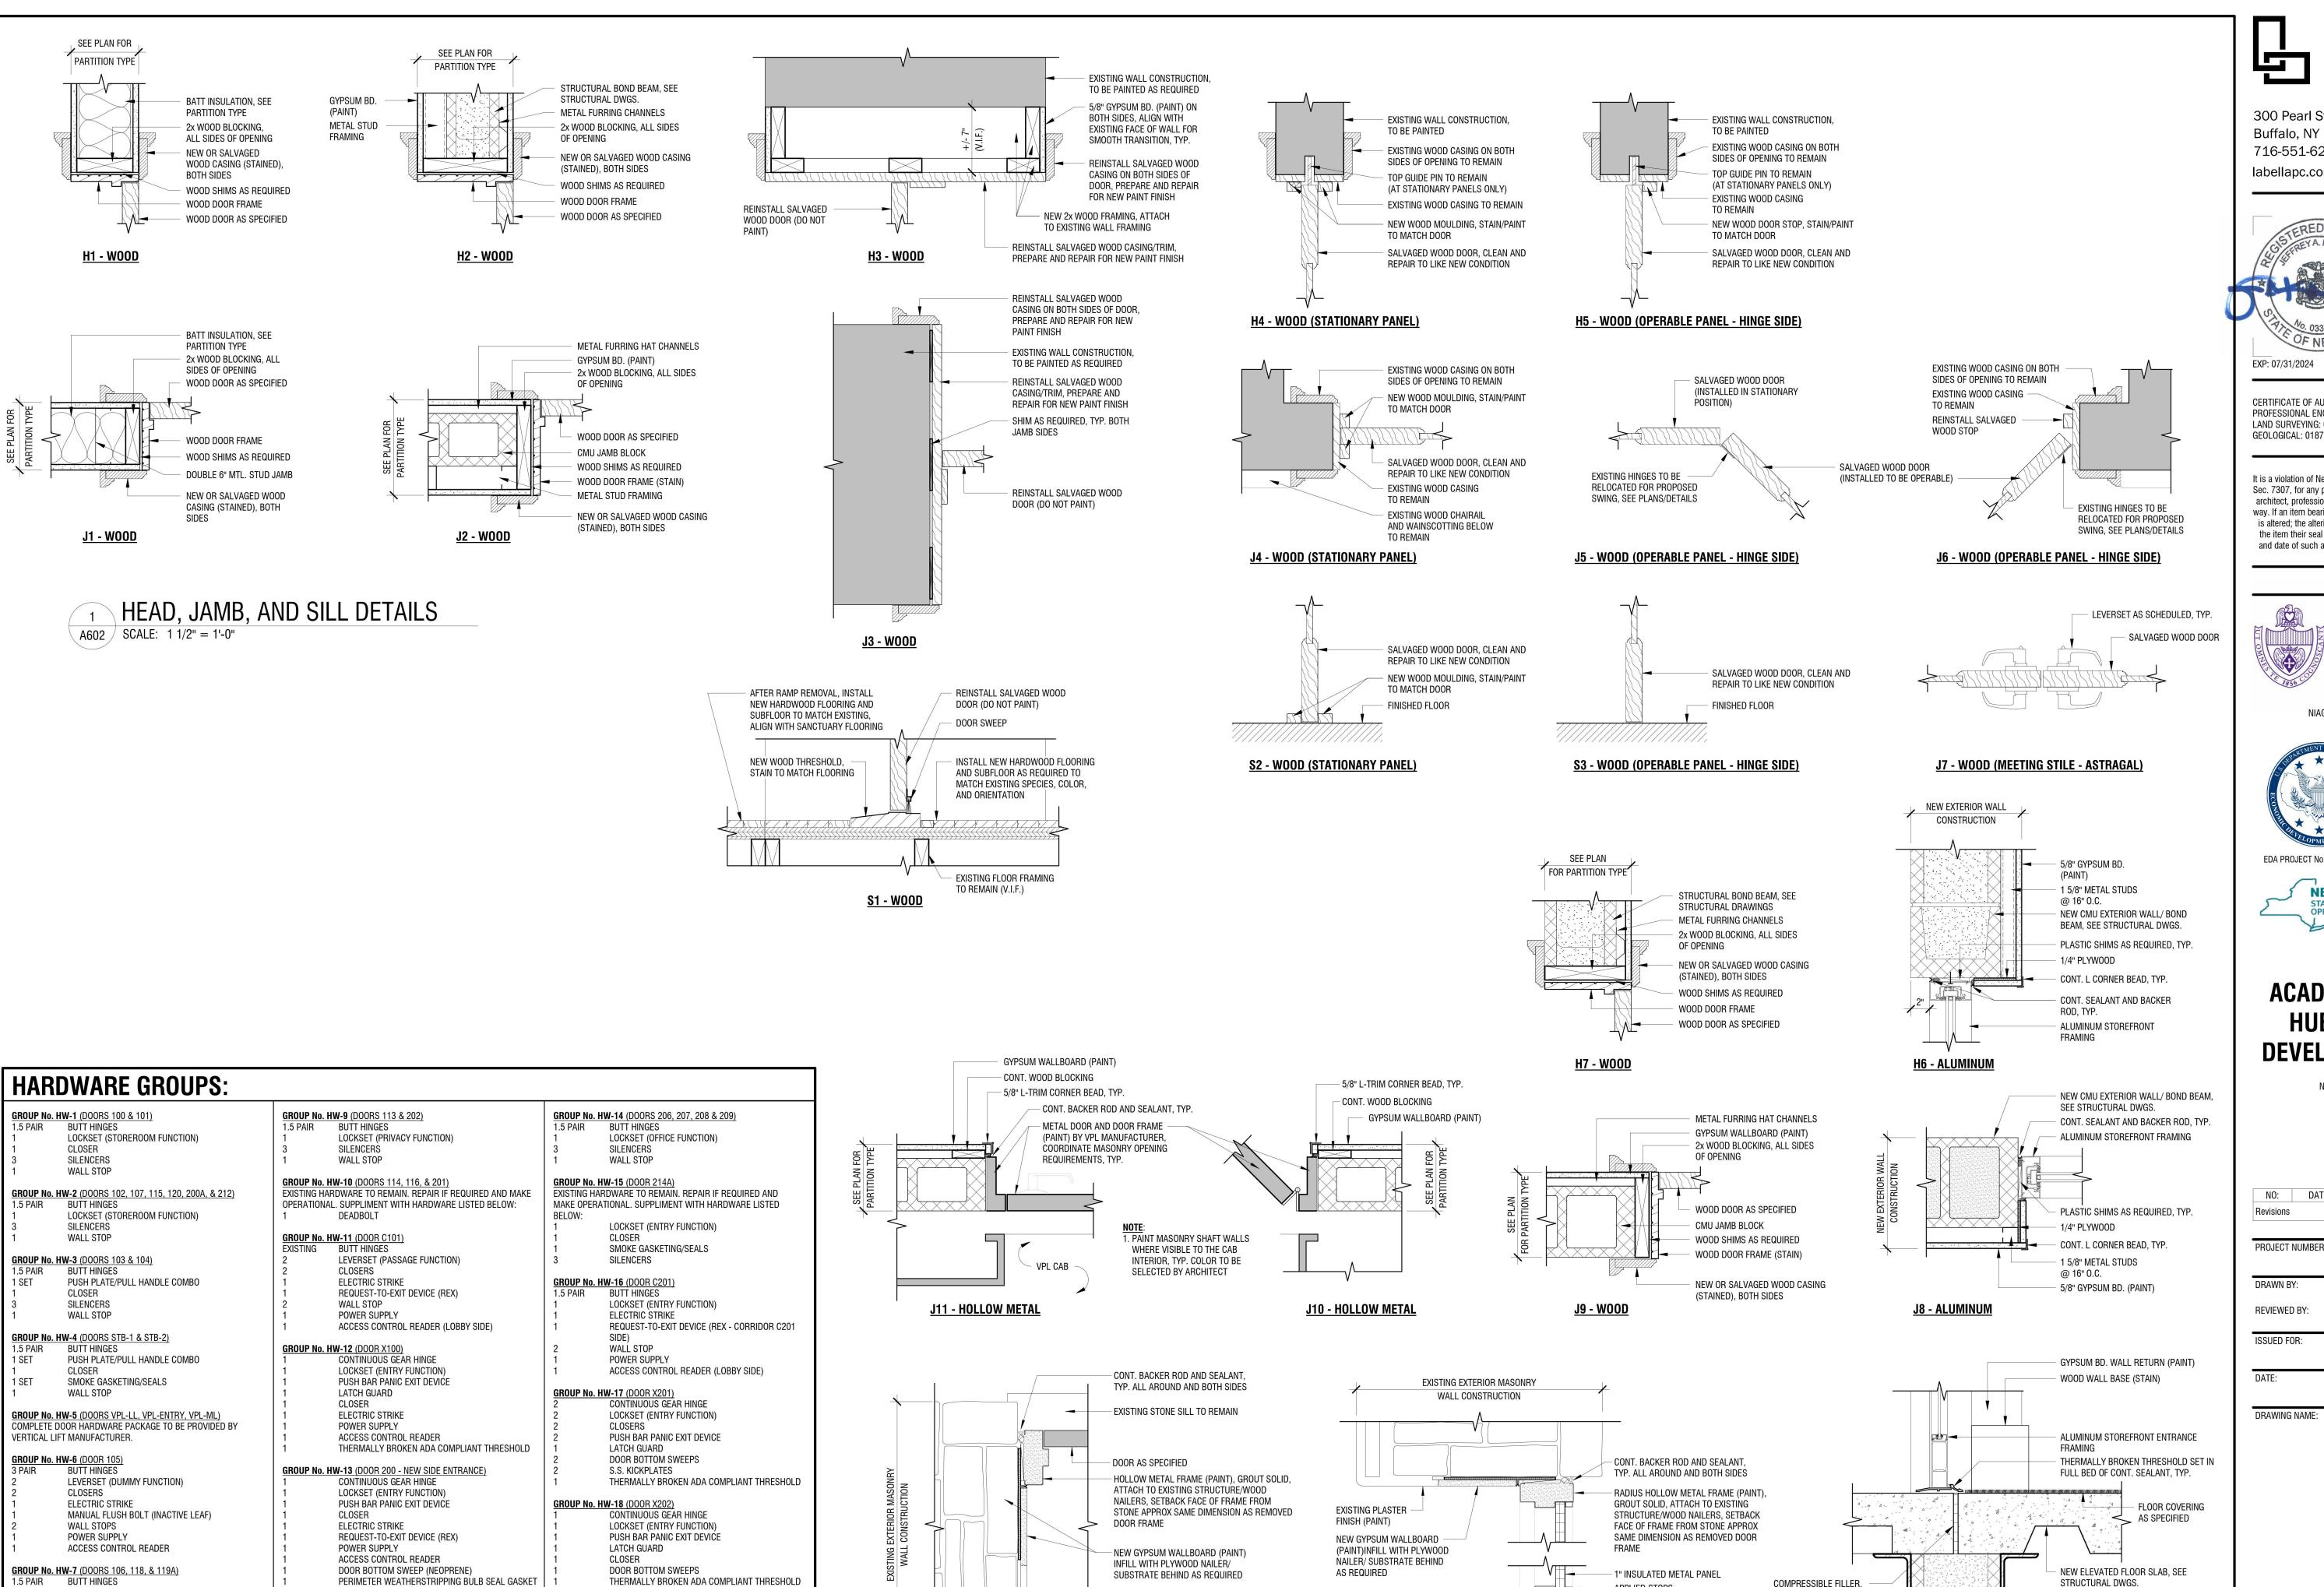

- EXISTING PLASTER FINISH (PAINT)

J12 - HOLLOW METAL



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EDA PROJECT No. 01-01-15369 HUD PROJECT No. B-23-CP-NY-1083

NEW YORK | Empire State OPPORTUNITY.

ESD PROJECT No. 135,035

ACADEMIC INNOVATION HUB - WORK FORCE DEVELOPMENT TRAINING

822 CLEVELAND AVENUE NIAGARA FALLS, NEW YORK 14305

NO:	DATE:	DESCRIPTION:	
isions			
OJECT	NUMBER:	2221723	
AWN B	Y:	JMR	
VIEWED) BY:	JAK	
UED FO	DR:	BID	
TE:			

DOOR DETAILS

APRIL 11, 2024

DRAWING NUMBER:

NEW STRUCTURAL STEEL FRAMING,

NEW CMU EXTERIOR WALL, SEE

SEE STRUCTURAL DWGS.

STRUCTURAL DWGS.

COMPRESSIBLE FILLER,

SEE STRUCTURAL DWGS.

<u>S4 - ALUMINUM</u>

- APPLIED STOPS

- DOOR AS SPECIFIED

H8 - HOLLOW METAL

- DOOR FRAME AS SPECIFIED

LOCKSET (CLASSROOM FUNCTION)

DOUBLE DOOR LOCKSET (CLASSROOM FUNCTION)


SILENCERS

WALL STOP

GROUP No. HW-8 (DOORS 110A & 111A)

WOOD ASTRAGAL

THERMALLY BROKEN ADA COMPLIANT THRESHOLD

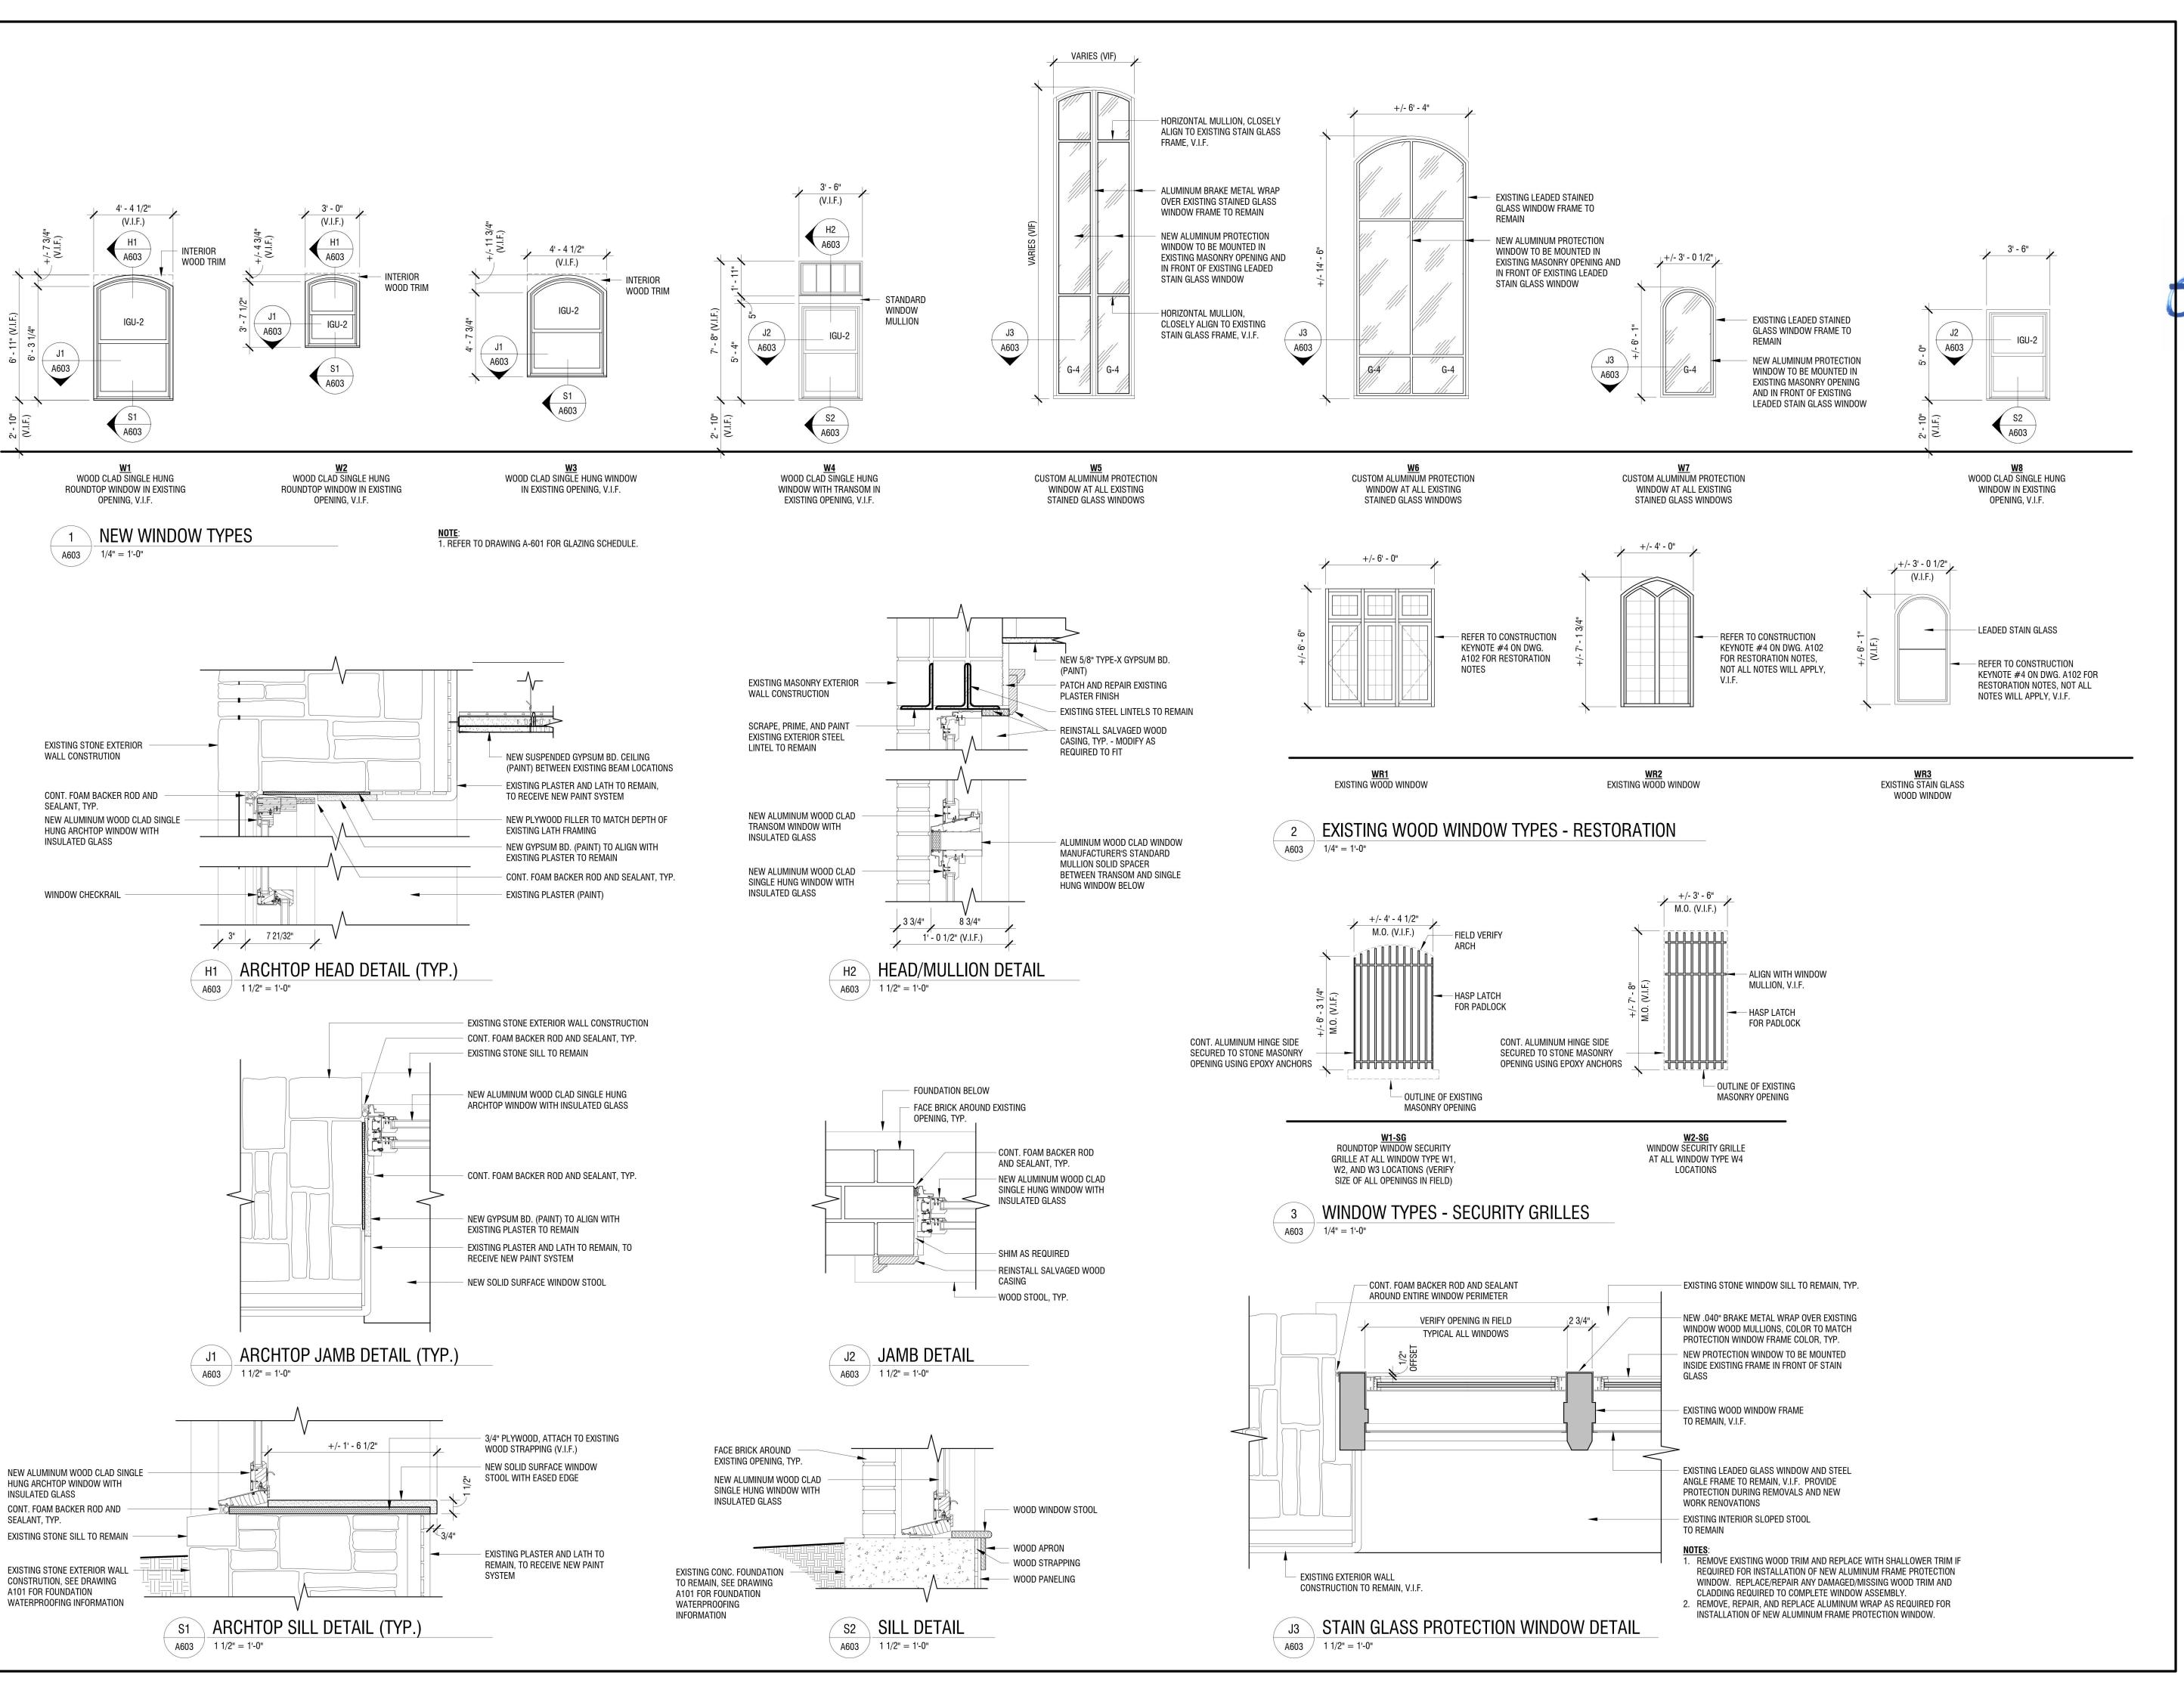



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ESD PROJECT No. 135,035


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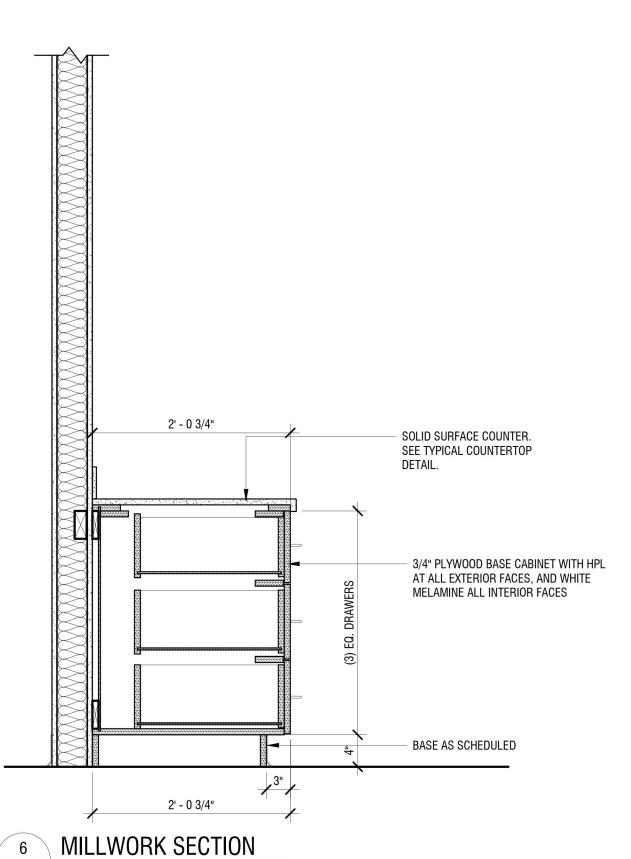
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NO:	DATE:	DESCRIPTION:	
Revisions			
PROJECT	NUMBER:	2221723	
DRAWN B	Y:	JMR	
REVIEWED BY:		JAK	
ISSUED FO	DR:	BID	
DATE:		APRIL 11, 2024	


WINDOW TYPES AND DETAILS

DRAWING NUMBER:




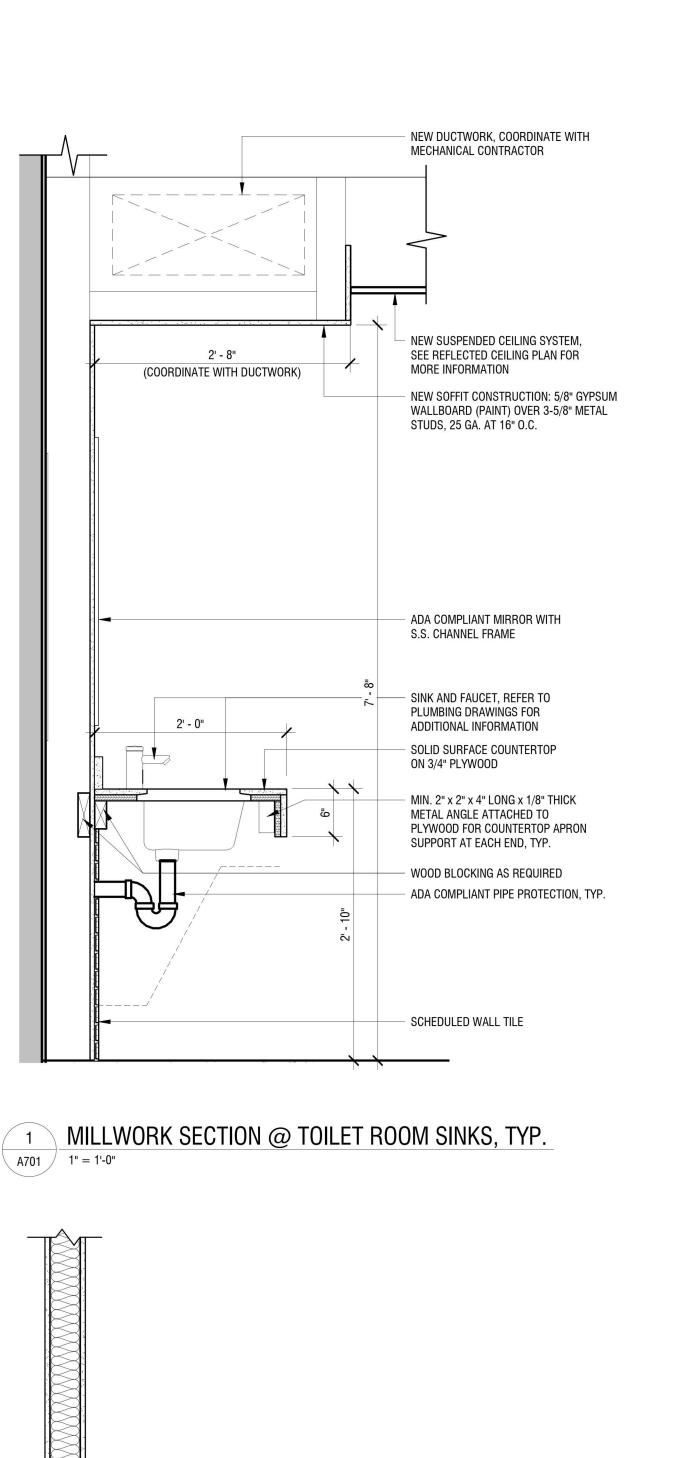


A701 / 1" = 1'-0"

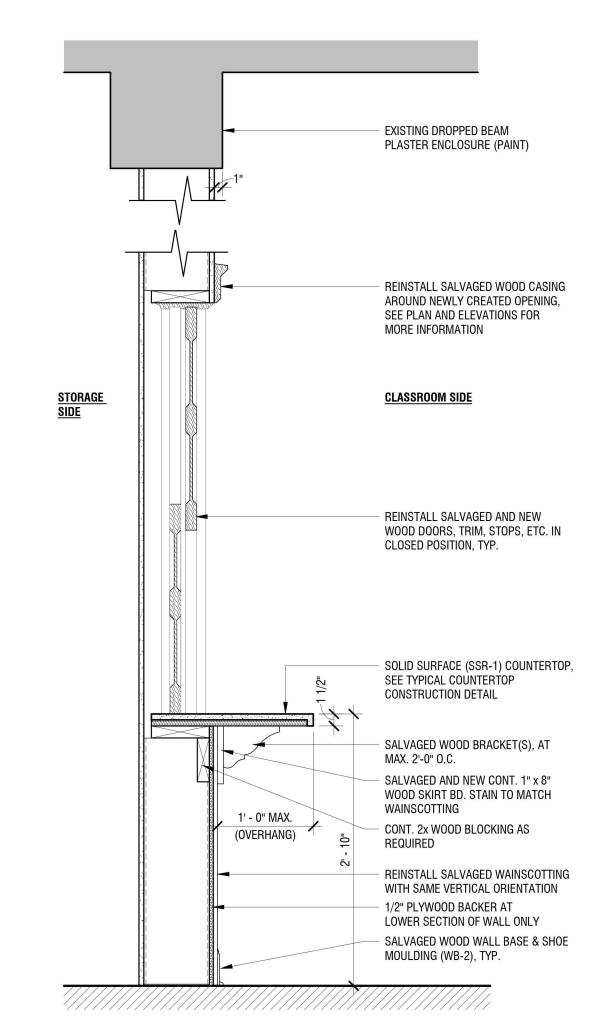

2 MILLWORK SECTION @ CLASSROOM 118 A701 1" = 1'-0"

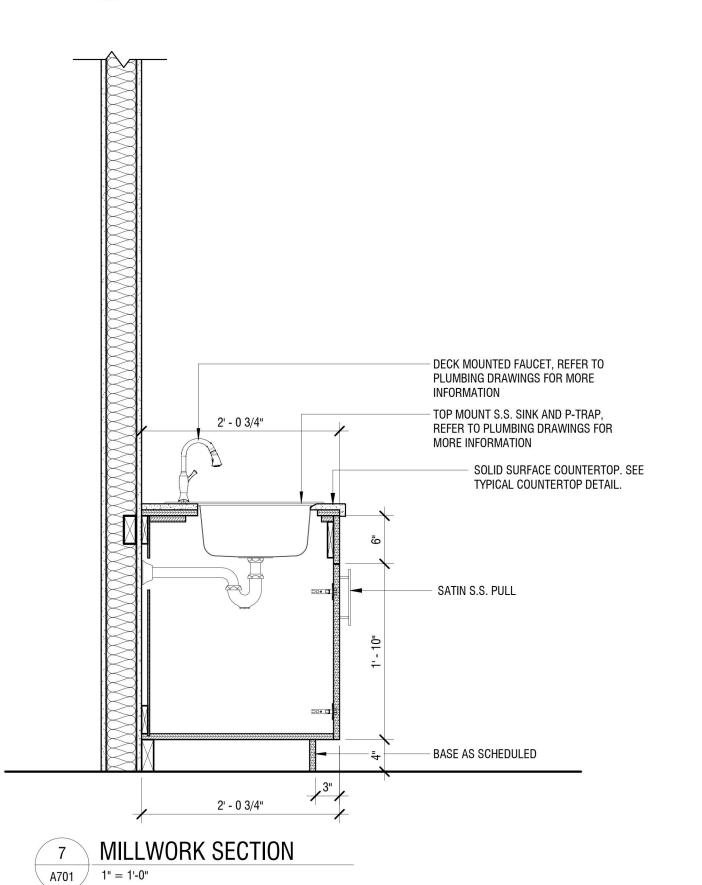

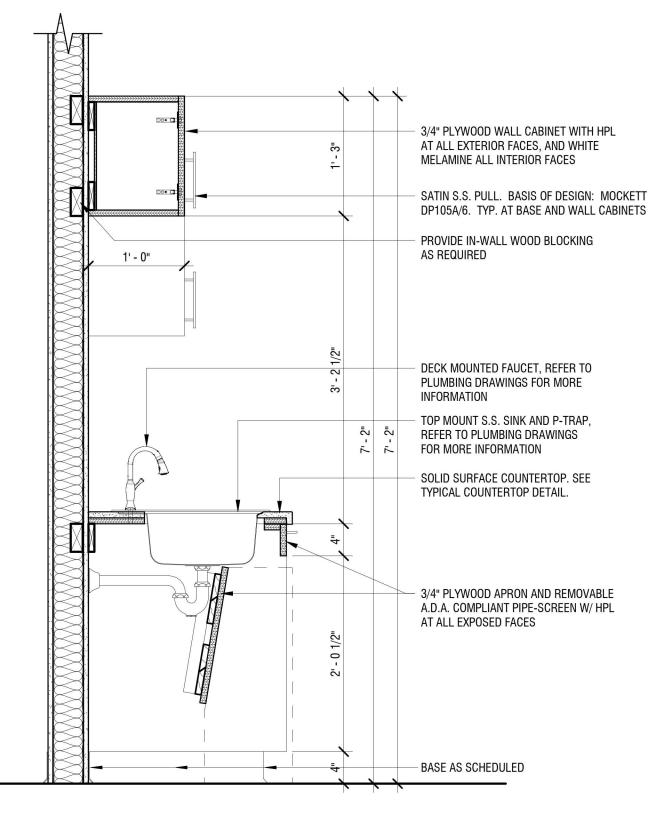


3 MILLWORK SECTION A701 1" = 1'-0"

> - 1x8 FLAT STOCK

(WOOD BASE MOULDING)

LOWER LEVEL

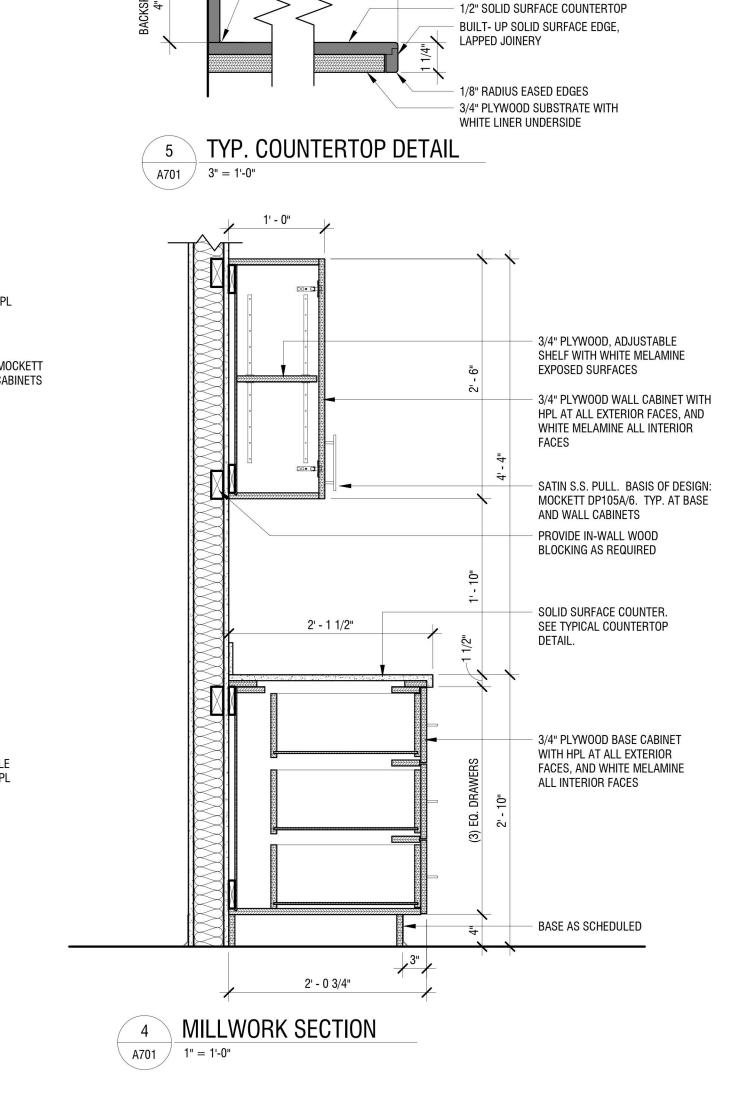

REFER TO PLANS

SOLID SURFACE COUNTERTOP CONSTRUCTION

CONTINUOUS SEALANT AT JUNCTURE OF BACK

1/2" SOLID SURFACE SIDE SPLASH WITH

AND SIDE SPLASHES WITH COUNTERTOP

1/2" SOLID SURFACE BACKSPLASH

EASED EDGES




NEW SPACE LAYOUT. 4. STAINED WOOD WALL BASEBOARD:
A. ACCEPTABLE SPECIES - RED OAK AND MAPLE. 5. PAINTED WOOD WALL BASEBOARD/CASING:A. ACCEPTABLE SPECIES - RED OAK AND POPLAR.

<u>DC-1</u> (WOOD DOOR CASING) THROUGHOUT THE BUILDING

SH0E MOULDING

(WOOD BASE MOULDING)

MAIN LEVEL

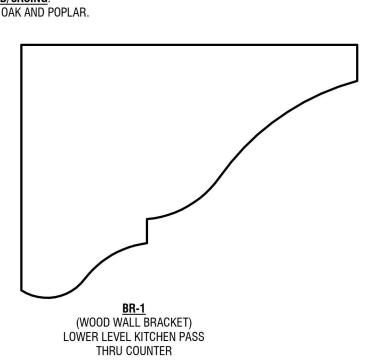

EXISTING WOOD CASING/MOULDING PROFILES A701 | SCALE: 6" = 1'-0"

(WOOD BASE MOULDING)

LOWER LEVEL

MOULDING

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EDA PROJECT No. 01-01-15369 HUD PROJECT No. B-23-CP-NY-1083



ESD PROJECT No. 135,035

ACADEMIC INNOVATION HUB - WORK FORCE DEVELOPMENT TRAINING

822 CLEVELAND AVENUE NIAGARA FALLS, NEW YORK 14305

NO: DATE:		DESCRIPTION:		
Revisions				
PROJECT I	NUMBER:	2221723		
DRAWN BY	Y :	JMR		
REVIEWED BY:		JAK		
ISSUED FO	PR:	BID		
DATE:				

MILLWORK SECTIONS AND DETAILS

DRAWING NUMBER:


CODE	MANUFACTURER	STYLE/PATTERN	COLOR	SIZE	ADDITIONAL REQUIREMENTS	SPEC #
		VIII-/17111E1111	- 002011	V.22		J. 20 11
COUSTIC CEILING F		FOODLION FOOLIO D. OFFICE FILLY	MUUTE	04" V 40"	COLLABE EDGE FULLY CONCEAL ED COLD (F7.01.4000)	00 54 40
ACT1	CERTAINTEED ARCHITECUTRAL CEILING SYSTEMS	ECOPHON FOCUS Ds SERIES - FULLY CONCEALED GRID	WHITE	24" X 48"	SQUARE EDGE - FULLY CONCEALED GRID (EZ CLASSIC)	09 51 13
ACT2	ARMSTRONG	CLEAN ROOM MYLAR - SQUARE LAY-IN	WHITE	24" X 24"	15/16" EXPOSED GRID	09 51 13
ARPET						
CPT1	INTERFACE	AERIAL PLANKS COLLECTION AE311	104674 SMOKE	25CM X 1M		09 68 13
CPT2	INTERFACE	AERIAL PLANKS COLLECTION AE315	105815 SMOKE/IRIS	25CM X 1M		09 68 13
CPT3	INTERFACE	AERIAL PLANKS COLLECTION AE317	105828 IRIS	25CM X 1M		09 68 13
ERAMIC/PORCELAI	LTUE					
CT1	CROSSVILLE	COLOR BLOX 2.0	SEA OTTER	3" X 3" MOSAIC		09 30 00
CT2	CROSSVILLE	COLOR BY NUMBERS	WT02 TEA FOR TWO	4" X 12"		09 30 00
СТЗ	CROSSVILLE	COLOR BY NUMBERS	WT06 SIXTH SENSE	4" X 12"		09 30 00
CT4	CROSSVILLE	COLOR BY NUMBERS	WT20 20/20 VISION	4" X 12"		09 30 00
NTRANCE MAT						
EM1	INTERFACE	STEP REPEAT COLLECTION SR999	TBD	25CM X 1M		12 48 13
2			.55			12.00.00
ROUT						1-
GRT1	LATICRETE	SPECTRALOCK PRO EPOXY GROUT	TBD	-	FOR USE WITH CT1	09 30 00
IIGH PRESSURE LAI	IINATE					
HPL1	WILSONART	STANDARD LAMINATE	TBD	-		06 40 23
UXURY VINYL TILE						
LVT-1	INTERFACE	NATURAL WOODGRAINS	TBD	25CM X 1M		09 65 19
AINT						
PT1	SHERWIN WILLIAMS	AS REQUIRED PER SPECIFICATIONS	SW6001 GRAYISH	-		09 91 23
PT2	SHERWIN WILLIAMS	AS REQUIRED PER SPECIFICATIONS	SW6265 QUIXOTIC PLUM			09 91 23
PT3	SHERWIN WILLIAMS	AS REQUIRED PER SPECIFICATIONS	SW7007 CEILING BRIGHT WHITE	-		09 91 23
SECULIFIED A OF						
RESILIENT BASE RB1	TARKETT	STANDARD THERMOSET WALL BASE	TBD	4" HIGH		09 65 13
NDI	IANKLII	STANDARD ITIERWOOLT WALE BASE	טטו	4 111011		09 00 10
RUBBER FLOOR TILE						
RBF1	NORA RUBBER FLOORING	NORAMENT ARAGO	TBD	39.53 IN X 19.76 IN		09 65 19
NURRER OTALD TRE	.					
RUBBER STAIR TREA RST1	NORA RUBBER FLOORING	NORAMENT ARAGO STAIR TREAD	TBD		WITH VISUALLY CONTRASTING NOSING STRIP	09 65 13
11011	NOTATIONSETT LOOTING	NOTIVINE IN AUTOCO OTALIT THEAD	100		WITH VIOUNCET CONTINUE NACING CITIES	03 00 10
OLID SURFACE						
SSR1	WILSONART	SOLID SURFACE	NIGHT STARS 9105CS	-		06 40 23
TATIC DISSIPATIVE	TILE EL CORING					
SDT1	TARKETT	IQ GRANIT	TBD	12IN X 12IN		09 65 36
RANSITION STRIP	22	22	0711111 565 5	ı	TVD DODGE: 1.11/0751-11-1-1-1-1-1-1-1-1-1-1-1-1-1-1-1-1-1	00 00 00
TS1	SCHLUTER SOULUTER	SCHIENE	STAINLESS STEEL	-	TYP PORCELAIN/CERMIC TILE FINISHING EDGE	09 30 00
TS2 TS5	SCHLUTER DALTILE	QUADEC MARBLE THRESHOLD	STAINLESS STEEL TBD	- ADA COMPLIANT	TYP WALL TILE OUTSIDE CORNER PROFILE	09 30 00 09 30 00
TS6	TARKETT	SLT-XX-J	TBD	-	TYP. RESILIENT TO ETR PROFILE	09 65 13
VALL PROTECTION		1				
WP1	INPRO	PALLADIUM RIGID SHEET WALL PROTECTION	TBD	4' X 10'		10 26 00
VINDOW FILM						
WF1	3M	FASARA WINDOW FILM	TBD	VARIES	ALLOW FOR CUSTOM EXTENTS OF GRADATION	09 72 00
WF2	3M	SCOTCHCAL FILM IJ8150 WITH	TBD	54 INCHES	ALLOW FOR CUSTOM COLOR(S) AND PATTERN(S)	09 72 00
		OVERLAMINATE 8914				
VINDOW TREATMEN	T					
WT1	DRAPERY INDUSTRIES	BLUESHADE ARCHITECTRUAL CM CLUTC	MERMET BLUESHADE E-SCREEN:	V.I.F.	3% OPENESS, MANUAL SHADE	12 24 13
	_/## E ##BOOTHIEG		TBD		The state of the s	

FINISH SYMBOLS LEGEND & ABBREVIATIONS

WALL FINISH(ES) (* *FIRST LISTED IS FL00R FIELD FINISH, FINISH(ES) ABOVE FINISH FLOOR CERAMIC/PORCELAIN TILE ENTRY MAT EXISTING TO REMAIN GYPSUM WALL BOARD **HDWD HARDWOOD** HIGH PRESSURE LAMINATE RESILIENT BASE RUBBER FLOOR TILE RUBBER STAIR TREAD SEALED CONCRETE STATIC DISSIPATIVE TILE SOLID SURFACING TRANSITION STRIP WINDOW FILM WINDOW PROTECTION WINDOW TREATMENT ACCENT WALL FINISH DESIGNATION -(XXX) (FULL HEIGHT, TYP.)

CARPET DIRECTION

TILE PATTERN LEGEND

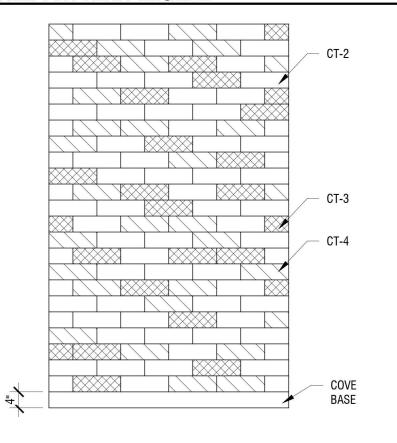



GENERAL CONSTRUCTION NOTES:

- A. CONSTRUCTION SHALL CONFORM TO THE "NEW YORK STATE UNIFORM FIRE PROTECTION AND BUILDING CODE", LATEST REVISION, THE NEW YORK STATE ENERGY CODE AND ANY OTHER CODES GOVERNED BY THE JURISDICTION IN WHICH THE PROJECT IS BEING CONSTRUCTED.
- B. CONSTRUCTION SHALL COMPLY WITH ALL LOCAL, STATE AND FEDERAL CODES AND REGULATIONS. C. ALL DRAWINGS ARE GRAPHIC REPRESENTATIONS OF APPROXIMATE LOCATIONS OF NEW MATERIALS. IT IS THE CONTRACTOR'S RESPONSIBILITY TO FIELD VERIFY ALL CONDITIONS PRIOR TO COMMENCEMENT OF
- D. CONTRACTORS ARE RESPONSIBLE FOR ALL MATERIALS, CONSTRUCTION METHODS AND CRAFTSMANSHIP. CONTRACTORS ARE TO VERIFY ALL EXISTING CONDITIONS, REQUIREMENTS, NOTES, CODES AND DIMENSIONS, PRIOR TO THE START OF CONSTRUCTION AND SHALL NOTIFY THE ARCHITECT IF CONDITIONS VARY FROM
- THOSE SHOWN ON THE DOCUMENTS. F. CONTRACTORS ARE TO PROVIDE ADEQUATE SUPPORT OF EXISTING FOUNDATION WALLS, LOAD BEARING
- WALLS AND PARTITIONS DURING DEMOLITION AND CONSTRUCTION. G. THOROUGHLY COORDINATE WORK WITH OTHER TRADES AND DETERMINE THE EXACT ROUTE AND LOCATION
- OF UTILITIES, MATERIALS AND EQUIPMENT BEFORE FABRICATION AND INSTALLATION. H. WHEN EXISTING CONSTRUCTION IS REMOVED, DISTURBED, DAMAGED, REPLACED OR RENOVATED IN ANY WAY, CONTRACTORS SHALL PROVIDE PATCHING, PAINTING AND MATERIALS OF SAME TYPE AND QUALITY AS TO MATCH ADJACENT EXISTING SURFACES, UNLESS OTHERWISE NOTED. I. CONTRACTORS PROVIDE ALL BLOCKING, FURRING AND SHIMMING FOR INSTALLATION AND COMPLETION OF
- ALL NEW WORK SHALL BE PLUMB, LEVEL AND SQUARE. SCRIBE AND MAKE FIT ALL NEW TO EXISTING. K. CONTRACTORS VERIFY ALL DIMENSIONS BEFORE ORDERING MATERIAL OR DOING WORK. NO EXTRA
- COMPENSATION OR CHARGES WILL BE ACCEPTED DUE TO DIFFERENCES BETWEEN THE ACTUAL MEASUREMENTS AND MEASUREMENTS INDICATED ON THE DRAWINGS. L. ALL DETAILS ARE SUBJECT TO CHANGE DUE TO EXISTING FIELD CONDITIONS. CONTRACTOR MUST NOTIFY
- ARCHITECT OF SAME. M. NO SITE VISITS WILL BE MADE BY THE ARCHITECT. THE CONTRACTOR SHALL ASSUME RESPONSIBILITY FOR
- CHANGES TO THESE DRAWINGS AND COMPLETION OF COMPLIANT WORK. ARCHITECT TO COORDINATE ALL DOOR HARDWARE, TRIM AND FINISHES TO MEET INTENT AND COMPLIANCE.
- O. THESE DRAWINGS DO NOT PURPORT TO SHOW ALL ITEMS AND PROCEDURES REQUIRED FOR A COMPLETE INSTALLATION. THE INTENT IS TO INDICATE THE GENERAL SCOPE OF THE PROJECT IN TERMS OF THE GENERAL ARCHITECTURAL DESIGN CONCEPT, THE LOCATION/DIMENSIONS OF THE CONSTRUCTION AND
- MAJOR ELEMENTS OF CONSTRUCTION. P. CONTRACTORS ARE RESPONSIBLE FOR OBTAINING AND PAYING FOR ALL PERMITS ASSOCIATED WITH THE WORK OF THEIR CONTRACT.
- Q. ITEMS NOTED AS 'BY OWNER" ARE TO BE FURNISHED AND INSTALLED BY THE OWNER OR THE OWNER'S

FLOOR PATTERN PLAN GENERAL NOTES

- A. REFER TO I-100 SERIES FOR FINISH PLANS.
- B. ALL FLOOR FINISHES SHALL TRANSITION AT CENTERLINE OF DOOR, UNLESS NOTED OTHERWISE.

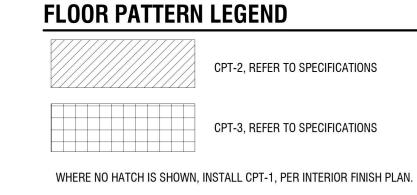

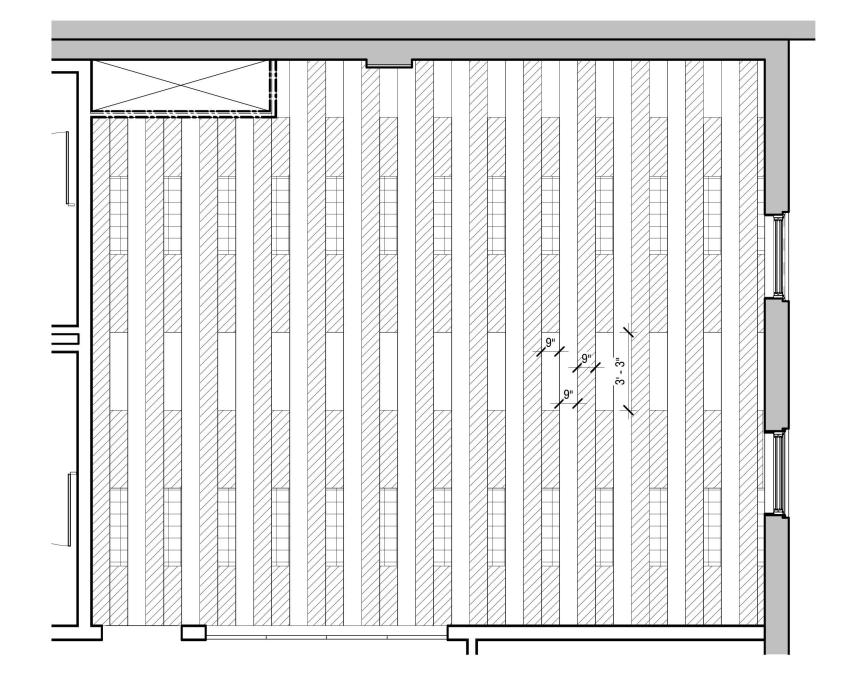

3 LOWER LEVEL - ESPORTS 106 ENLARGED PLAN 1001 SCALE: 1/4" = 1'-0"



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ACADEMIC INNOVATION HUB - WORK FORCE DEVELOPMENT TRAINING

822 CLEVELAND AVENUE NIAGARA FALLS, NEW YORK 14305


NO: DATE: DESCRIPTION: PROJECT NUMBER: 2221723 DRAWN BY: REVIEWED BY: APRIL 11, 2024

> **INTERIOR COLOR AND** FINISH LEGEND & DETAILS

DRAWING NUMBER:

DRAWING NAME:

1001

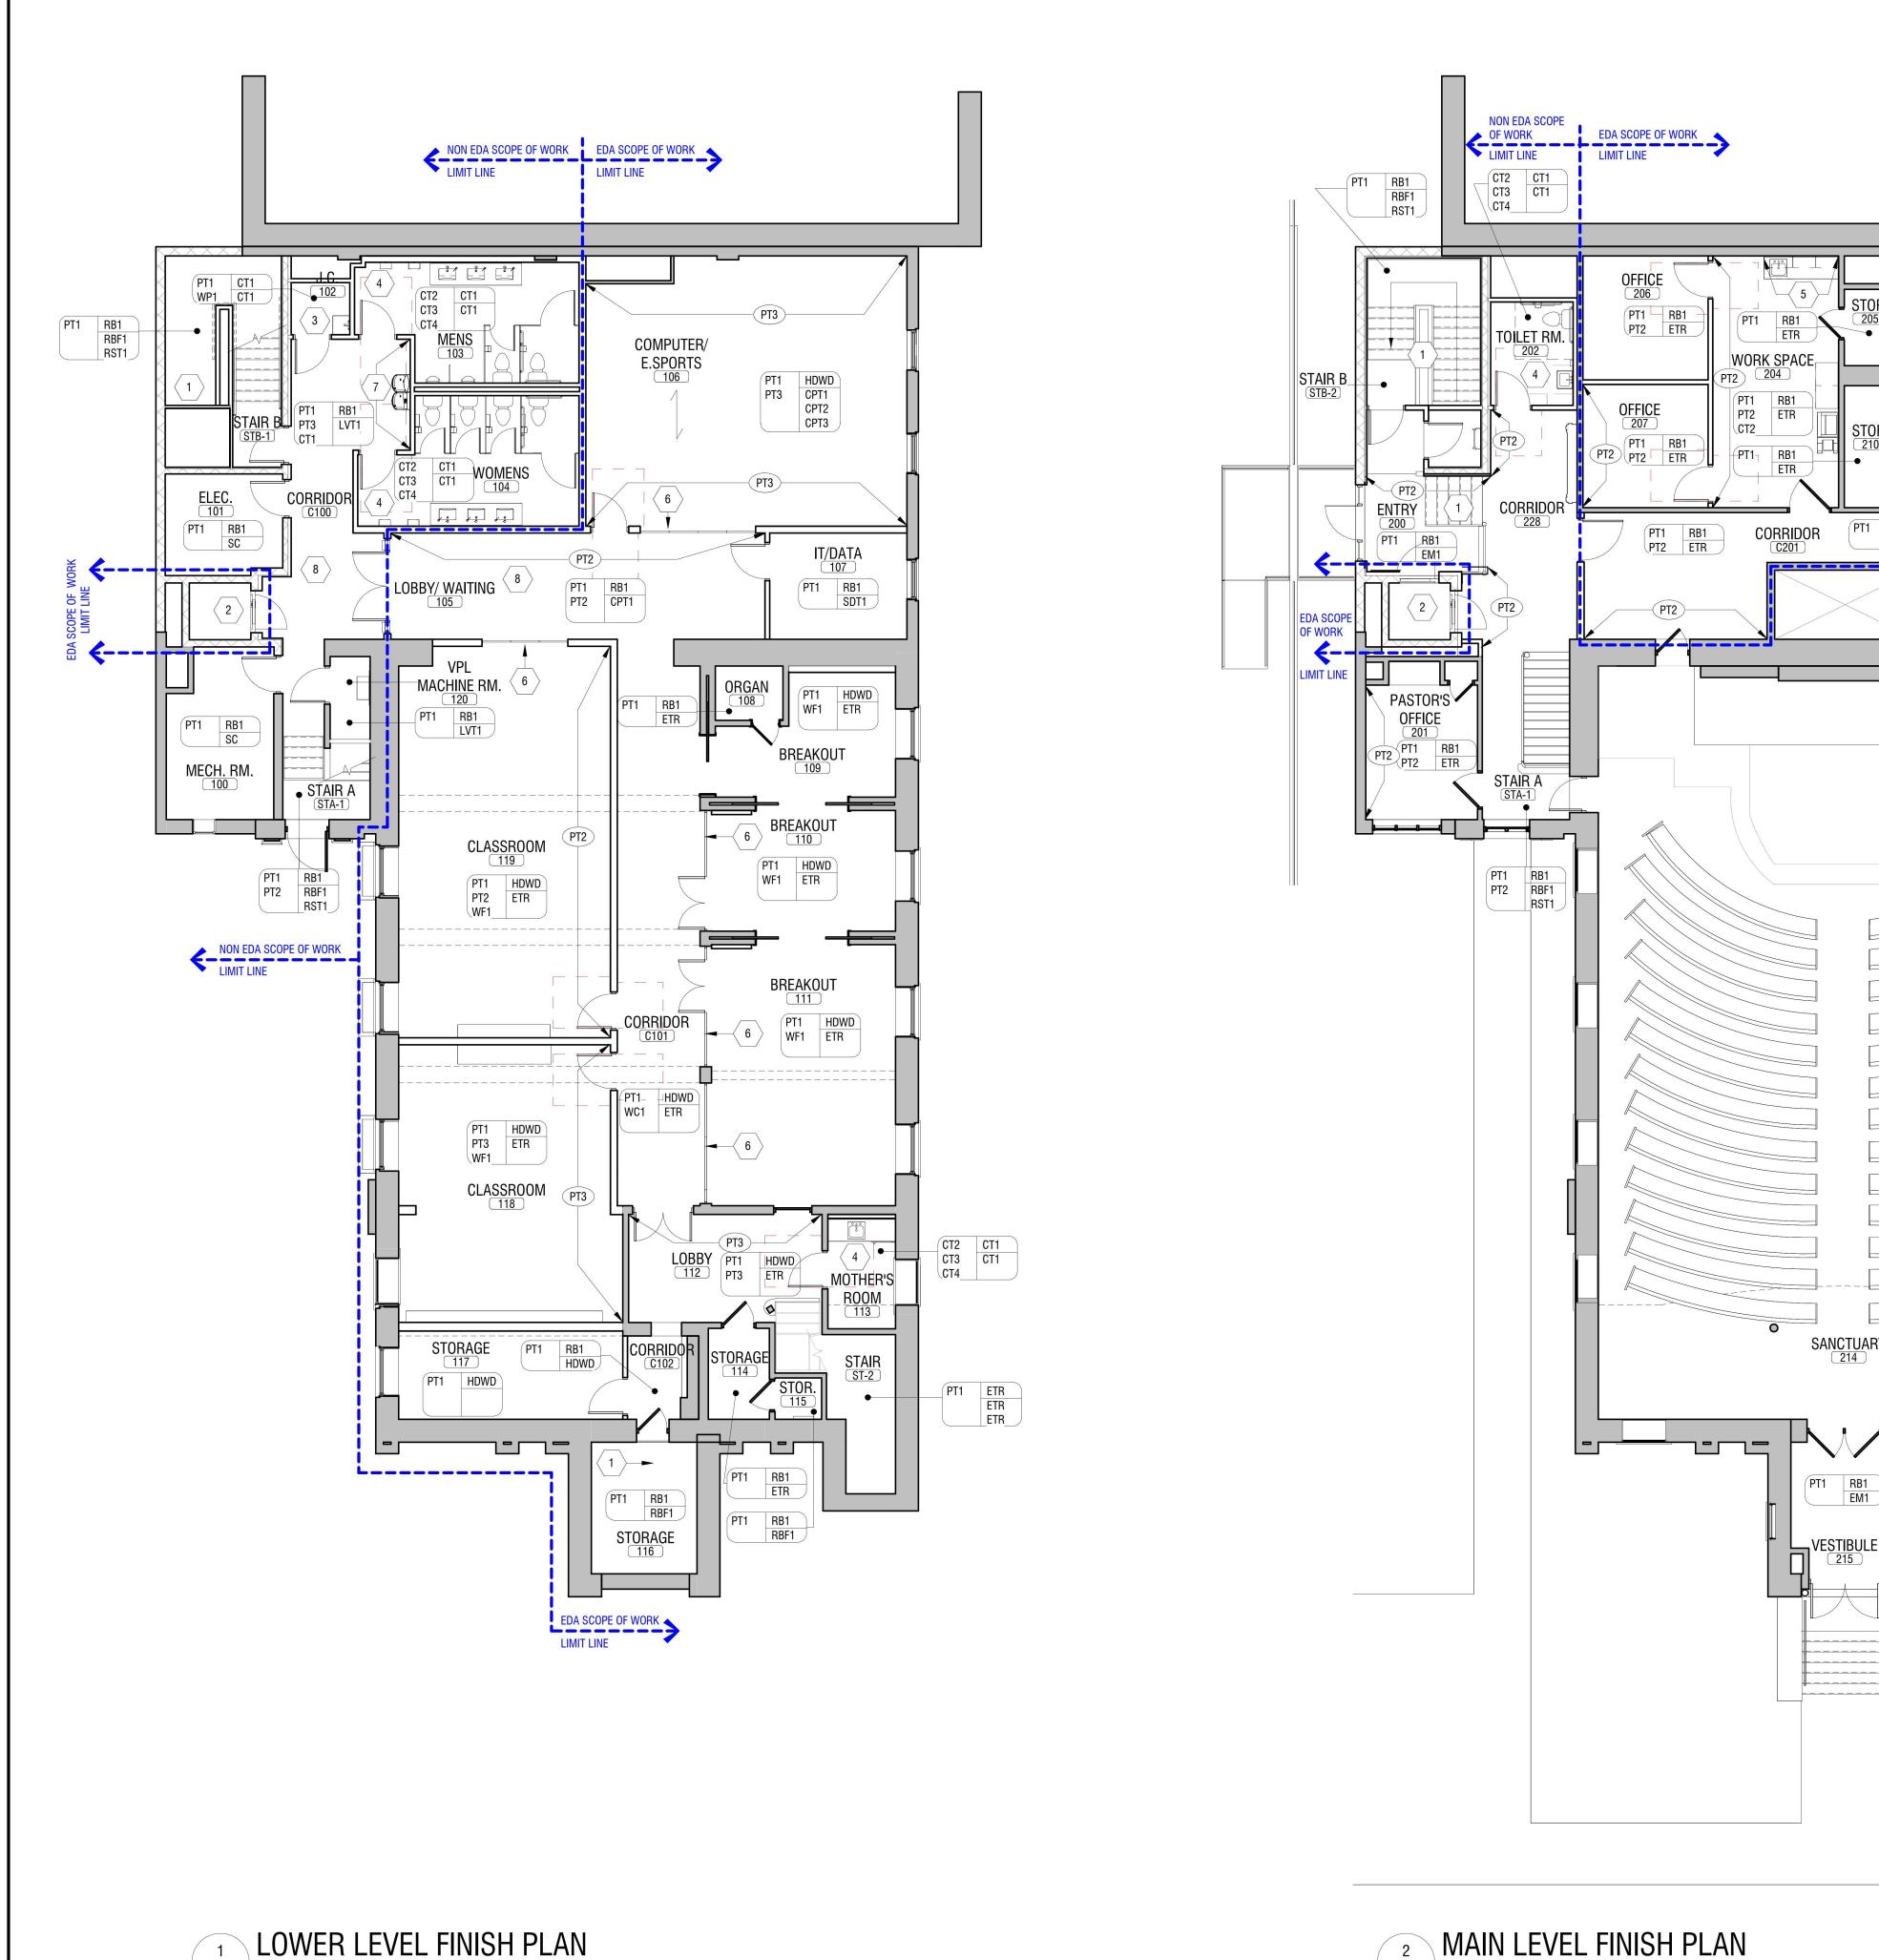

FINISH PLAN GENERAL NOTES

OFFICE 208

PT1 RB1 PT2 ETR PT2

PT1 RB1 PT2 ETR

- A. REFER TO "I" SERIES FOR FLOOR PATTERNING PLANS. B. REFER TO DRAWING I-001 COLOR AND FINISH LEGEND FOR DETAILED INFORMATION
- ON FINISHES AND ABBREVIATIONS.
- C. ALL NEW AND EXISTING HOLLOW METAL DOORS, DOOR FRAMES, AND HOLLOW METAL WINDOW FRAMES WITHIN AREA OF WORK SHALL BE PAINTED PT-4.
- D. ALL EXPOSED COLUMNS TO BE PAINTED PT-2 UNLESS NOTED OTHERWISE. E. ALL LOUVERS, VENTS, GRILLES, AND OTHER MISC. MECHANICAL & ELECTRICAL DEVICES ARE TO BE PAINTED TO MATCH SURFACE ON WHICH THEY APPEAR, UNLESS NOTED
- F. ALL FLOOR FINISHES SHALL TRANSITION AT CENTERLINE OF DOOR, UNLESS NOTED
- G. WHERE NEW FINISHES ARE SCHEDULED AT EXISTING CONDITIONS, REMOVE EXISTING FINISHES AND PREPARE SURFACES FOR NEW FINISH.
- H. PROVIDE SSR-1 AT ALL NEW SILL LOCATIONS THAT ARE NOTED TO RECEIVE SOLID
- I. ALL WOOD FLOORS NOTED ETR TO BE SANDED, PATCHED, AND REFINISHED. J. PROVIDE WT-1 AT ALL EXTERIOR WINDOWS WITHIN SCOPE OF WORK, U.N.O WINDOW TREATMENTS NOT REQUIRED AT SANCTUARY, CORRIDORS, STORAGE ROOMS, STAIRS, IT/DATA, ELECTRICAL, OR TOILET ROOMS.

FINISH SYMBOLS LEGEND & ABBREVIATIONS

WALL FINISH(ES) (* BASE FINISH *FIRST LISTED IS FL00R FIELD FINISH, FINISH(ES) ABOVE FINISH FLOOR CPT CARPET CERAMIC/PORCELAIN TILE **ENTRY MAT** ETR GRT GWB HDWD **EXISTING TO REMAIN** GYPSUM WALL BOARD **HARDWOOD** HIGH PRESSURE LAMINATE RESILIENT BASE RSF RST RUBBER FLOOR TILE RUBBER STAIR TREAD SEALED CONCRETE STATIC DISSIPATIVE TILE SOLID SURFACING TRANSITION STRIP WINDOW FILM WINDOW PROTECTION WINDOW TREATMENT ACCENT WALL FINISH DESIGNATION $-(\overline{XXX})$ (FULL HEIGHT, TYP.)

FINISH PLAN KEYNOTES:

- PROVIDE RST-1 TO STAIR TREADS WITH RSF-1 AT LANDINGS.
 PROVIDE RBF-1 AT LIFT PLATFORM.
- 3. PROVIDE WP-1 TO 4'-0" AFF WITH PT-1 ABOVE, FULL PERIMETER OF ROOM. 4. PROVIDE CERAMIC WALL TILE FULL HEIGHT ALL WALLS. INSTALL TILE AS SHOWN ON 1/1001

CARPET DIRECTION

- AT SINK WALLS AND CT2 IN RUNNING BOND PATTERN ALL REMAINING WALLS. 5. PROVIDE CT-2 BACKSPLASH FROM TOP OF COUNTER TO UNDERSIDE OF WALL CABINETS.
- 6. PROVIDE WF-1 TO GLASS PANEL OF SALVAGED WOODWORK.
- . PROVIDE CT-1 IN VERTICAL RUNNING BOND PATTERN, FULL HEIGHT OF WALL.
- 8. INSTALL SPECIFIED CARPET IN ASHLAR PATTERN WITH LONG EDGE OF TILE PATTERN TO DIRECTION OF ARROWS.

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EDA PROJECT No. 01-01-15369 HUD PROJECT No. B-23-CP-NY-1083 NEW YORK
STATE OF OPPORTUNITY.
Development

ACADEMIC INNOVATION HUB - WORK FORCE DEVELOPMENT TRAINING

822 CLEVELAND AVENUE NIAGARA FALLS, NEW YORK 14305

NO: DATE: DESCRIPTION: PROJECT NUMBER: 2221723 DRAWN BY: REVIEWED BY: APRIL 11, 2024

> **LOWER LEVEL & MAIN LEVEL FINISH PLANS**

DRAWING NUMBER:

DRAWING NAME:


MAIN LEVEL FINISH PLAN | I101 | SCALE: 1/8" = 1'-0"

GENERAL NOTES:

-SLAB REMOVED SEE ARCH

- A. NOT ALL PIPING AND ACCESSORIES SHOWN FOR CLARITY. CONTRACTOR SHALL VISIT SITE TO DETERMINE THE EXTENT OF REMOVALS.
- B. DO NOT DISTURB EXISTING HAZARDOUS MATERIALS. DO NOT PROCEED WITH REMOVALS UNTIL HAZARDOUS MATERIAL ABATEMENT COMPLETE.
- C. PATCH ALL UNUSED OPENING LEFT BEHIND FROM REMOVALS TO MATCH EXISTING

- REMOVE BOILERS, CONTROLS, BREECHING, PIPING AND ALL ACCESSORIES.
- REMOVE ALL STEAM MAINS AND BRANCH PIPING IN BUILDING INCLUDING HANGER AND ACCESSORIES. DISCONNECT FROM RADIATORS.REMOVE HANGERS, PATCH WALLS, FLOORS AND CEILINGS TO MATCH EXISTING. VERIFY IN FIELD AMOUNT OF PIPING.
- 3. REMOVE BOILER BREECHING TO CHIMNEY. PATCH CHIMNEY AIRTIGHT TO MATCH EXISTING.
- 4. REMOVE BOILER FEED UNIT, PUMPS CONTROLS AND PIPING.
- 5. REMOVE CONDENSATE RECEIVER, PUMP CONTROLS AND PIPING.
- 6. REMOVE ALL CONDENSATE PIPING AND STEAM TRAPS AND FROM BUILDING. DISCONNECT FROM RADIATORS. REMOVE HANGERS. PATCH WALLS, FLOORS AND CEILINGS TO MATCH EXISTING. VERIFY IN FIELD AMOUNT OF PIPING.
- 7. CAREFULLY REMOVE RADIATOR PIPING AND SUPPORTS IN ITS ENTIRETY WITHOUT DAMAGE. STORE RADIATORS IN PROTECTED LOCATION UNITL RADIATOR RETROFIT IS COMPLETE AND OPERATIONAL. DISPOSE OF UNUSED RADIATORS AT END OF JOB.
- 8. REMOVE PIPING TO RADIATOR. REMOVE AIR VENT ON RADIATOR AND PLUG OPENING. EXISTING RADIATOR SHALL REMAIN IN PLACE AND BE REUSED. REMOVE HAND VALVES AND UNION ELBOWS. UNITS SHALL BE CONVERTED TO HOT WATER USE.
- 9. REMOVE EXISTING EXHAUST FAN AND CONTROLS. PATCH OPENING TO MATCH EXISTING.
- 10. BLOWER, DUCTWORK, AIR CHEST, AND CONTROLS FOR PIPE ORGAN SHALL REMIAN INTACT. PROTECT DURING CONSTRUCTION.
- 11. REMOVE FLOOR GRILLE, PLENUM AND ALL UNDER FLOOR DUCTWORK.
- 12. WALL GRILLE SHALL REMAIN. REMOVE UNDERFLOOR DUCT AND CAP ANY DUCTWORK LEFT IN WALL. PROVIDE BLANK OFF PANELS BEHIND GRILLES.
- 13. REMOVE CEILING GRILLE. PATCH CEILING TO MATCH EXISTING.
- 14. REMOVE ABANDONED FLUE TO CHIMNEY. SEAL WALL AIR TIGHT AND PATCH TO MATCH EXISTING.
- 15. REMOVE VENTILATION DUCT FROM BELOW FLOOR TO CEILING. CAP CEILING DUCT AIR TIGHT. PATCH FLOOR TO MATCH EXISTING.

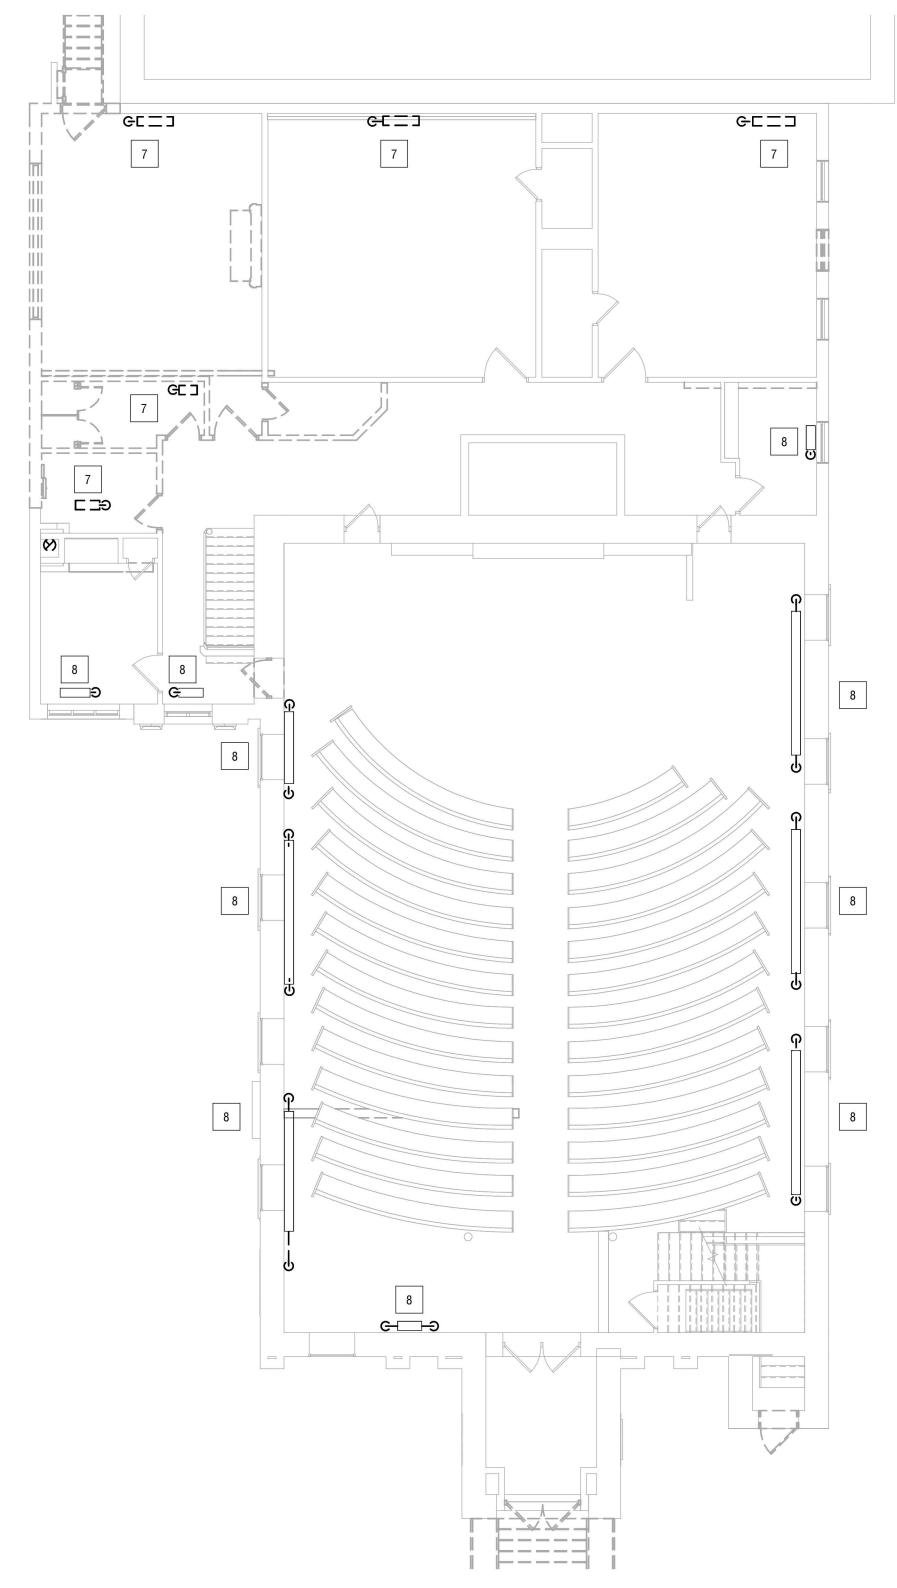





1 FIRST FLOOR MECHANICAL REMOVAL PLAN





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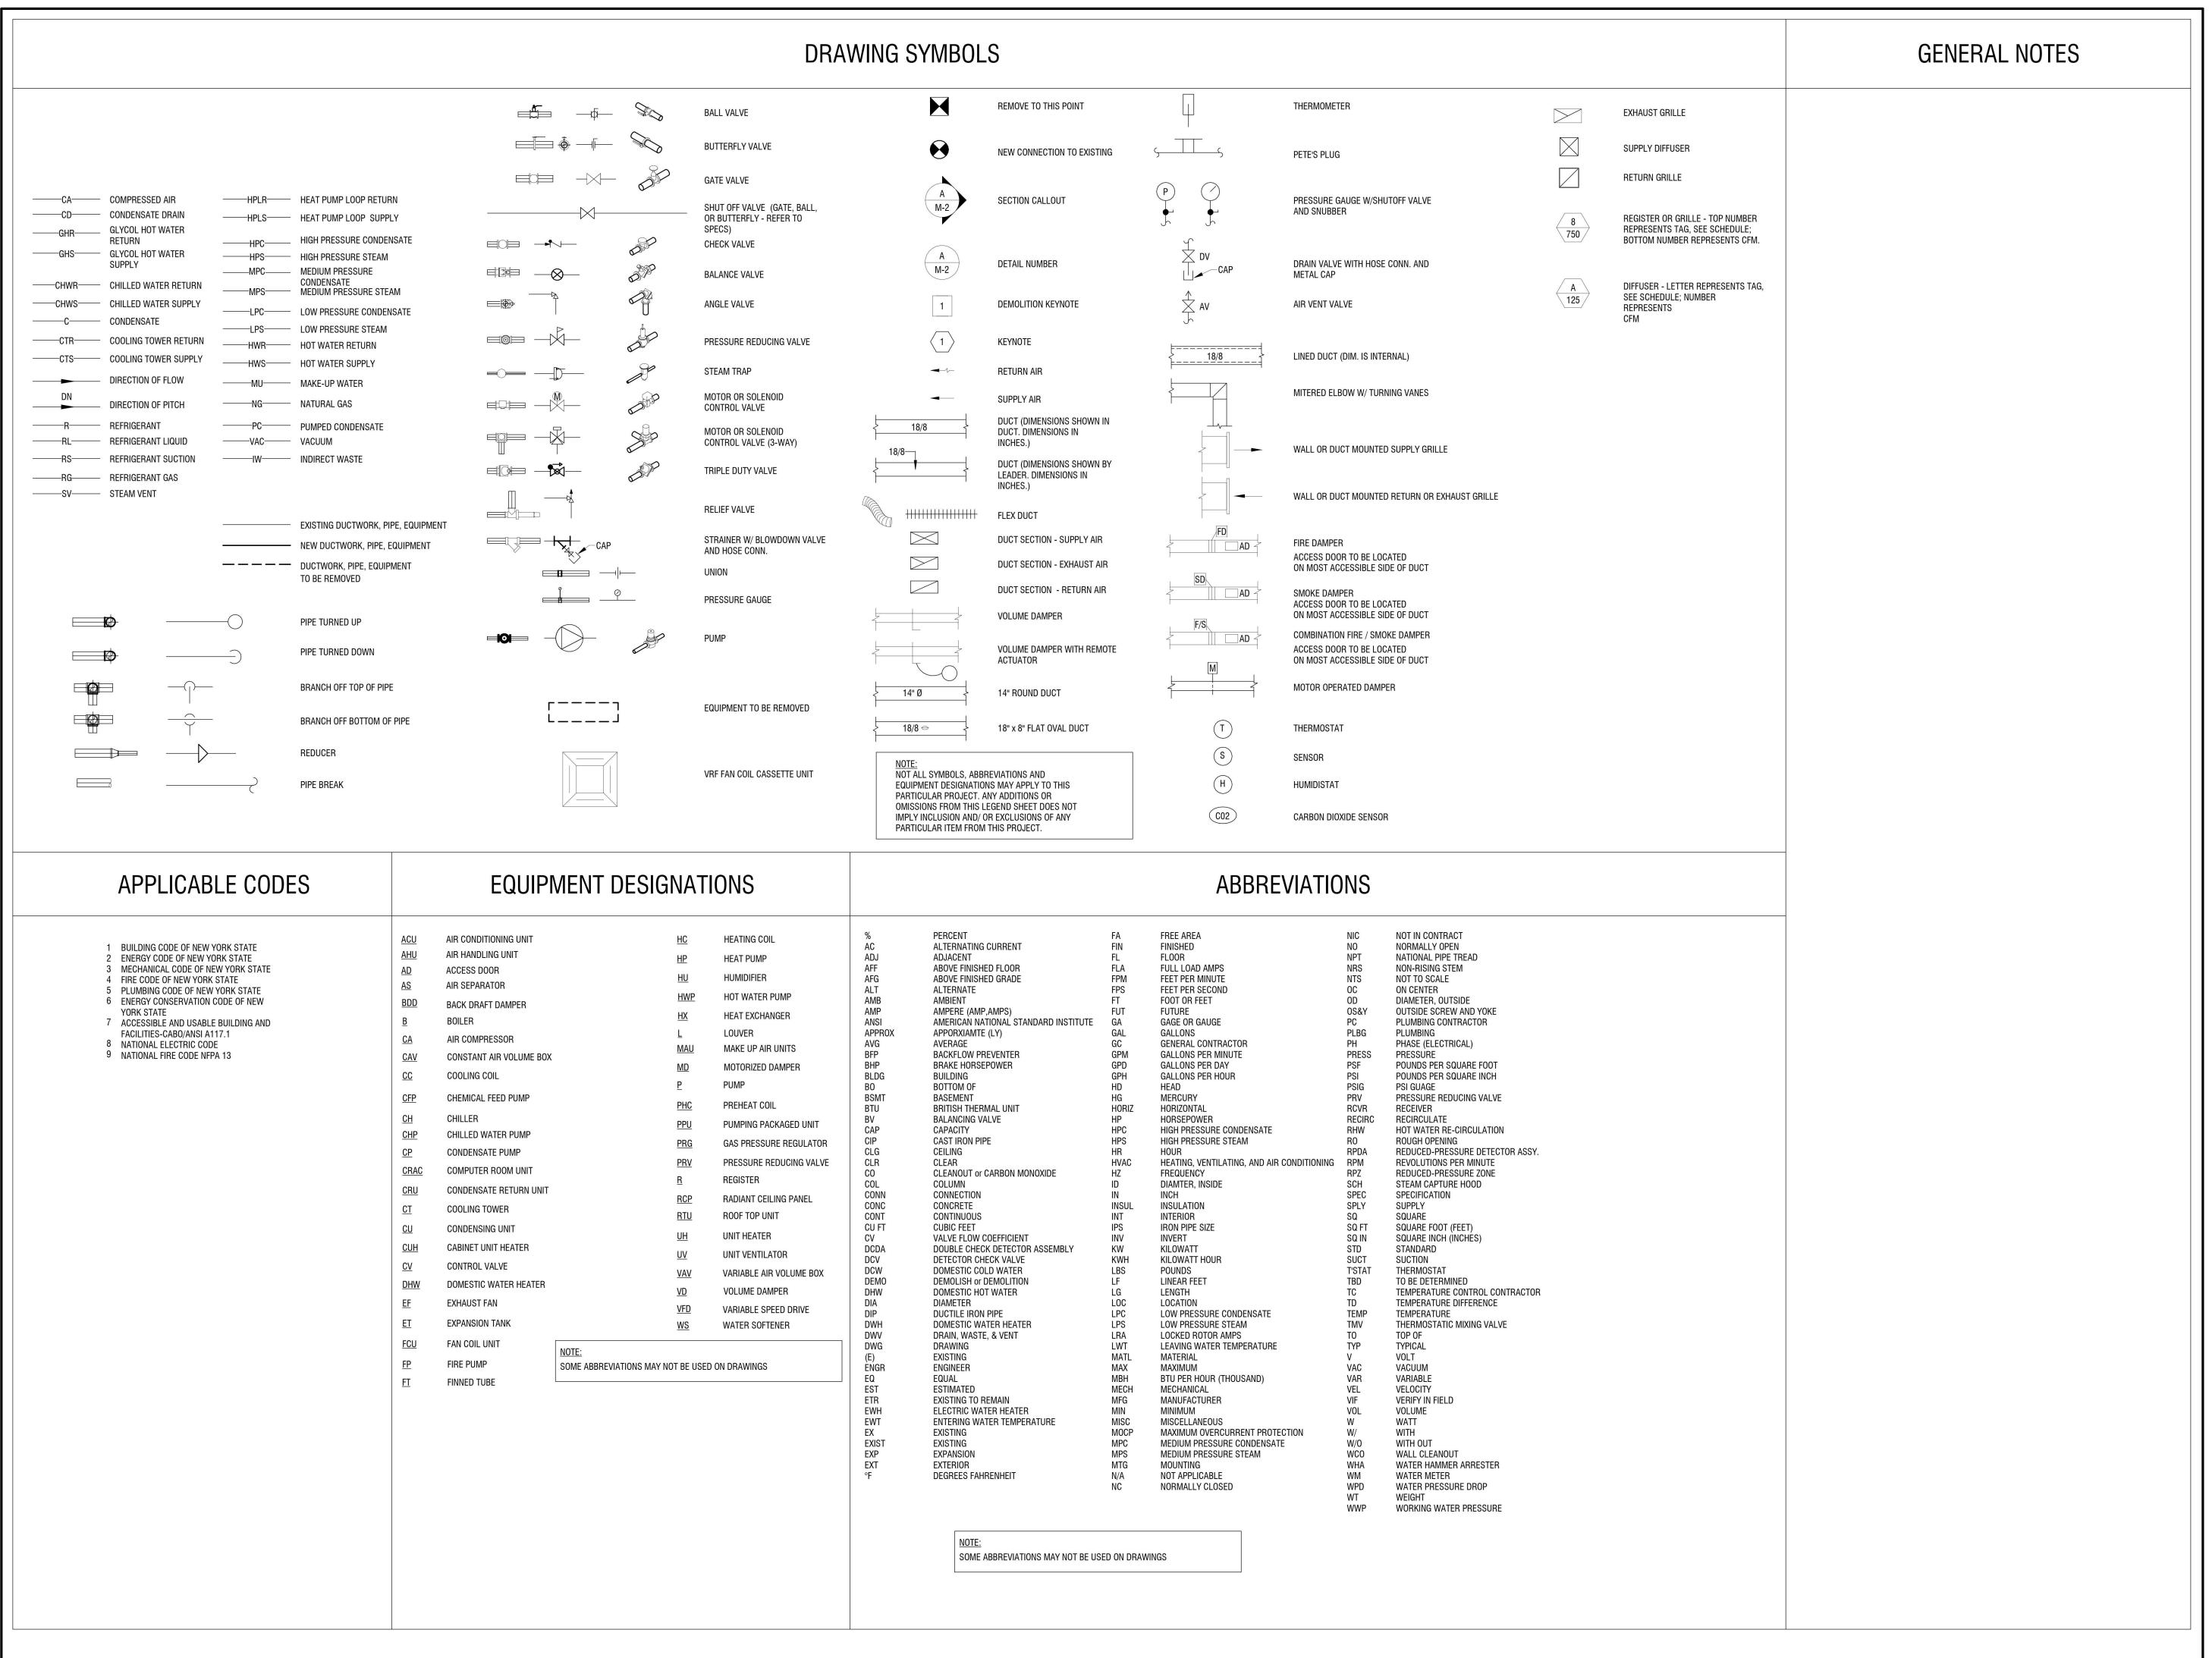
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Revisions		
PROJECT NU	JMBER:	
		2221723
DRAWN BY:		KMK
REVIEWED BY:		JSN
ISSUED FOR	:	BID
DATE:		APRIL 11, 2024

MECHANICAL REMOVAL PLANS

DRAWING NUMBER:

DRAWING NAME:

MD101





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AZS LIABAN DEVELOR

EDA PROJECT No. 01-01-15369 HUD PROJECT No. B-23-CP-NY-1083



ESD PROJECT No. 135 035

ACADEMIC INNOVATION HUB - WORK FORCE DEVELOPMENT TRAINING

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NO: DATE: DESCRIPTION:

Revisions

PROJECT NUMBER: 2221723

DRAWN BY: KMK

REVIEWED BY: JSN

ISSUED FOR: BID

DATE: APRIL 11, 2024

MECHANICAL LEGEND SHEET

DRAWING NUMBER:

DRAWING NAME:

M001

GENERAL NOTES:

M101 1/8" = 1'-0"


A. OFFSET PIPING TO MISS EXISTING BEAMS IN CEILING AND WORK OF OTHER TRADES.

KEYED NOTES (#)

- 1. RUN HWS THROUGH EXISTING HOLE IN FLOOR. CONNECT TO RADIATOR AT LOCATION OF REMOVED, PROVIDE SELF CONTAINING CONTROL VALVE AND BRASS/BRONZE THREADED BALL VALVE. FIRE STOP HOLE THROUGH FLOOR. PROVIDE ESCUTCHEON AROUND PIPE AT FLOOR. INSULATE PIPING AND COVER INSULATION WITH GLUED PVC JACKET.
- 2. RUN HWR THROUGH EXISTING HOLE IN FLOOR. ENLARGE OPENING AS REQUIRED. CONNECT TO RADIATION AT LOCATION OF REMOVED PIPE WITH NIPPLE, UNION, AND BRASS/BRONZE BALANCING VALVE. FIRE STOP HOLE THROUGH FLOOR. PROVIDE ESCUTCHEON AT FLOOR. INSULATE PIPING AND COVER INSULATION WITH GLUED PVC JACKET. PROVIDE COIN VENT. DRILL AND TAP RADIATOR AT HIGH POINT ON BLANK BOSS.
- 3. PROVIDE RADIANT FLOOR "STAPLE UP" SYSTEM UNDER FLOOR AS OUTLINED. PIPING SHALL RUN ABOVE SUPPORT BEAMS WITHOUT CAVITY. SEE SCHEDULE RADIANT 70NF 1
- 4. 3/4" PUMPED CONDENSATE, DRAIN TO GRAVITY DRAIN. MOUNT PUMP ABOVE CEILING.
- 5. MOUNT RADIANT SYSTEM MANIFOLD IN CABINET NEAR CEILING MOUNT NEAR CORNER OF THE ROOM FOR STAPLE UP SYSTEM.
- 6. MOUNT RADIANT PANEL MIXING AND CIRCULATING PUMPS ON WALL.
- 7. RUN REFRIGERANT PIPING ABOVE STAIR CEILING. AVOID ROOF ACCESS HATCH AND RUN REFRIGERANT PIPING UP TO CONDENSING UNIT VIA PIPE PORTAL.
- 8. RUN REFRIGERANT PIPING FROM FIRST FLOOR MODE CONTROL UNIT (MCU) DOWN TO BASEMENT MCU INSIDE OF WALL.
- 9. RUN 3/4" HWS AND HWR DOWN WALL. BRANCH PIPE AND CONNECT TO EACH CONVECTOR.
- 10. MCU LOCATED ABOVE CEILING. RUN REFRIGERANT LINES IN TRUSS SPACE AND DROP TO MCU. LINE SIZES PER DETAIL. MAINTAIN 10" OVERHEAD CLEARANCE,

M101 1/8" = 1'-0"


- 11. MCU LOCATED ABOVE CEILING. MAINTAIN 10" OVERHEAD CLEARANCE. MAINTAIN SIDE CLEARANCES PER MANUFACTURER. SEE DETAILS FOR REFRIGERANT LINE SIZES.
- 12. PROVIDE CONDENSATE CONNECTION TO DRAIN BEHIND WALL PER DETAIL. COORDINATE WITH PLUMBER.
- 13. CORE DRILL STONE WALL FOR NEW PIPING,
- 14. TERMINATE CONDENSATE DRAIN PER DETAIL BEHIND ACCESS DOOR. COORDINATE WITH PLUMBER.
- 15. PROVIDE 3/4" CD DOWN WALL. COMBINE TWO CONDENSATE DRAINS INTO ONE CONNECTION. TERMINATE CONDENSATE DRAIN BEHIND ACCESS DOOR PER DETAIL.
- 16. RUN HWS AND HWR MAINS UNDER EXISTING BEAMS AND EXPOSED IN SPACE.
- 17. RUN PIPING IN SOFFIT IN IT/DATA ROOM.
- 18. RUN REFRIGERANT PIPING IN SOFFIT COORDINATE WITH ALL TRADES.
- 19. HW CONTROL VALVE UNDER FTR COVER.

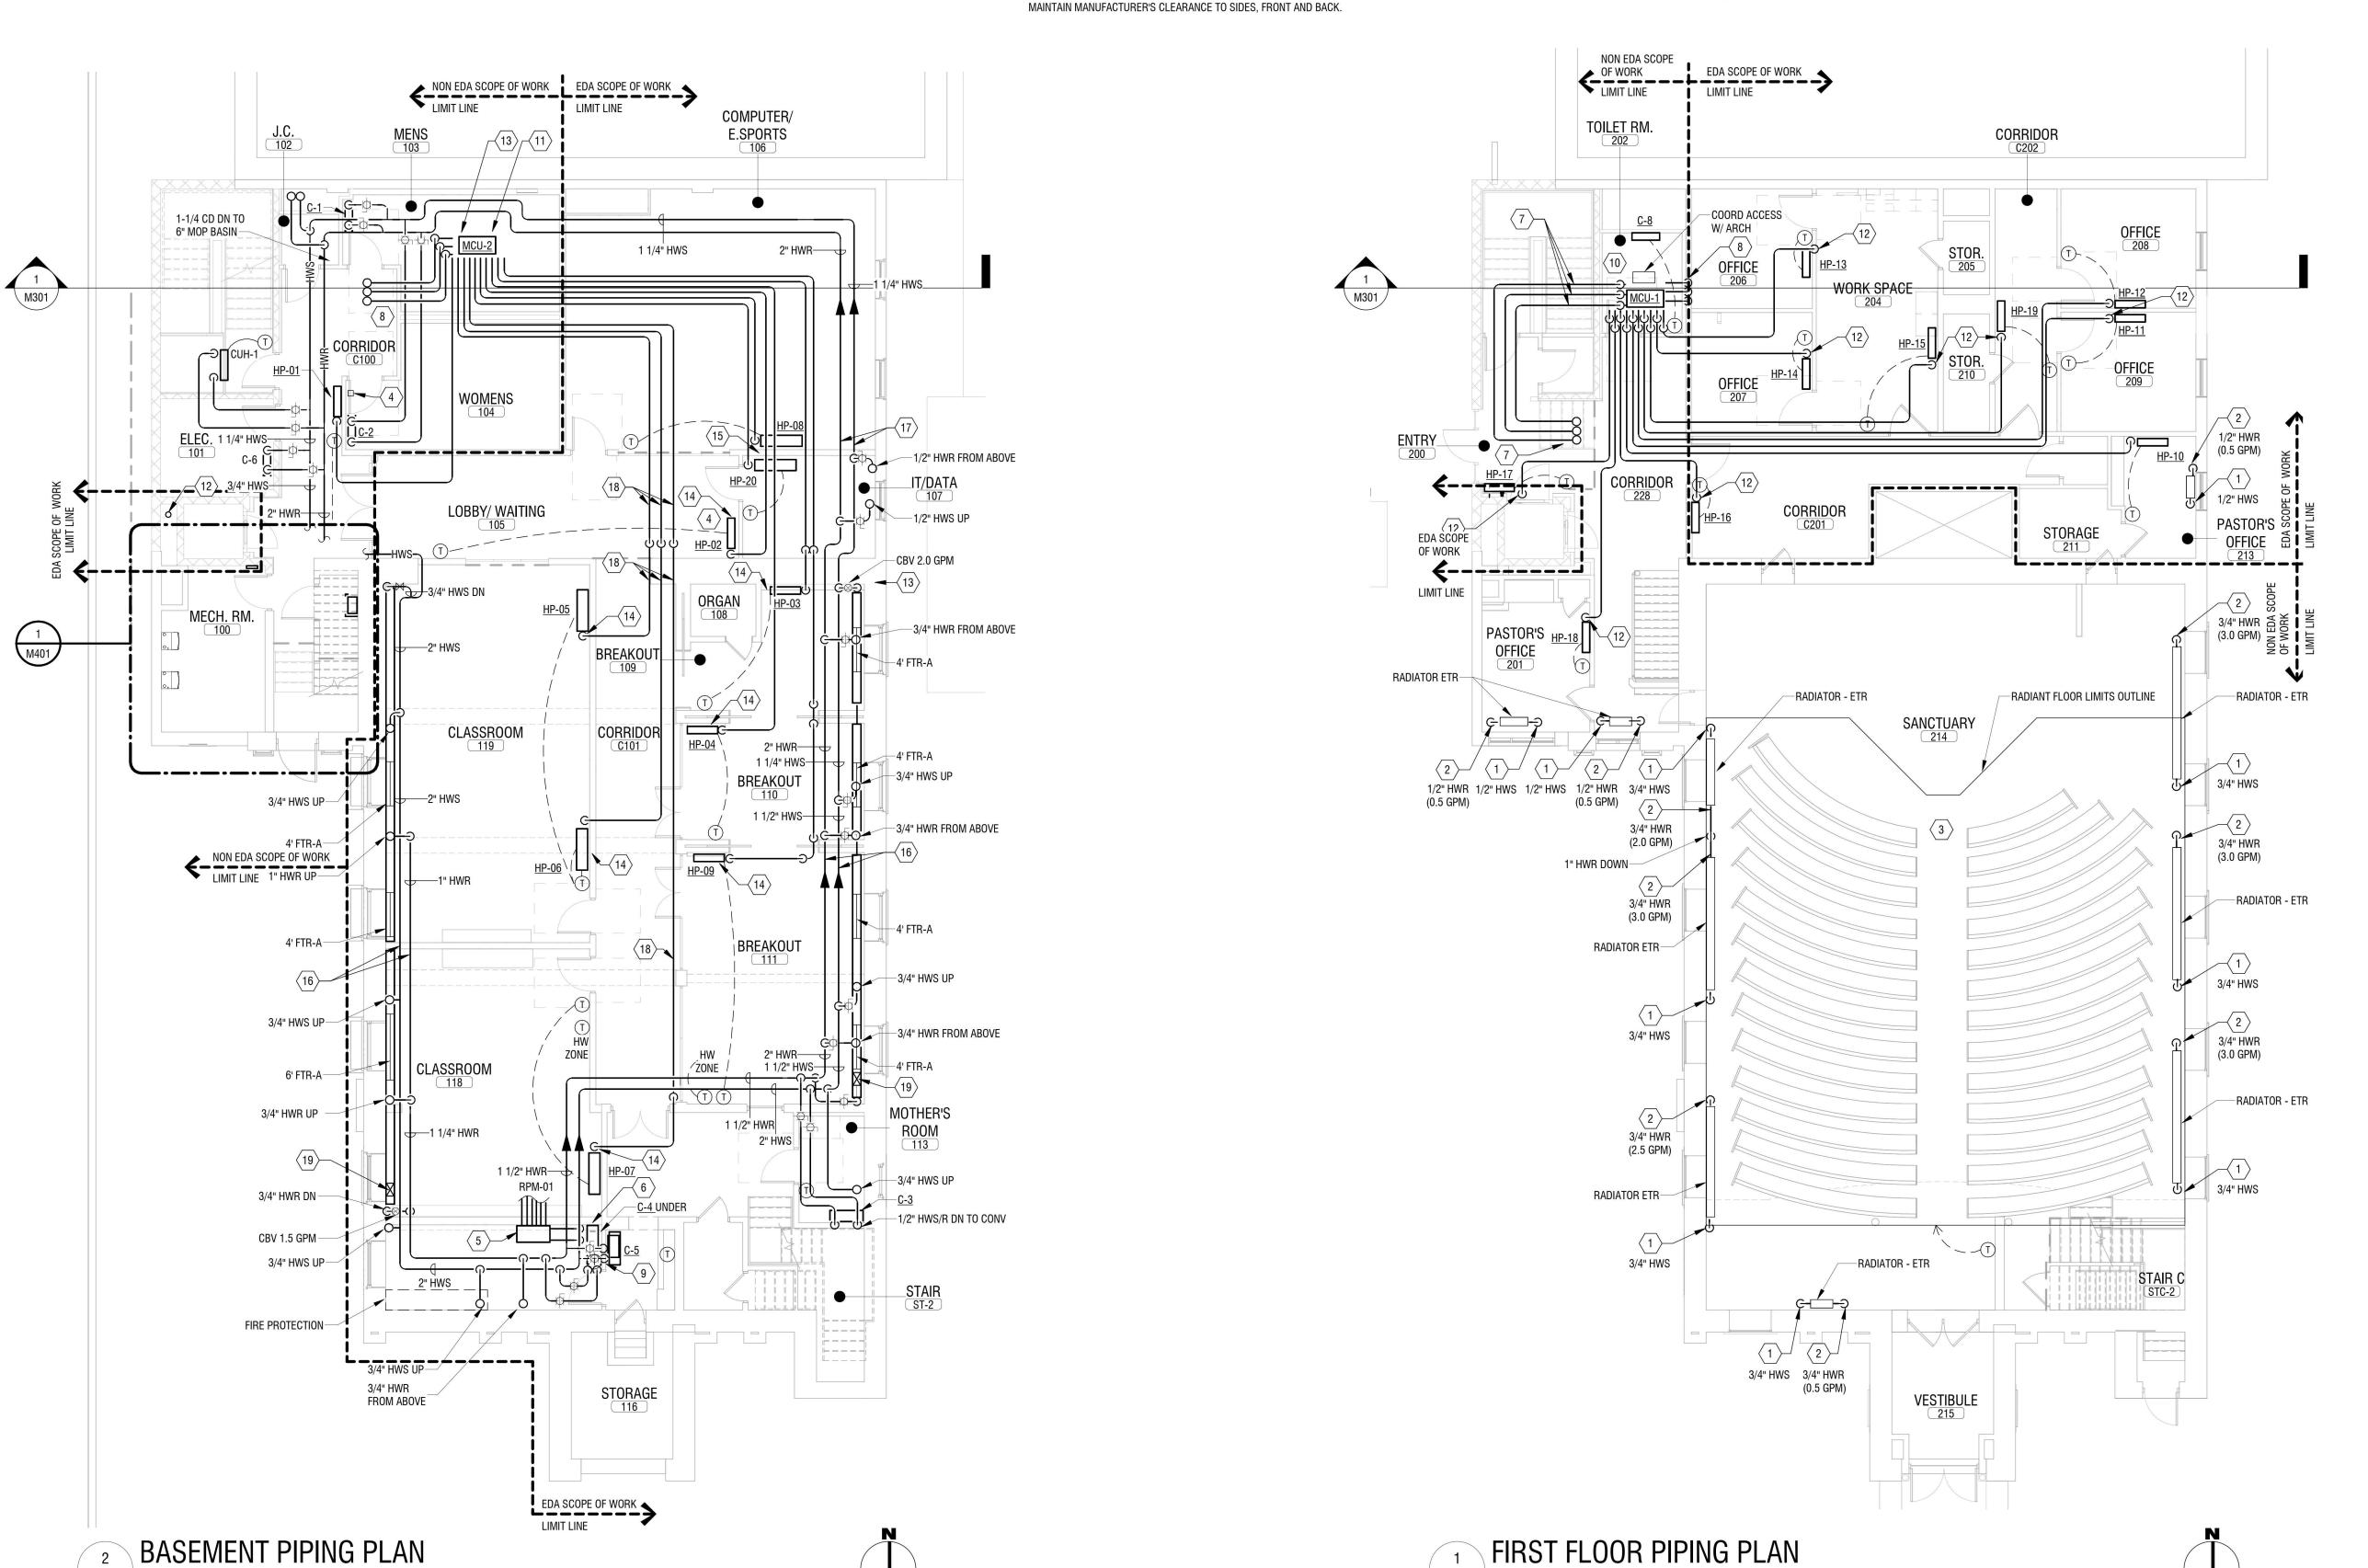



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ESD PROJECT No. 135,035

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PROJECT N	NUMBER:	2221723	
DRAWN BY	′ :	KMK	
REVIEWED BY:		JSN	
ISSUED FO	R:	BID	
DATE:		APRIL 11, 2024	

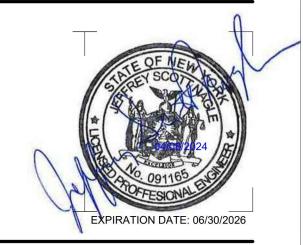MECHANICAL PIPING PLAN

DRAWING NUMBER:

DRAWING NAME:

M101